
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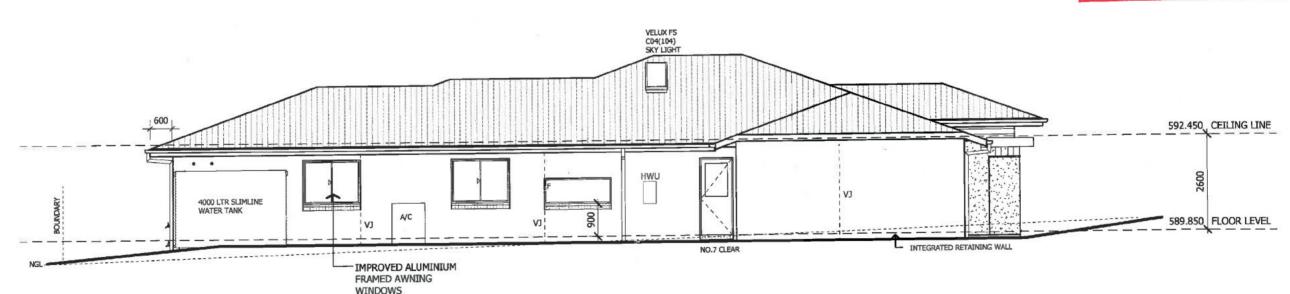
ELEVATION 3

BUILDING APPROVAL Issued under section 28 of the Building Act 2004 Certifled Building Solutions Pty Ltd

1 8 AUG 2014



Licence No: 200426203

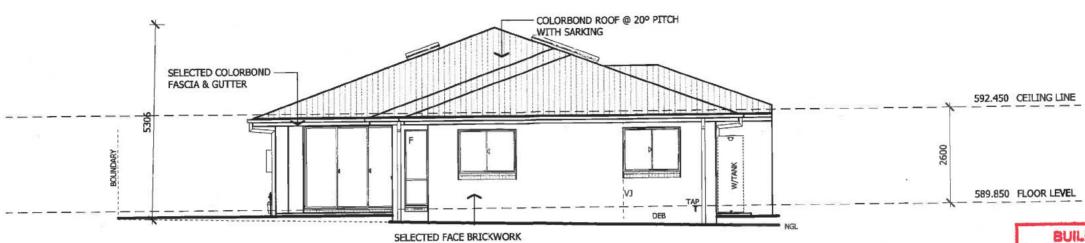

ELEVATION 4

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RAWSON HOMES

6A, LVL 1, 2 BRINDABELLA PARK Cct BRINDABELLA PARK, ACT 2609 TELEPHONE 02 6225 8400 FAX 02 6257 1982 Builder's licence No. 33493C

CLIENT: Sch 2 2.2(a)(ii)

SITE ADDRESS: BLOCK 12, SECTION 80 18 DIGBY CIRCUIT CRACE A.C.T.

HOUSE TYPE
MODEL:

EDEN 27 MAJESTIC FACADE:

SPECIFICATION: LUX DRAWING TITLE: **ELEVATIONS 3-4**


DRAWN BY: DATE DRAWN: CHECKED BY: APPROVED FOR CONSTRUCTION: SCALE: COUNCIL AREA:

1:100 **ESDD**

ISSUE: DRWG No: JOB No: 5 J003821

INSULATION:

- R5.0 TO CEILINGS (EXCLUDING CEILING OVER PORCH)
- R2.0 TO EXTERNAL & INTERNAL WALLS
- PROVIDE DAMPER SEALS TO ALL EXHAUST FANS
- REFLECTIVE FOIL SARKING UNDER ROOF & TO EXTERNAL WALLS

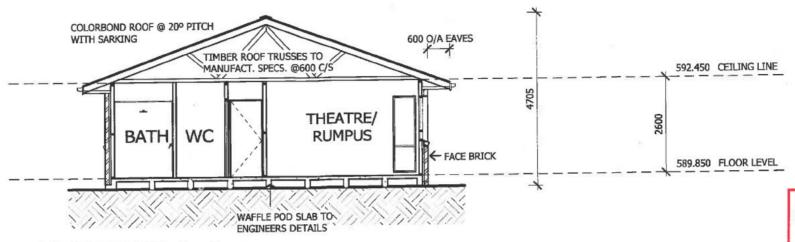

SECTION A-A


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1 8 AUG 2014



Licence No: 200426203



1:50

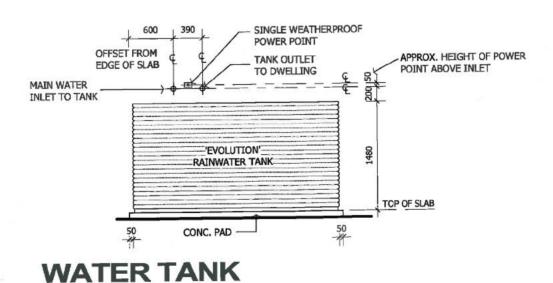NOTES:

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BRINDABELLA PARK ACT 3000 TELEPHONE 02 6225 8400 FAX 02 6257 1982 Builder's licence No. 33493C

CLIENT: Sch 2 2.2(a)(ii)

SITE ADDRESS: BLOCK 12, SECTION 80 18 DIGBY CIRCUIT CRACE A.C.T.


HOUSE TYPE MODEL: EDEN 27		2778772	16.07.14 CHECKED	D BY: APPROVED FOR CONSTRUCTION:
FACADE: TYPE: SPECIFICATION:	MAJESTIC	COUNCIL AREA: ESDD	SCALE:	As Indicated
SECTION		JOB No: J003821	L DRWG	No: ISSUE:

LAUNDRY / WC

- * PROVIDE SKIRTING TILE TO PERIMETER WALLS OF LAUNDRY
- * TILED SPLASHBACK OVER LAUNDRY TUB & BENCH @ 300MM HIGH

BATHROOM / ENSUITE

- * PROVIDE FLOOR TO CORNICE TILING TO ENSUITE & BATHROOM WITH SKIRTING TILE TO PERIMETER WALL OF WC
- GRANGE SEMI FRAMELESS SHOWER SCREEN WITH PIVOT DOOR @ 2100 HIGH.
- PROVIDE KICKER TO BATH HOB 140H X 70W
- * FLOATING VANITIES.
- * WALL MOUNTED TAPS & SPOUT TO VANITIES & BATH

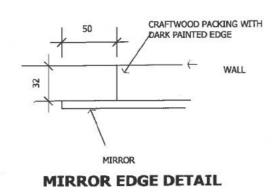



←NOTE: 130MM REVEALS ALUM. ANGLE STOP WALL TILE INTO REVEALS 0 0 NOTE: NO BOTTOM REVEAL CERAMIC TILING OVER WATERPROOFING ON WCDNIW OT FC SHEETING RECESS FORMED IN FRAMING FRAMED HOB TILED SKIRTING ACCESS GRILLE IN CEILING UNDER WASTE WHEN POSSIBLE




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SECTION THROUGH BATH



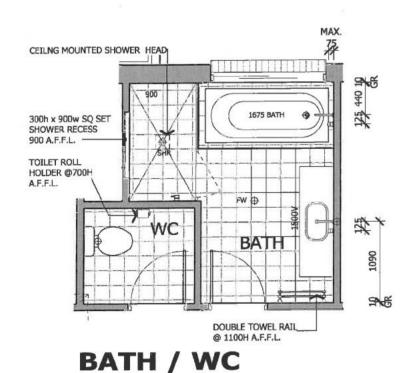

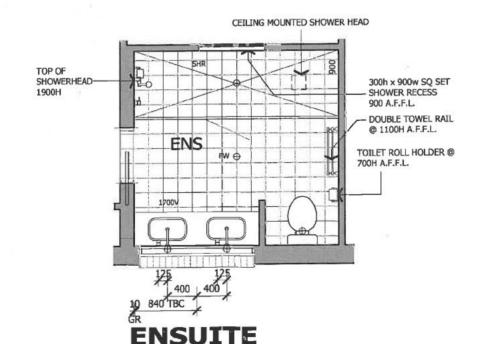

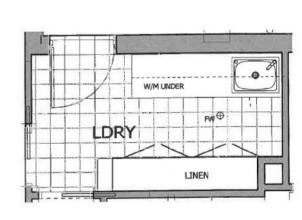LAUNDRY

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CLIENT: Sch 2 2.2(a)(ii)

SITE ADDRESS: BLOCK 12, SECTION 80 18 DIGBY CIRCUIT CRACE A.C.T.

HOUSE TYPE

EDEN 27 MODEL: **MAJESTIC** FACADE:

TYPE:

SPECIFICATION: LUX

DRAWING TITLE: WET AREA DETAILS **ESDD** JOB No:

DRAWN BY: DATE DRAWN: CHECKED BY: APPROVED FOR CONSTRUCTION: TLE 16.07.14 SCALE: COUNCIL AREA: As indicated ISSUE:

DRWG No: J003821

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SCHEDULE OF DRAWINGS:

SHEET	CONTENTS
1	COVER SHEET
2	SITE PLAN
3	FLOOR PLAN
4	ELEVATIONS 1-2
5	ELEVATIONS 3-4
6	SECTIONS
7	WET AREA DETAILS

ISS	DESCRIPTION	BY	DATE
Α	APPLICATION PLAN VARI - 30	TLE	08.05.14
В	SUBMISSION PLAN VARI - 56	TLE	12.06.14
C	REVISED SUBMISSION PLANS. VARI-64	TLE	16.07.14
-			
_			
	-		_

AMENDMENTS

SUBMISSION PLAN

DRAWN BY: DATE DRAWN: CHECKED BY: APPROVED FOR CONSTRUCTION: TLE 16.07.14

ESDD

SCALE: COUNCIL AREA:

ISSUE: JOB No: DRWG No: J003821

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ACT B/L #. 19936252 & NSW B/L #. 33493C

CLIENT: Sch 2 2.2(a)(ii)

SITE ADDRESS: BLOCK 12, SECTION 80 18 DIGBY CIRCUIT CRACE A.C.T.

DRAWING TITLE: **COVER SHEET**

SPECIFICATION: LUX

HOUSE TYPE

MODEL:


FACADE:

TYPE:

EDEN 27

MAJESTIC



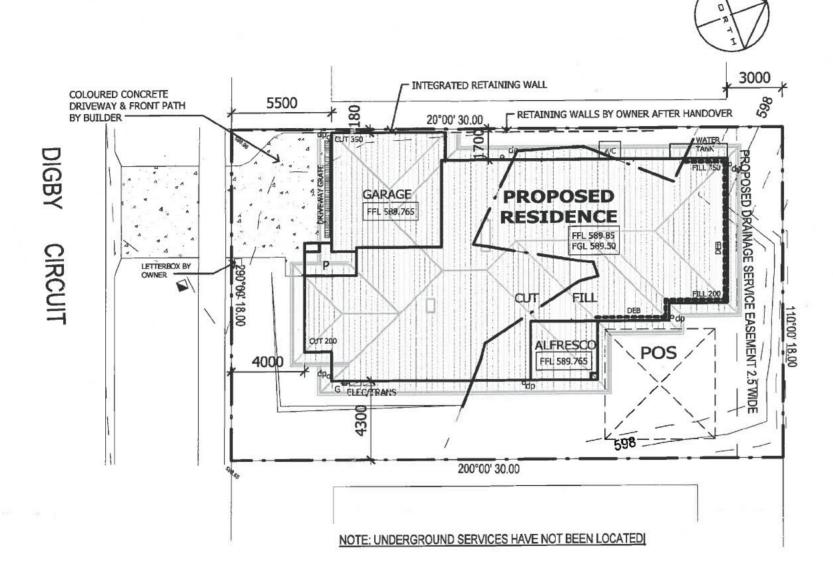

SITE NOTES:

dpo INDICATES DOWNPIPE LOCATION

THE DEVELOPMENT WILL COMPLY WITH THE ACT ENVIRONMENT PROTECTION AUTHORITY, ENVIRONMENT PROTECTION GUIDELINES FOR CONSTRUCTION & LAND DEVELOPMENT IN THE ACT, 2007.

THE DEVELOPMENT WILL COMPLY WITH RULE R50 OF SINGLE DWELLING BUILDING CODE & A MINIMUM OF 50% OF THE PRIVATE OPEN SPACE WIL BE REAINED AS PLANTING AREA.

METAL ROOFING AND/OR METAL WALLING IS TO BE PAINTED OR PRE-COLOURED OTHER THAN IN WHITE OR OFF-WHITE.

THIS DEVELOPMENT ACHIEVES 54% REDUCTION IN MAINS WATER CONSUMPTION COMPARED TO AN EQUIVALENT DEVELOPMENT CONSTRUCTED IN 2003, USING THE ACTPLA ONLINE ASSESSMENT TOOL.

BUILDING APPROVAL

Issued under section 28 of the Building Act 2004 Certified Building Solutions Pty Ltd

1 8 AUG 2014



Licence No: 200426203

FLOOI	RAREAS
PORCH	4.43 m²
GARAGE	37.82 m²
LIVING	196.86 m ²
ALFRESCO	11.50 m ²
TOTAL	250.61 m ²

POS CALCULAT	TIONS
SITE AREA	540.00m ²
BOS REQUIRED	274.00m ²
BOS ACHIEVED	305.32m ²
DOS DECLITRED	54 00m

540.00m ²
274.00m ²
305.32m ²
54.00m ²
105.00m ²

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NOTES:

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RAWSON HOMES

RICHARD ULRICH SCHNEIDER REGISTERED SURVEYOR (NSW-SURVEYORS ACT 2002) (ACT-SURVEYORS ACT 2007)

> 1 HOMEBUSH BAY DRIVE, BLDG. F LEVEL 2, SUITE 1 **RHODES NSW 2138** TELEPHONE 02 8765 5500 FAX 02 8765 8099 Builder's licence No. 33493C





CLIENT	:				
Sch	2	2	.2	(a)	(ii)

SITE ADDRESS: BLOCK 12, SECTION 80 18 DIGBY CIRCUIT CRACE A.C.T.

HOUSE TYPE MODEL:	EDEN 27	DRAWN BY:	DATE DRA 16.07.14	
FACADE: TYPE: SPECIFICATI	MAJESTIC ON: LUX	COUNCIL AR		
SITE P		JOB No: J0038	21	

AWN: CHECKED BY: APPROVED FOR CONSTRUCTION: SCALE: 1:200 ISSUE: DRWG No: C

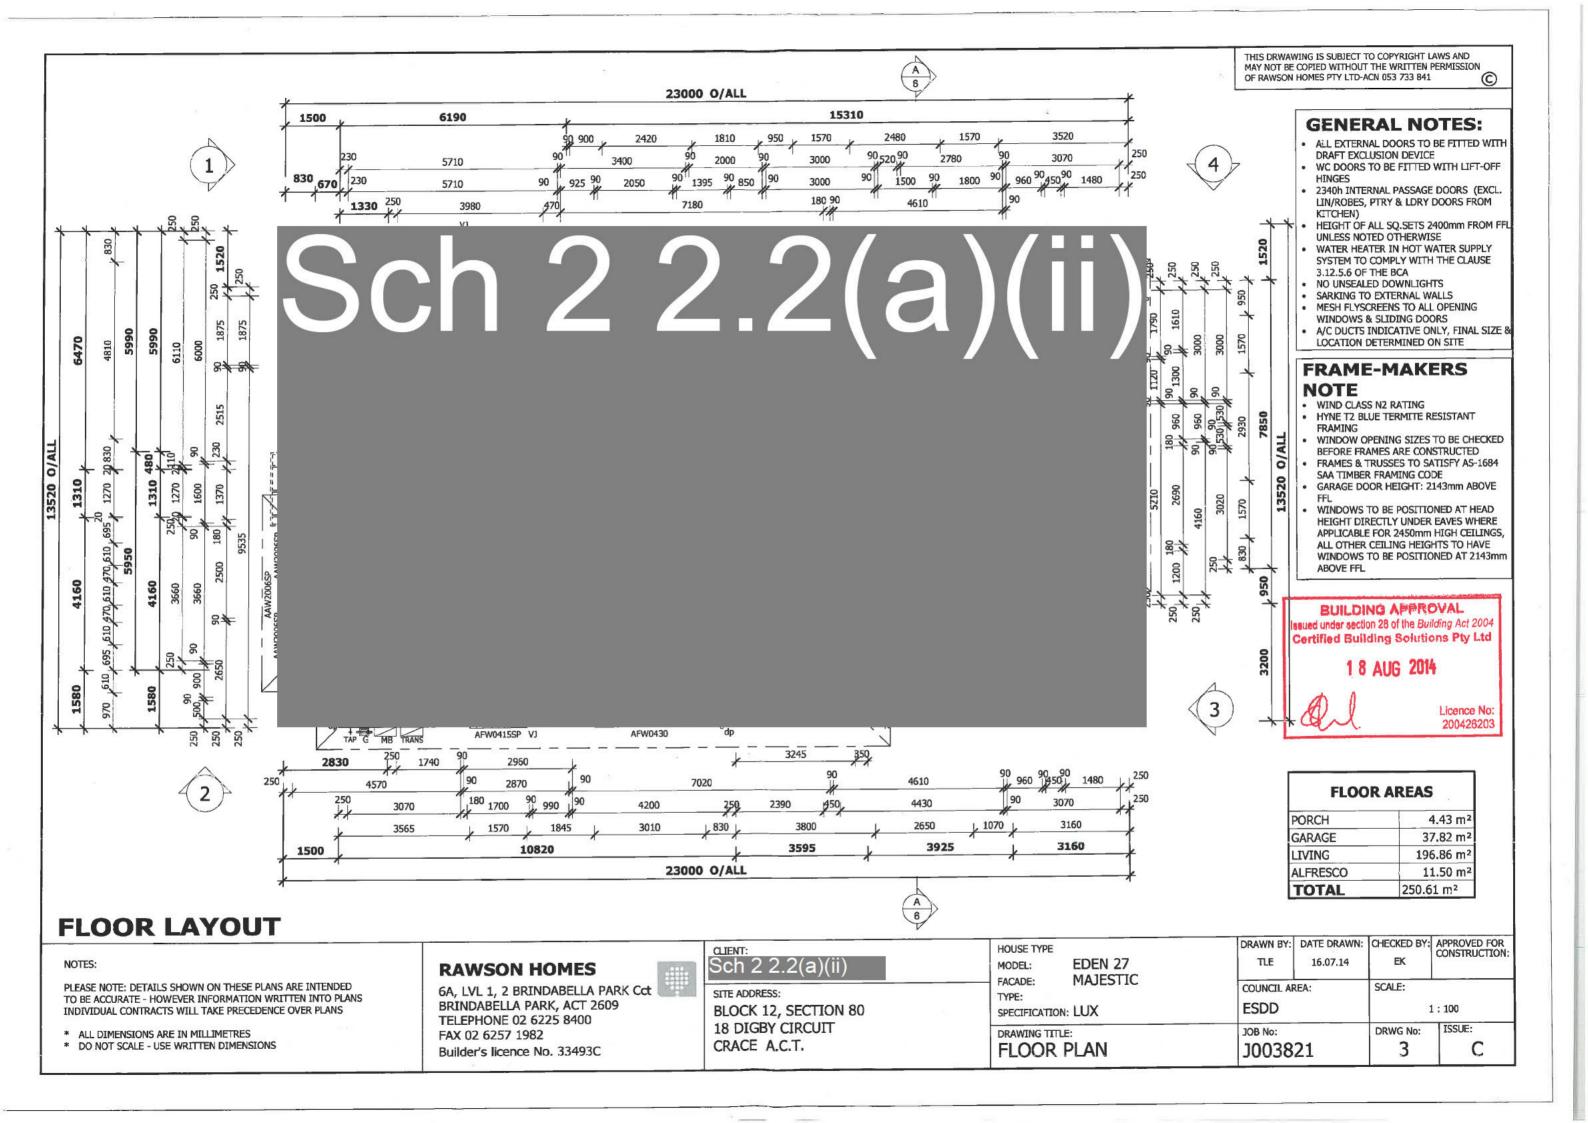

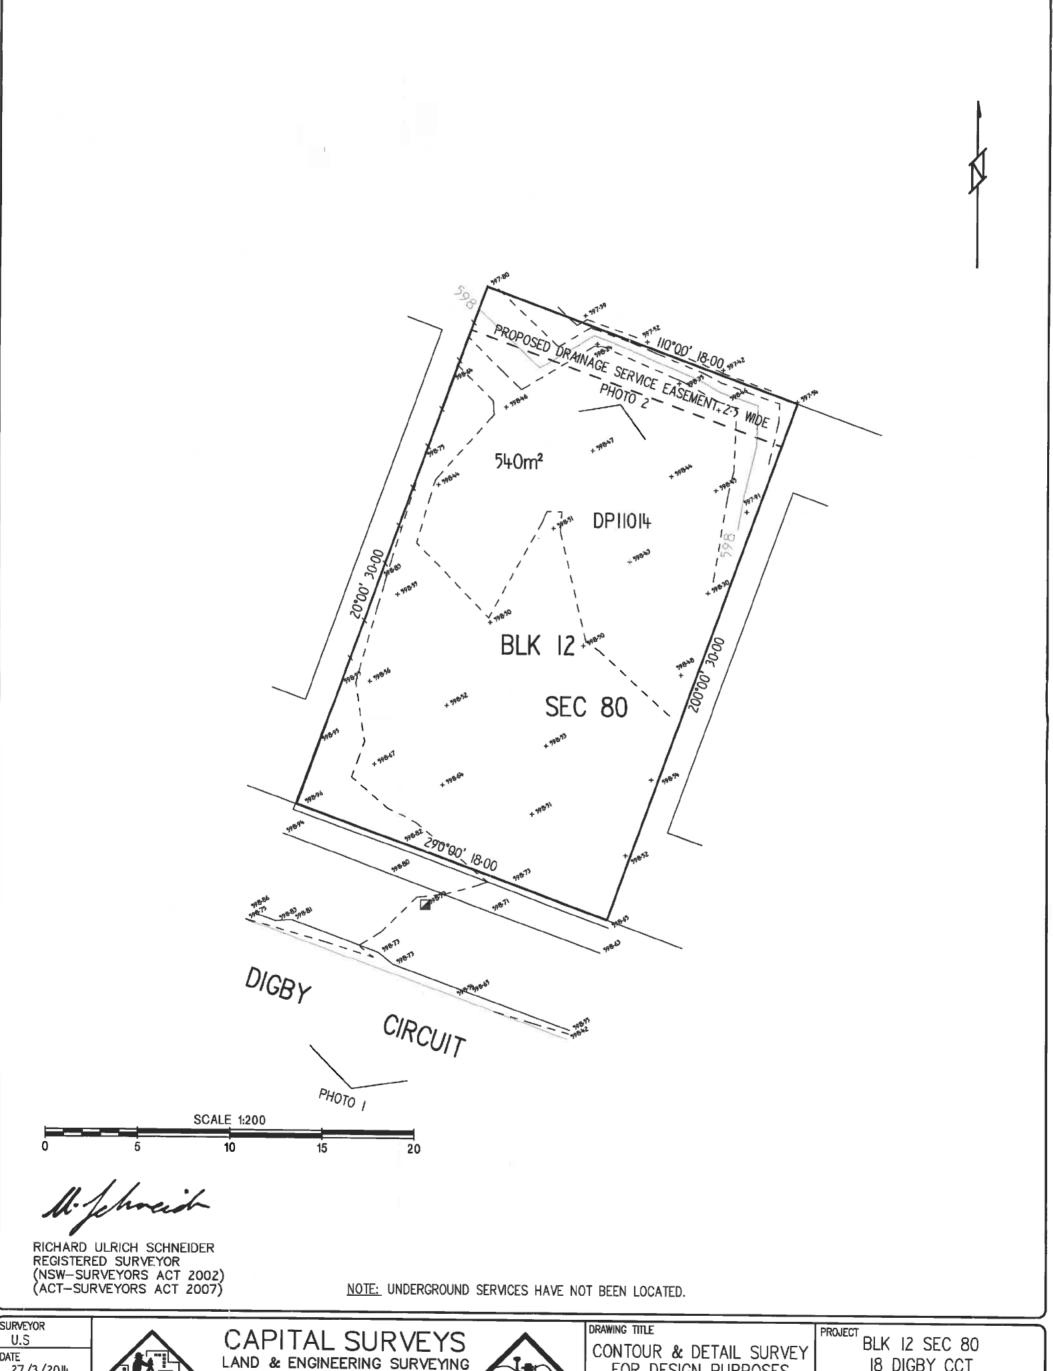

SURVEYOR

DATE 27/3/2014 LEVEL DATUM

A.H.D CONTOUR INTERVAL 0-25M



LAND & ENGINEERING SURVEYING PO BOX 7601, SUTTON NSW 2620

PHONE: (02) 6230 3577 MOBILE: 0418 697 180 capitalsurveys@bigpond.com



FOR DESIGN PURPOSES

CLIENT


RAWSON HOMES

18 DIGBY CCT

CRACE ACT

JOB NO. DRAWING REFERENCE 561101-DWG 5611

SIZE A3

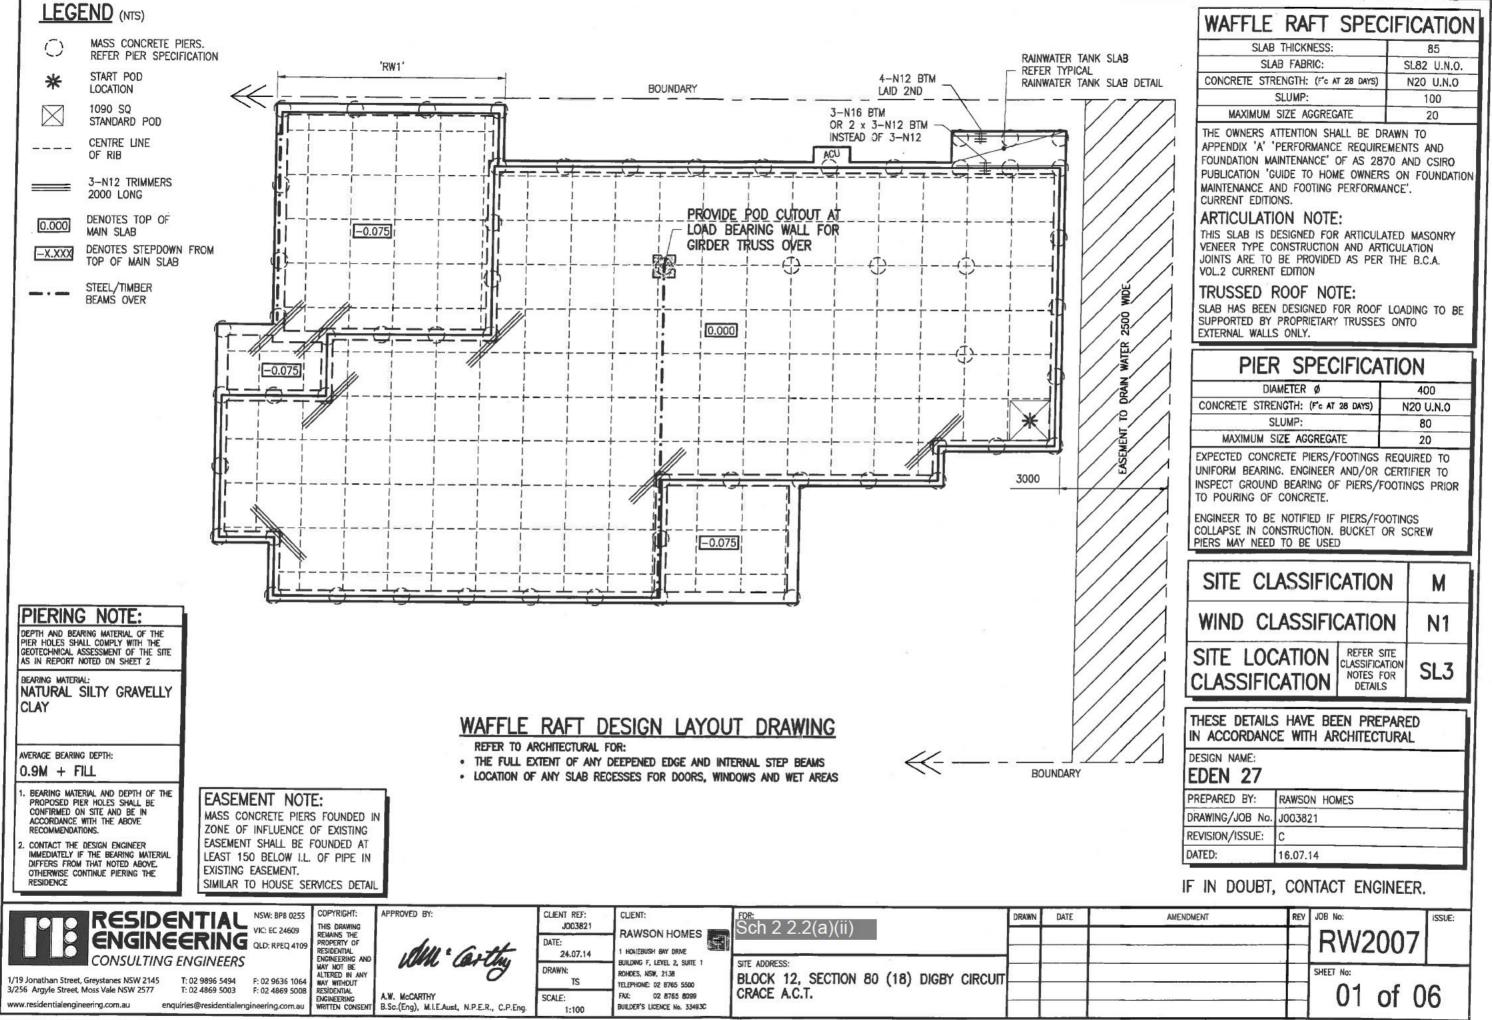

GENERAL NOTES

- G1. Engineers structural drawings are signed and issued on the understanding that the builder maintains in force, proper and adequate contract works insurance and public liability insurance during the full course of the construction. and/or any maintenance period, claims of damage to any adjacent property or building is not the responsibility of the engineer.
- These drawings shall be read in conjunction with all architectural and other consultants drawings and specifications and with such other written instructions as may be issued during the course of the contract, all discrepancies shall be referred to the architect for decision before proceeding with the work.

G3. All workmanship and materials shall be in accordance with the requirements of the current editions of the saa codes and there-by laws and ordinances of the relevant building authority.

- G4. Dimensions shall not be obtained by scaling the structural drawings, refer to architectural drawings for set out plan measurements, any set out dimensions shown on this document shall be verified by the builder.
- Any discrepancies/substitution in these documents shall be referred to the engineer for decision before proceeding with the work.
- G6. The sections/details on these drawings are intended to give the structural specifications only. architectural sections/details on these drawings are illustrative only.
- G7. These documents are signed subject to certificate of inspection being issued by this firm, all piers, slab and footing reinforcement shall be inspected by the engineer prior to the pouring of concrete. give 24hrs notice to the engineer.

SITE CLASSIFICATION

The site has been the subject of a geotechnical investigation requiring adherence to particular construction procedures and/or techniques. therefore these documents have been prepared using the recommendations of the geotechnical engineer.

Site classification: 'M' Classified by: IDEAL FOUNDATIONS Report/Project no: 11124-RES Dated: 27.03.14

- C2. The footing details shown are for the site classification stipulated, while every care has been taken to verify that the information shown is correct, Residential Engineering takes no responsibility for variations which may occur in site conditions subsequent to construction.
- C3. SL1: less than 1km from breaking surf or less than 100m from salt water not subject to breaking surf or within heavy industrial areas.
- SL2: 1km or more but less than 10km from breaking surf or 100m or more but less than 1km from salt water not subject to breaking surf
- SL3: 10km or more from breaking surf or 1km or more from salt water not subject to breaking surf. C6. Refer BCA class 1 and class 10 buildings housing
- provisions volume 2 for tables: Protective Coatings For Steelwork (table 3.4.4.2) Corrosion Protection Of Built-In Structural Steel Members (table 3.3.3.2)

Corrosion Protection For Wall Ties (table 3.3.3.1)

FOUNDATION AND FILLING

- F1. Strip topsoil or other organic matter to a depth of 100 mm and stockpiled.
- F2. Filling used for the support of a slab shall be controlled fill or rolled fill as follows:
- CONTROLLED FILL: Shall be placed, tested and certified by a qualified Geotechnical Engineer as defined in AS 3798. This is deemed to be adequate to support the footing system.
- (b) ROLLED FILL: consists of material compacted in layers by repeated rolling with an excavator or similar equipment. The depth shall not exceed 0.6 m compacted in layers not more than 0.3 m thick for sand material or 0.3 m compacted in layers not more than 15m thick for other material
- F3. Where fill consists of reactive clay, the fill shall be placed in a moist condition.
- Any fill shall continue past the edge of the building by at least 1 m and shall be retained or battered beyond this point by a slope not steeper than 1:2.
- F5. Except for sites with aggressive soils, a blinding layer of sand is not required. Where used, the blinding layer of sand shall comply with rolled fill requirements.

DRAINAGE DESIGN REQUIREMENTS

- D1. Surface drainage shall be designed and constructed to avoid water ponding against or near the footing.
- D2. The ground in the immediate vicinity of the perimeter footing shall be graded to fall 50 mm min away from the footing over a distance of 1 m.
- D3. The min height of the slab above F.G.L. landscaping or paving shall be 150 mm. Where adjoining paved areas slope away from the building, this height may reduced to 50 mm.
- D4. The base of trenches shall be sloped away from the building and backfilled in accordance with AS 2870
- D5. During construction, water run-off shall be collected and channeled away from the building.

CONCRETE PIERS

- P1. Pier diameter and locations are shown on plan.
- P2. u.n.o minimum pier depth is 600 mm below footings and wherever nominated should be socketed a minimum 300 mm into stiff clay.
- P3. All pier holes shall be cleaned and dewatered prior to the placement of concrete.
- P4. All piers shall be poured separate to footings.
- P5. It should be noted that if any of the footings encounter rock or shale, then all footings shall be piered to rock or shale, if partially piered to rock then articulation joints shall be provided at the rock/non-rock interface.
- P6. Concrete piers/footings are required to uniform bearing, engineer or council shall inspect ground bearing of piers/footings prior to pouring of

SAFE READING TARE

Strata	Stiff Clay	Rock and Shale	Natural Sand
Min Bearing Capacity 'kPa'	250	600	150

DAMP PROOFING MEMBRANE

APPROVED BY:

- DP1. A 0.2 mm min polyethylene damp-proofing high impact resistant membrane shall be placed beneath the slab so that the bottom surface is entirely underlaid and terminate at ground level.
- DP2. The membrane shall be branded continuously 'AS 2870 concrete underlay, 0.2 mm high impact resistant', together with manufacturer or distrubutors name, trademark or code.
- DP3. Lapping shall be 200 mm at joints and taped or sealed at plumbing penetrations with continuous close fitting sleeve or made continuous with the vapour barrier by taping and be made waterproof.

PLUMBING

PL1. Close cell polyethylene lagging shall be used around all stormwater and sanitary plumbing drain pipe penetrations through footings. The lagging shall be a minimum of 20 mm thick on H1 sites and 40 mm thick on Class H2 and Class E sites. Vertical penetrations do not require lagging. Additionally drains attached to or emerging from underneath the building including stormwater, sanitary and discharge pipes shall incorporate flexible joints immediately outside the footing and commencing within 1 m of the building perimeter to accommodate a total range of differential movement of the site (ys).

REINFORCEMENT AND FIXING

- R1. Minimum concrete cover as follows: 40 mm to unprotected ground
 - 30 mm to a membrane in contact with the ground 40 mm to an external surface 20 mm to an internal surface
- Slab fabric shall be supplied in flat sheets and be lapped one full square plus 25 mm at splices and placed on bar chairs at 1 m cts both ways.
- R3. Reinforcing bars shall have a lap length at splices not less than: 500 mm up to a bar ø of 12 mm 700 mm up to a bar ø of 16 mm
- At T and L intersections the bars shall be continued across the full width of the intersection.
- Service penetrations are permitted through the middle third of the depth of the edge beam and stiffening
- R5. Reinforcement and void formers shall be fixed in position prior to concreting by means of proprietary spacers, bar chairs with bases, ligatures or other appropriate fixings to achieve the required reinforcement position and concrete cover.
- Bar reinforcement shall be tied beneath the slab fabric if used or otherwise placed on bar chairs
- Concrete shall be transported, placed, compacted and cured in accordance with good building practice.
- Trenches, pier holes and bearns shall be dewatered and cleaned prior to concrete placement such that no significant softened or loosened material remains.
- R9. Concrete in trenches and beams shall be mechanically vibrated.

EXCAVATIONS

- E1. Temporary excavations in the area of the footing shall be carried out only where adequate support for the footing system is maintained such as piering beneath the expected excavation level or underpinning.
- E2. Permanent excavations of any vertical or near vertical structure within 2 m of the building and deeper than 0.6m in material other than rock shall be adequately retained or battered.
- E3. Excavations shall not extend below a line drawn at 30° for sand, 45° for clay to the horizontal from the bottom edge of the footing/pier without prior assessment

AGGRESSIVE SOILS

- A1. Buildings with masonry or concrete exposed to saline soils or to acid sulfate soils shall be protected from the aggressive soil or groundwater.
- A2. Where a layer of bedding sand 100 mm deep is provided, it shall comply with the 'FOUNDATION AND FILLING' notes.
- A3. Protection requirements from Geotechnical & local authorities shall be adhered to and provided to this office before commencing detailing.

SHRINKAGE CRACKING CONTROL

- S1. At re-entrant corners, one strip of 3-L11 or 3-N12 bar 2 m long shall be placed across the direction of potential cracking.
- S2. Where brittle floor coverings are to be used over an area greater than 16 m2 the following applies:
- Slab reinforcement in part of the slab which brittle finishes are applied shall not be less than SL92 or equivalent.
- (b) The bedding system for brittle coverings shall be selected on the basis of the expected slab movement
- (c) The placement of floor coverings shall be delayed by a minimum period of 3 months
- S3. Water shall not be added to the concrete on site so as to increase the slump above that specified.
- S4. Curing the concrete shall start immediately after finishing by continually wetting for 7 days min. Plastic or wax liquid sprays may be used in accordance with the manufacturers specifications. extra precaution such as the method of evaporative retardation (the use of aliphatic alcohols) is recommended during hot weather pours to help avoid thermal related slab cracking.


SUB-TERRANEAN TERMITE PROTECTION AND MAINTENANCE

- T1. All works to be in accordance with AS 3680.1
- T2. Any future cracking occurring in the slab/footing system is to be assessed by a qualified pest expert and where directed be sealed by epoxy injection.
- T3. Inspections of the residence and immediate surrounds to be carried out by a qualified pest expert on an annual basis by the home owner.
- T4. Site maintenance is the responsibility of the owner. All recommendations outlined in the CSIRO phamphlet, Building Technology File 18, Foundation Maintenance and Footing performance: A Homeowners Guide. and its recommendations should be followed in full.


MASONRY NOTES M1. Load bearing masonry shall comply with AS 3700

- M2. Masonry, Mortar durability and Articulation shall comply with the B.C.A class 1 and 10 buildings volume 2, form TN61 articulated walling and AS 2870
- M3. Internal brickwork built off the slab shall be laid on two layers of 'alcor' or '3 ply malthoid' or equivalent material.



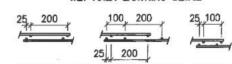



ALTERNATIVE METHODS OF LAPPING OF MESH

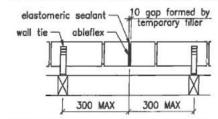

ARTICULATION JOINT AND WALL TIE DETAIL All wall ties to be built in and fixed to frame progressively as construction proceeds spaced at each side of expansion


joints and at each third course, the spacing of all other ties shall be as described in the b.c.a class 1 and 10 buildings housing provisions volume 2.

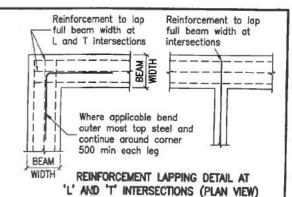


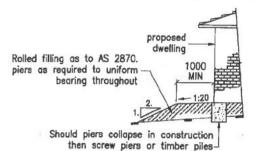

may need to be used FILLING SPECIFICATION DETAIL

FOR H1, H2, P & E SITES

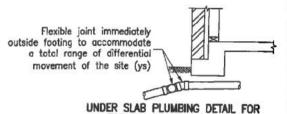

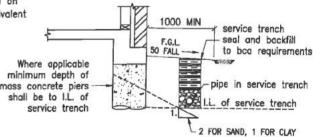

HOUSE SERVICES DETAIL

It is outside the control of the engineer to ensure the drainage contractor complies with this detail. The builder shall ensure that the drainage contractor complies with this detail in full

WIND		WALL TIE	HORIZONTAL	VERTICAL	
CLASS	(Vp)	(DUTY)	SPACING	SPACING	
N1	W28N1	LIGHT	600mm	600mm	
N2	W33N2	MEDIUM	600mm	600mm	
N3	W41N3	MEDIUM	600mm	430mm (5 COURSES)	

- wall tie spacings around openings 300cts ew
- polymer wall ties rated "light duty only" (w28n1)
- (vp = permissable stress method)



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T: 02 4869 5003

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A.W. McCARTHY B.Sc.(Eng), M.I.E.Aust, N.P.E.R., C.P.Eng.

J003821 DATE: 24.07.14 DRAWN:

SCALE:

RAWSON HOMES HOMEBUSH BAY DRIVE BUILDING F. LEVEL 2. SUITE 1 ROHDES, NSW. 2138 TELEPHONE: 02 8765 5500 02 8765 8099 BUILDER'S LICENCE No. 33493C


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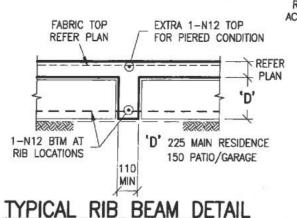
Sch 2 2.2(a)(ii)


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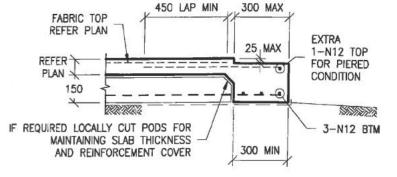
DATE AMENDMENT ISSUE: SHEET No 02 of 06

3/256 Arayle Street, Moss Vale NSW 2577





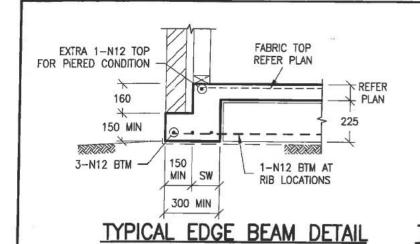


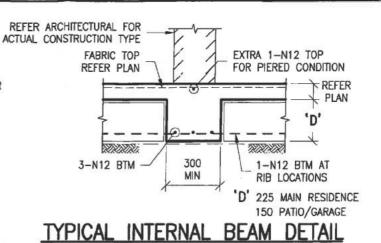


TYPICAL GARAGE DOOR REBATE DETAIL


. GARAGE DOOR REBATE SHOWN IS DIAGRAMMATIC ONLY AND SHALL BE READ IN CONJUNCTION WITH THE ARCHITECTURAL FOR ACTUAL REBATE DEPTH x WIDTH.

 IF REQUIRED PROVIDE 10mm FALL FROM BACK OF GARAGE TO GARAGE DOOR OPENING

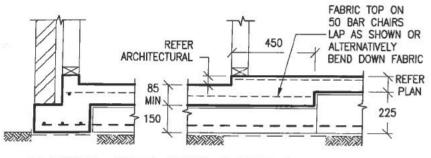


TYPICAL WET AREA RECESS DETAIL TO BE USED IN ACCORDANCE WITH THE ARCHITECTURAL

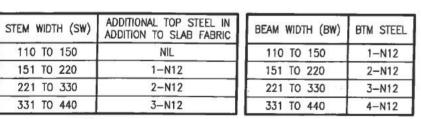


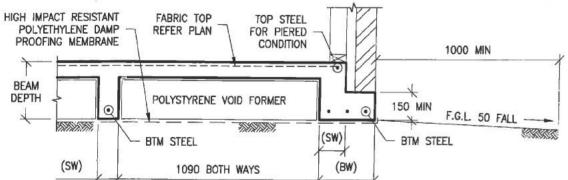





RW11(RIBBED WIRE GRADE 500RW) MAY BE USED IN LIEU OF N12'S

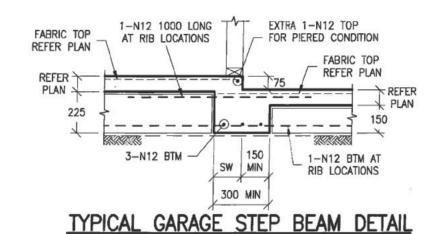

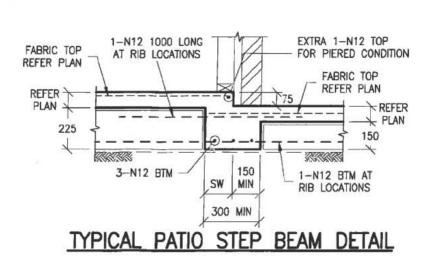

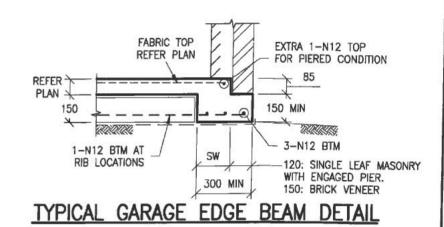

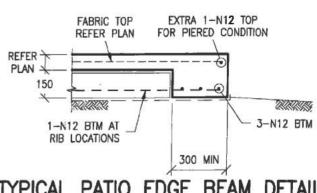

TYPICAL PATIO EDGE BEAM DETAIL


IF IN DOUBT, CONTACT ENGINEER.



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3/256 Argyle Street, Moss Vale NSW 2577 ww.residentialengineering.com.au


CLIENT: J003821 HOMEBUSH BAY DRIVE BUILDING F, LEVEL 2, SUITE 1 ROHDES, NSW, 2138 TS

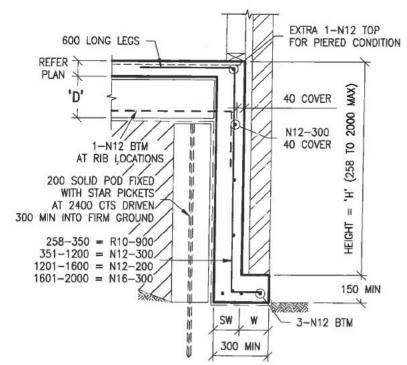


TYPICAL DEEPENED EDGE BEAM DETAIL

'D' = 225 MAIN RESIDENCE 150 PATIO/GARAGE


'W' = 120 MIN FOR SINGLE LEAF MASONRY WITH ENGAGED PIER. 150 MIN FOR BRICK VENEER

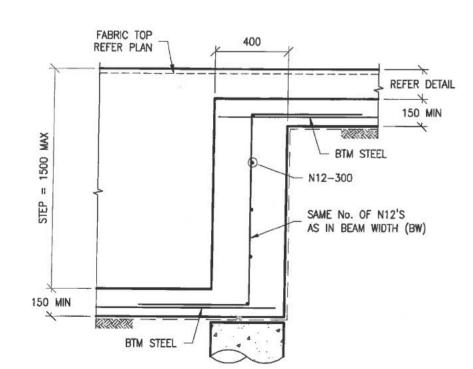


TYPICAL DEEPENED EDGE BEAM TRANSITION DETAIL

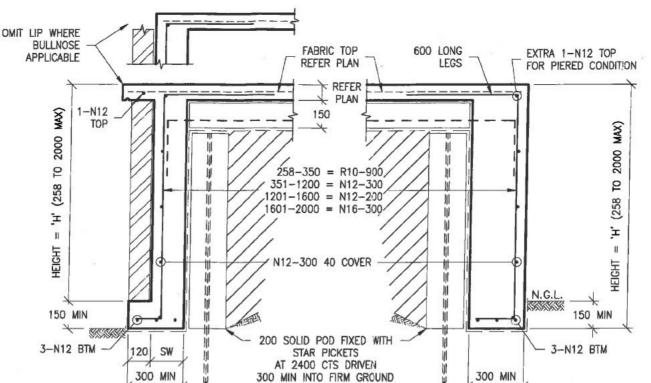

ALTERNATE DEEPENED PATIO EDGE BEAM DETAILS

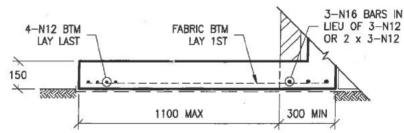


TYPICAL RAINWATER TANK SLAB DETAIL DETAIL IS APPLICABLE AT ALL TYPICAL EDGE BEAMS. CONSTRUCTION TYPE MAY VARY FROM SHOWN

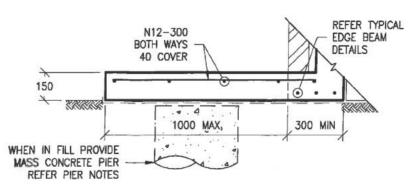


TYPICAL ACU/HWS SLAB DETAIL THIS DETAIL IS APPLICABLE AT ALL TYPICAL EDGE BEAMS. CONSTRUCTION TYPE MAY VARY FROM SHOWN

DEEPENED BEAM STEM WIDTH TABLE

HEIGHT (H)	(SW) STEM WIDTH
UP TO 1200	150
1201 TO 1600	200
1601 TO 2000	250

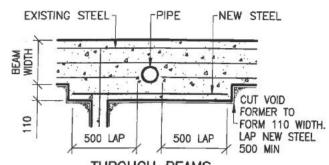


THROUGH BEAMS

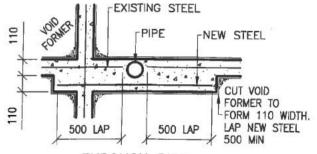

THROUGH RIBS

PLAN ON PIPE PENETRATION

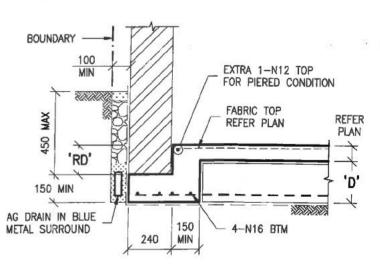

EDGE BEAM DETAIL 'RW1'

SHEET No:

04 of 06

IF IN DOUBT, CONTACT ENGINEER.

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F: 02 9636 1064 T: 02 4869 5003 F: 02 4869 5008 enquiries@residentialengineering.com.au

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APPROVED BY:

RESIDENTIAL ENGINEERING WRITTEN CONSENT B.Sc.(Eng), M.LE.Aust, N.P.E.R., C.P.Eng.

CLIENT REF: CLIENT: RAWSON HOMES HOMEBUSH BAY DRIVE 24.07.14 BUILDING F, LEVEL 2, SUITE 1 DRAWN:

SCALE:

ROHDES, NSW, 2138 ELEPHONE: 02 8765 5500 02 8765 8099 BUILDER'S LICENCE No. 334930

DRAWN DATE AMENDMENT Sch 2 2.2(a)(ii) BLOCK 12, SECTION 80 (18) DIGBY CIRCUIT CRACE A.C.T.

3/256 Argyle Street, Moss Vale NSW 2577


ISSUE:

ALL STEEL BEAM CROSS SECTIONS ARE DIAGRAMMATIC ONLY

- REFER TO THE MANUFACTURERS SPECIFICATIONS FOR INSTALLATION DETAILS OF I—JOISTS, LVL'S AND ROOF TRUSSES WHERE APPLICABLE.
- SOLID TIMBER JOISTS SHALL NOT BE NOTCHED IN EXCESS OF THE RECOMMENDATIONS OF AS 1684.1. WHERE NECESSARY PROVIDE TIMBER PLATE OVER STEEL BEAM AND PROVIDE TOP MOUNT JOIST HANGERS. ALTERNATIVELY USE TIMBER BLOCKING BETWEEN FLANGES OF STEEL BEAM SUPPORTING JOISTS AND USE FACE MOUNTED JOIST HANGERS.

STEEL BEAM PROFILE NOTE:

THE BEAM(S) SPECIFIED ON THIS DRAWING DOES NOT REPRESENT THE ONLY POSSIBLE STRUCTURAL SOLUTION. PLEASE CONTACT RESIDENTIAL ENGINEERING IF AN ALTERNATIVE BEAM PROFILE WOULD BE PREFERRED FOR ARCHITECTURAL OR CONSTRUCTABILITY REASONS.

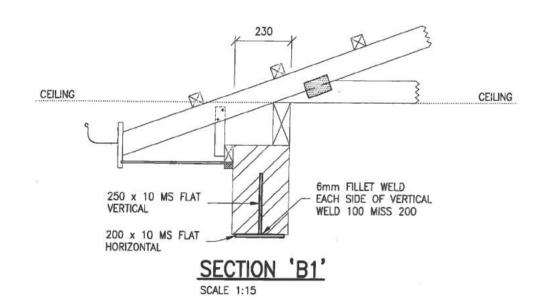


MEMBER SCHEDULE

ITEM	DESCRIPTION	LOCATION
B1	250 x 10 WEB X 200 x 10 FLANGE 'T' BAR	PC3

PROTECTIVE COATINGS FOR STEELWORK:

- PC1. INTERNAL STEELWORK NO PROTECTIVE COATINGS REQUIRED.
- PC2. EXTERNAL STEELWORK TO BE HOT DIPPED GALVANISED 300g/m². OR COATED WITH 2 COATS OF ALKYD PRIMER.
- PC3. LINTELS IN MASONRY TO BE HOT DIPPED GALVANISED 600g/m2.

IF IN DOUBT, CONTACT ENGINEER.

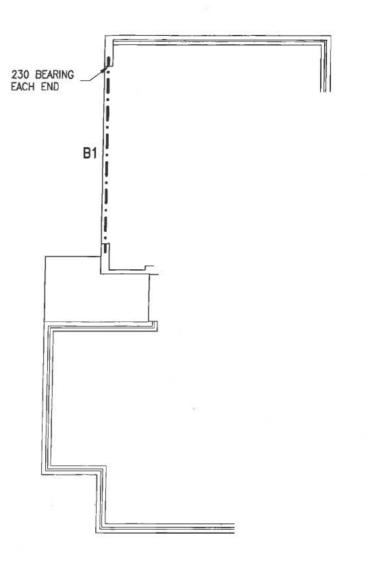



STEELWORK DESIGN MARKING DRAWING

STRUCTURAL STEEL NOTES


- S1. ALL WORKMANSHIP AND MATERIALS SHALL BE IN ACCORDANCE WITH AS 4100.
- S2. STEELWORK DESIGNED IN ACCORDANCE WITH AS 4100 "STEEL STRUCTURES CODE" AND AS 1170.1/AS 1170.2 "DEAD AND LIVE LOADS AND WIND LOADS". STRUCTURAL STEEL TO BE GRADE (BHP 300 PLUS)
- S3. SURFACE PREPARATION AND FINISH TO COMPLY WITH AS/NZS 2312 AND BUILDING CODE OF AUSTRALIA CLASS 1 AND 10 BUILDINGS VOLUME 2. THE BUILDER MUST CLARIFY HIS CONTRACTUAL OBLIGATIONS IN THIS REGARD.
- S4. THE INSTALLATION OF GALINTELS AND 'T' BARS TO BE STRICTLY IN ACCORDANCE WITH MANUFACTURERS SPECIFICATIONS.
- S5. THE STABILITY OF THE STRUCTURE DURING CONSTRUCTION IS THE BUILDERS RESPONSIBILITY. ADEQUATE TEMPORARY BRACING SHALL BE PROVIDED AS IS NECESSARY TO STABILISE THE STRUCTURE DURING CONSTRUCTION.
- WELDS
 - ALL WELDS TO BE 6mm CONTINUOUS FILLET WELD U.N.O.
 - BUTT WELDS WHERE INDICATED IN THE DOCUMENTS TO BE COMPLETE PENETRATION BUTT WELDS AS DEFINED IN AS 1554.
- ALL SHOP WELDS TO BE FULLY WELDED U.N.O.
- USE E41XX ELECTRODES FOR ALL WELDING U.N.O.
- S7. SITE WELDING OF HOT DIP GALVANISED STEEL IS PERMISSIBLE IF UPON COMPLETION THE WELDS ARE TREATED WITH THE APPROPRIATE COATING FOR SEVERE AS PER THE B.C.A AND AS/NZS 2312.
- 88. BOLT DESIGNATION:
 - 4.6/S COMMERCIAL BOLT OF GRADE 4.6 TO AS 1111 SNUG TIGHTENED
 - 8.8/S HIGH STRENGTH STRUCTURAL BOLTS OF GRADE 8.8 TO AS 1252 SNUG TIGHTENED
 - BOLTS TO BE PROVIDED WITH THREADS CLEAR OF SHEAR PLANE.
- S9. ALL BOLTS TO BE HIGH STRENGTH GRADE U.N.O. NO CONNECTION SHALL HAVE LESS THAN TWO BOLTS. ALL BOLTS AND WASHERS TO BE GALVANISED.
- S10. BEAMS SUPPORTED ON BRICKWORK (BEARING NOTED ON PLAN) TO HAVE INCOMPRESSIBLE PACKING AS REQUIRED UNDER THE ENDS OF THE BEAM TO ENSURE EVEN BEARING ON THE BRICKWORK.
- S11. THE BUILDER SHALL PROVIDE ALL CLEATS AND DRILL ALL HOLES NECESSARY FOR FIXING STEEL TO STEEL AND TIMBER TO STEEL, WHETHER OR NOT DETAILED IN THE DRAWINGS.
- S12. ALL GUSSET PLATES TO BE 10mm THICK U.N.O.
- S13. ALL COLUMNS AND BEAMS SHOWN ON THE DRAWINGS FOR TIMBER FRAMED BUILDINGS SHALL BE LATERALLY RESTRAINED BY THE BUILDING FRAME AT EACH SUPPORT LOCATION THROUGH POSITIVE SCREW FIXING OF WALL STUDS TO THE COLUMNS AND EITHER JOISTS OR NOGGINGS TO THE BEAMS. FOR ARTICULATED FULL MASONRY BUILDINGS, COLUMNS WILL BE LATERALLY RESTRAINED BY BRICKWORK AT EACH SUPPORT LOCATION THROUGH POSITIVE FIXING OF WALL TIES. WHERE A BEAM DIRECTLY SUPPORTS A CONCRETE SLAB NO ADDITIONAL RESTRAINT IS REQUIRED.
- S14. THE BUILDER IS TO MAKE GOOD AND/OR REPAIR ALL DAMAGED SURFACES DURING PERFORMANCE OF THE WORK.

COPYRIGHT: APPROVED BY: CLIENT: **AMENDMENT** REV JOB No: DRAWN DATE ISSUE: Sch 2 2.2(a)(ii) THIS DRAWING REMAINS THE J003821 RAWSON HOMES VIC: EC 24609 ENGINEERING OLD: RPEQ 4109 PROPERTY OF RESIDENTIAL ENGINEERING AND MAY NOT BE ALTERED IN ANY HOMEBUSH BAY DRIVE 24.07.14 BUILDING F, LEVEL 2, SUITE 1 SHEET No. ROHDES, NSW, 2138 BLOCK 12, SECTION 80 (18) DIGBY CIRCUIT 1/19 Jonathan Street, Grevstanes NSW 2145 T: 02 9896 5494 F: 02 9636 1064 WAY WITHOUT TELEPHONE: 02 8765 5500 05 of 06 3/256 Argyle Street, Moss Vale NSW 2577 T: 02 4869 5003 F: 02 4869 5008 RESIDENTIAL ENGINEERING CRACE A.C.T. A.W. McCARTHY DZ 8765 8099 SCALE: www.residentialengineering.com.au enquiries@residentialengineering.com.au BUILDER'S LICENCE No. 33493C WRITTEN CONSENT B.Sc.(Eng), M.I.E.Aust, N.P.E.R., C.P.Eng. AS SHOWN

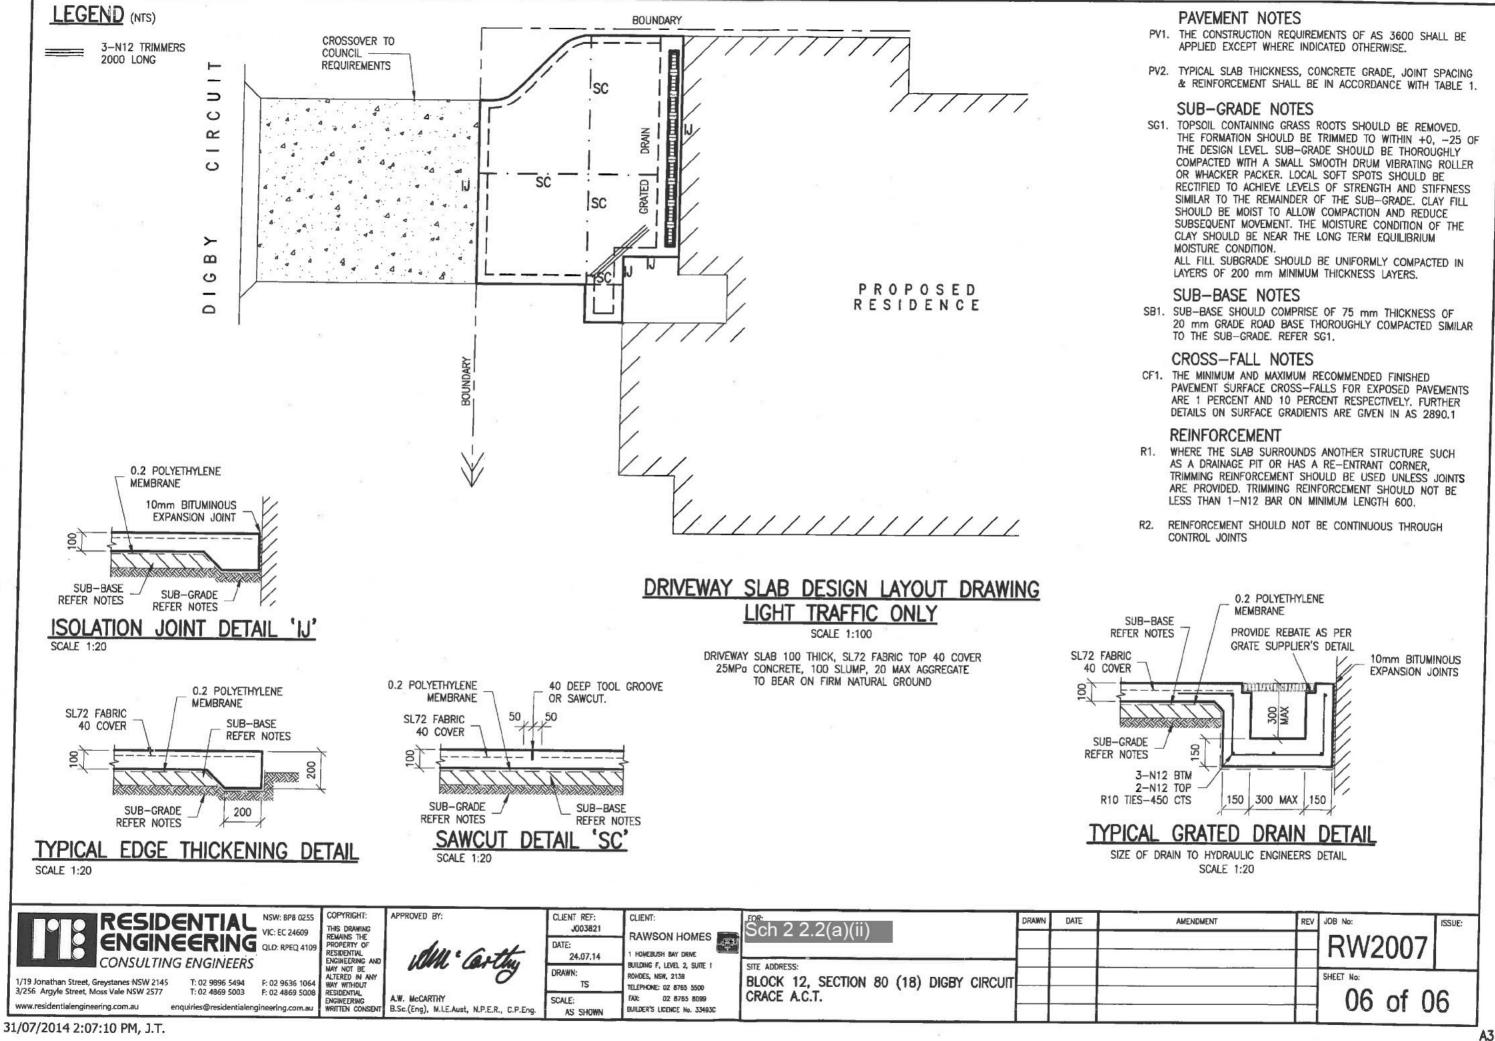


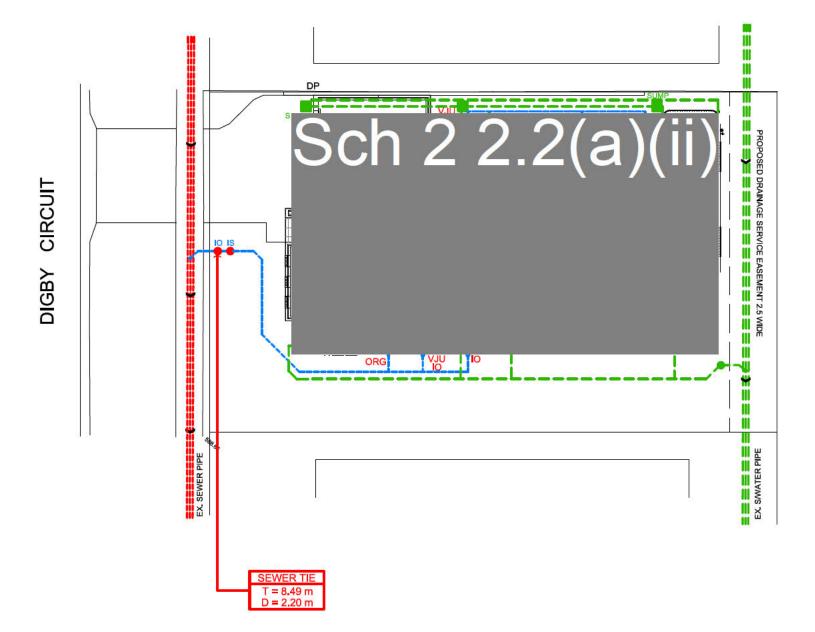




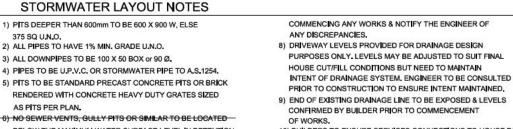

- BELOW THE MAXIMUM WATER SURFACE LEVEL IN DETENTION
- 7) PERSONS UTILISING THIS PLAN FOR ANY PURPOSES SHALL VERIFY THE DATUM & RESPECTIVE LEVELS PRIOR TO
- 10) BUILDERS TO ENSURE SERVICES CONNECTIONS TO HOUSE DO NOT CONFLICT WITH DRAINAGE DESIGN REQUIREMENTS.
- 11) ALL WORKS TO BE CONSTRUCTED TO GOOD BUILDING PRACTICE & MATERIALS TO MEET ACCEPTED SPECIFICATIONS.

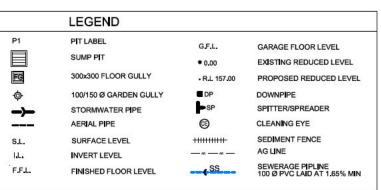

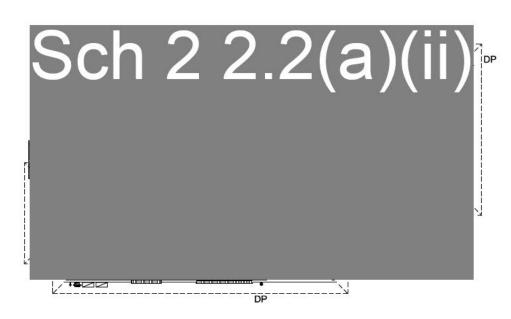

ROOF & GROUND FLOOR LAYOUT

SEWERAGE LAYOUT NOTES

1. EXISTING SEWER LINES & TIES TO BE LOCATED ON SITE PRIOR TO CONSTRUCTION.

2. ALL WORKS TO BE COMPLETED IN ACCORDANCE WITH AS3500.2.3 (2003)

3. ALL WORKS ARE TO BE CONDUCTED IN ACCORDANCE WITH THE CANBERRA SEWERAGE REGULATIONS.

4. THE INSPECTION SHAFT AT THE PROPERTY BOUNDARY TO BE IN ACCORDANCE WITH PLUMBING NOTE No.3.

SANITARY FIXTURES

(1) TOILETS 2 (2) BATHS (3) BASINS 3 (5) KITCHEN SINKS (6) LAUNDRY TROUGH



ORG - OVERFLOW RELIEF GULLY

VJU - VERTICAL JUMP UP

VP - VENT PIPE

SVP - SOIL VENT PIPE

- INSPECTION OPENING


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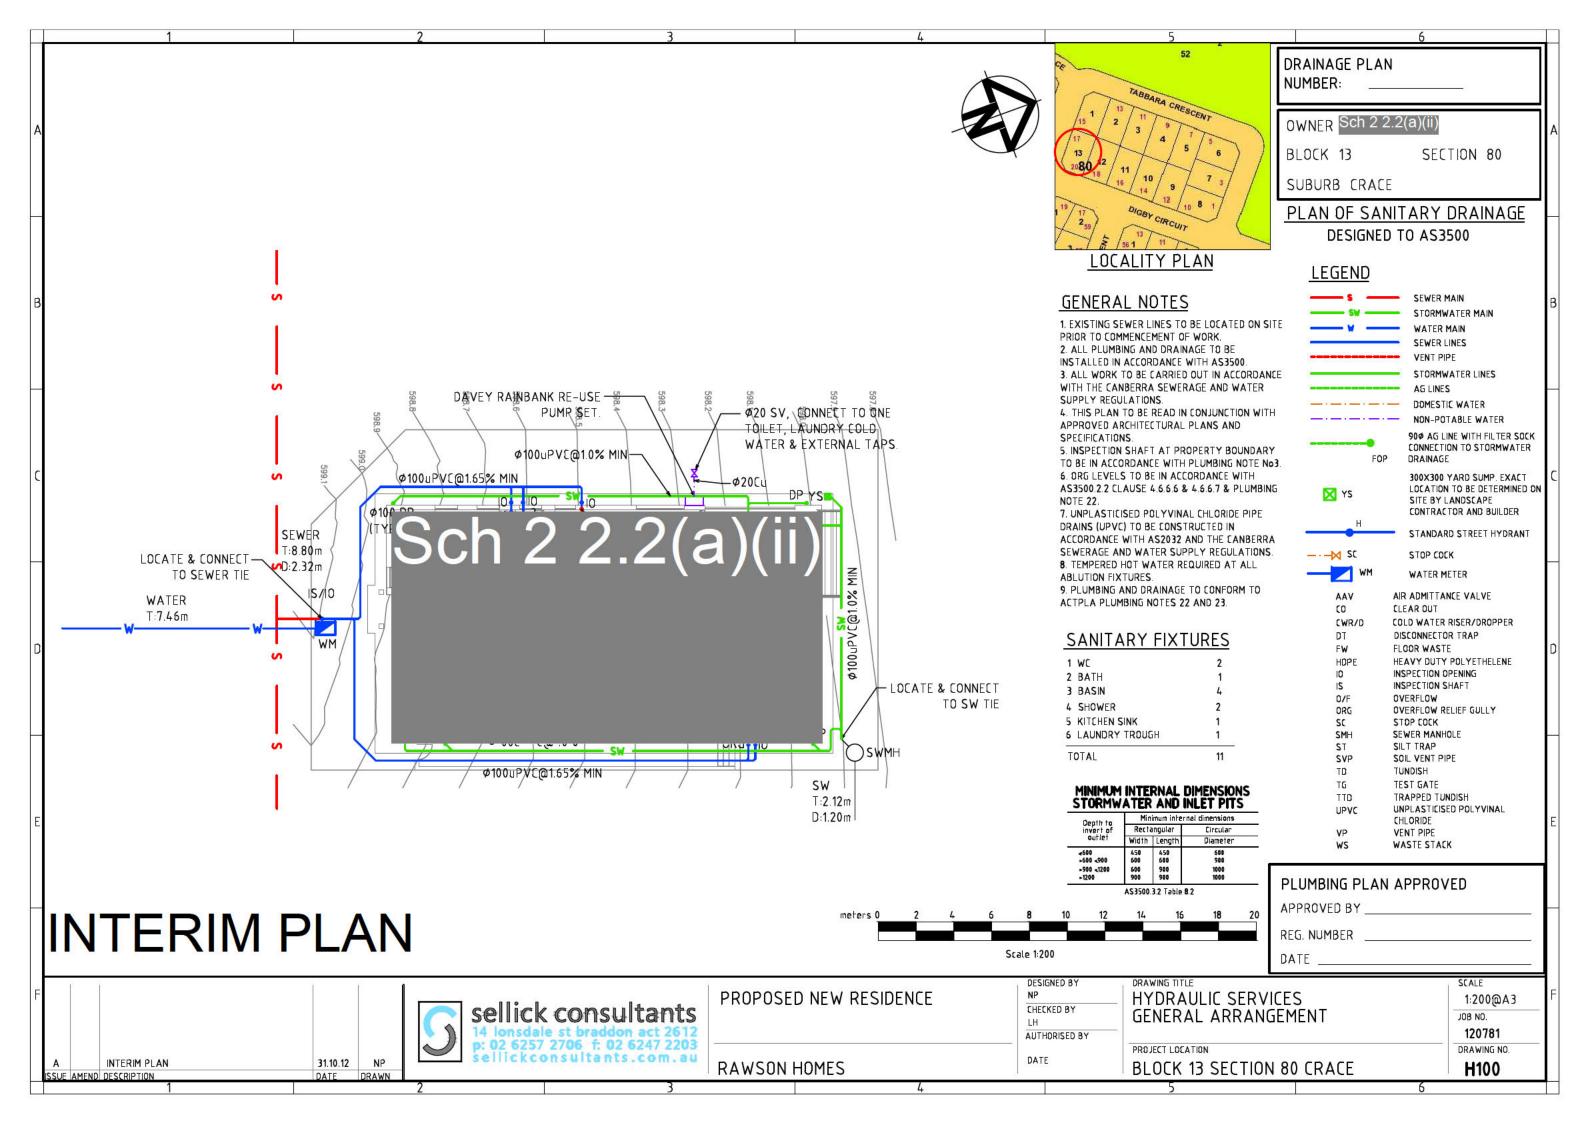
CIVIL ENGINEERING CONSULTANTS I


P: 02 8819 2565 F: 02 8819 2597 E: admin@alwdesign.com.au M: 0413 763 432 69A COWELLS LANE, ERMINGTON NSW 2115


PROJECT: PROPOSED RESIDENTIAL DWELLING AT BLOCK 12 / SECTION 80, 18 DIGBY CIRCUIT, CRACE ACT DRAWING: STORMWATER & SEWERAGE LAYOUT


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A.W	M.W	DRAWINGS NOT	TO BE USED FOR CONSTRUCTION UNLESS SIGNED BY DESIG	
С	C ISSUED FOR WORK AS EXECUTED 16/12/14			
ISSUE	REVISION DESCRIPTION APPR. DATE		APPR. DATE	




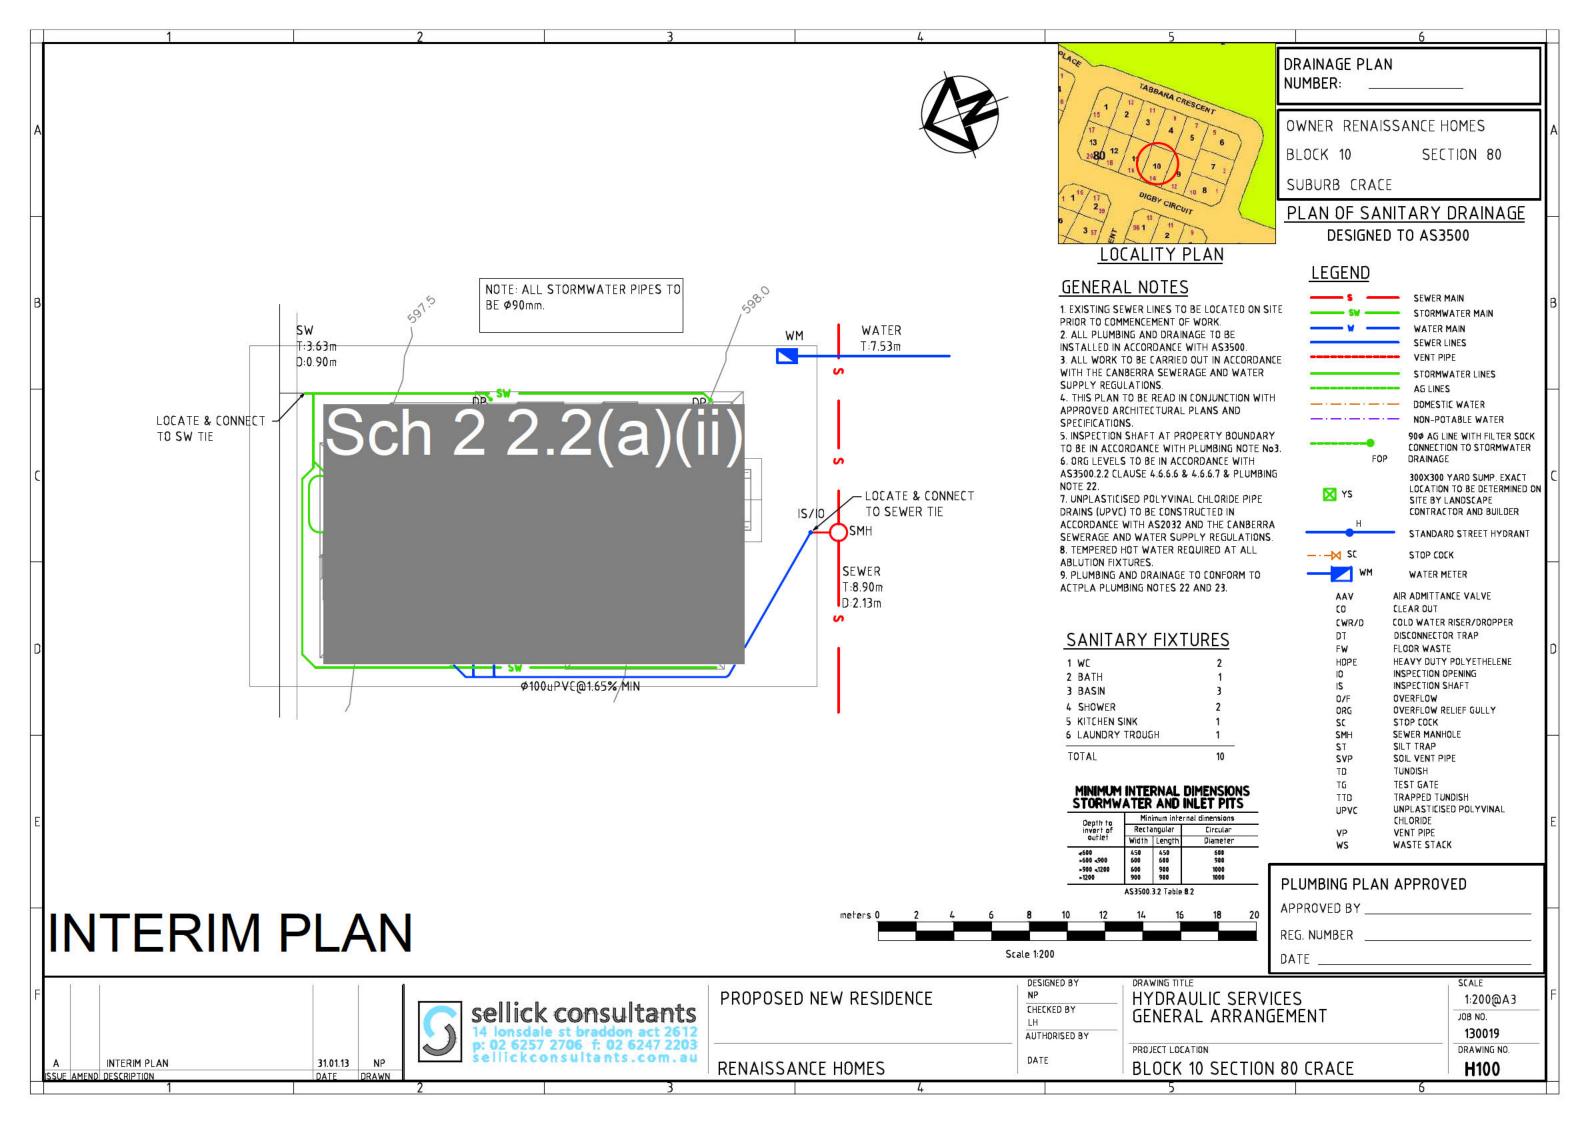


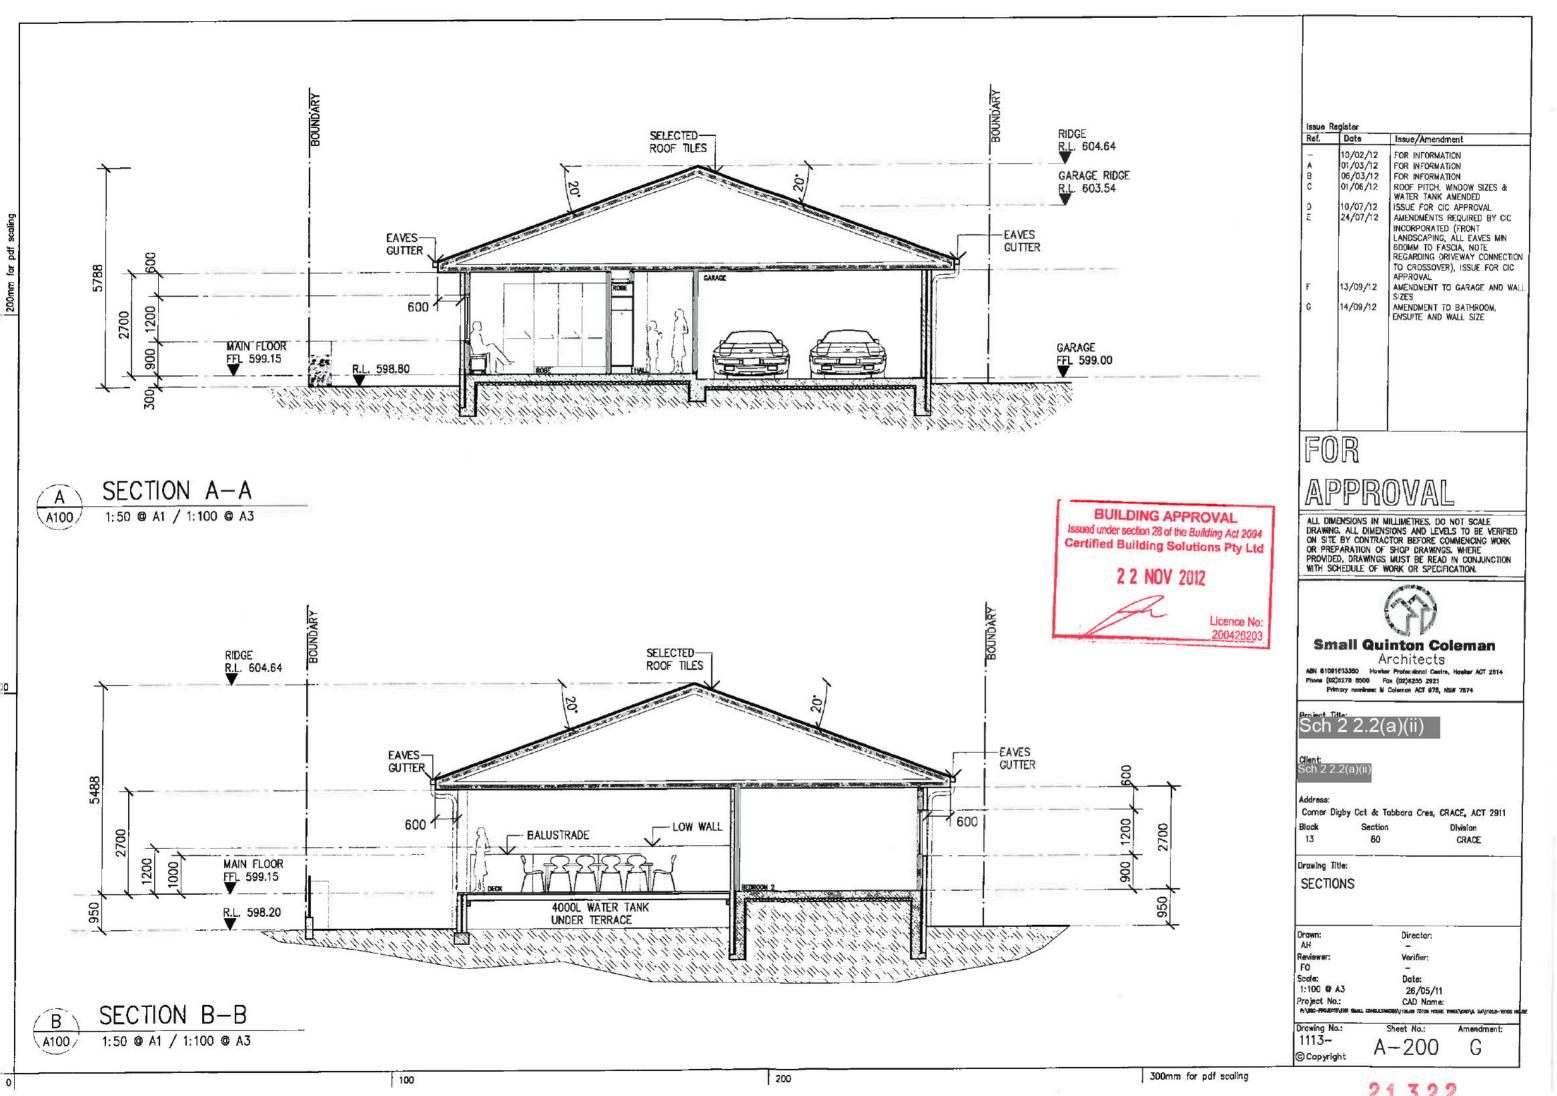


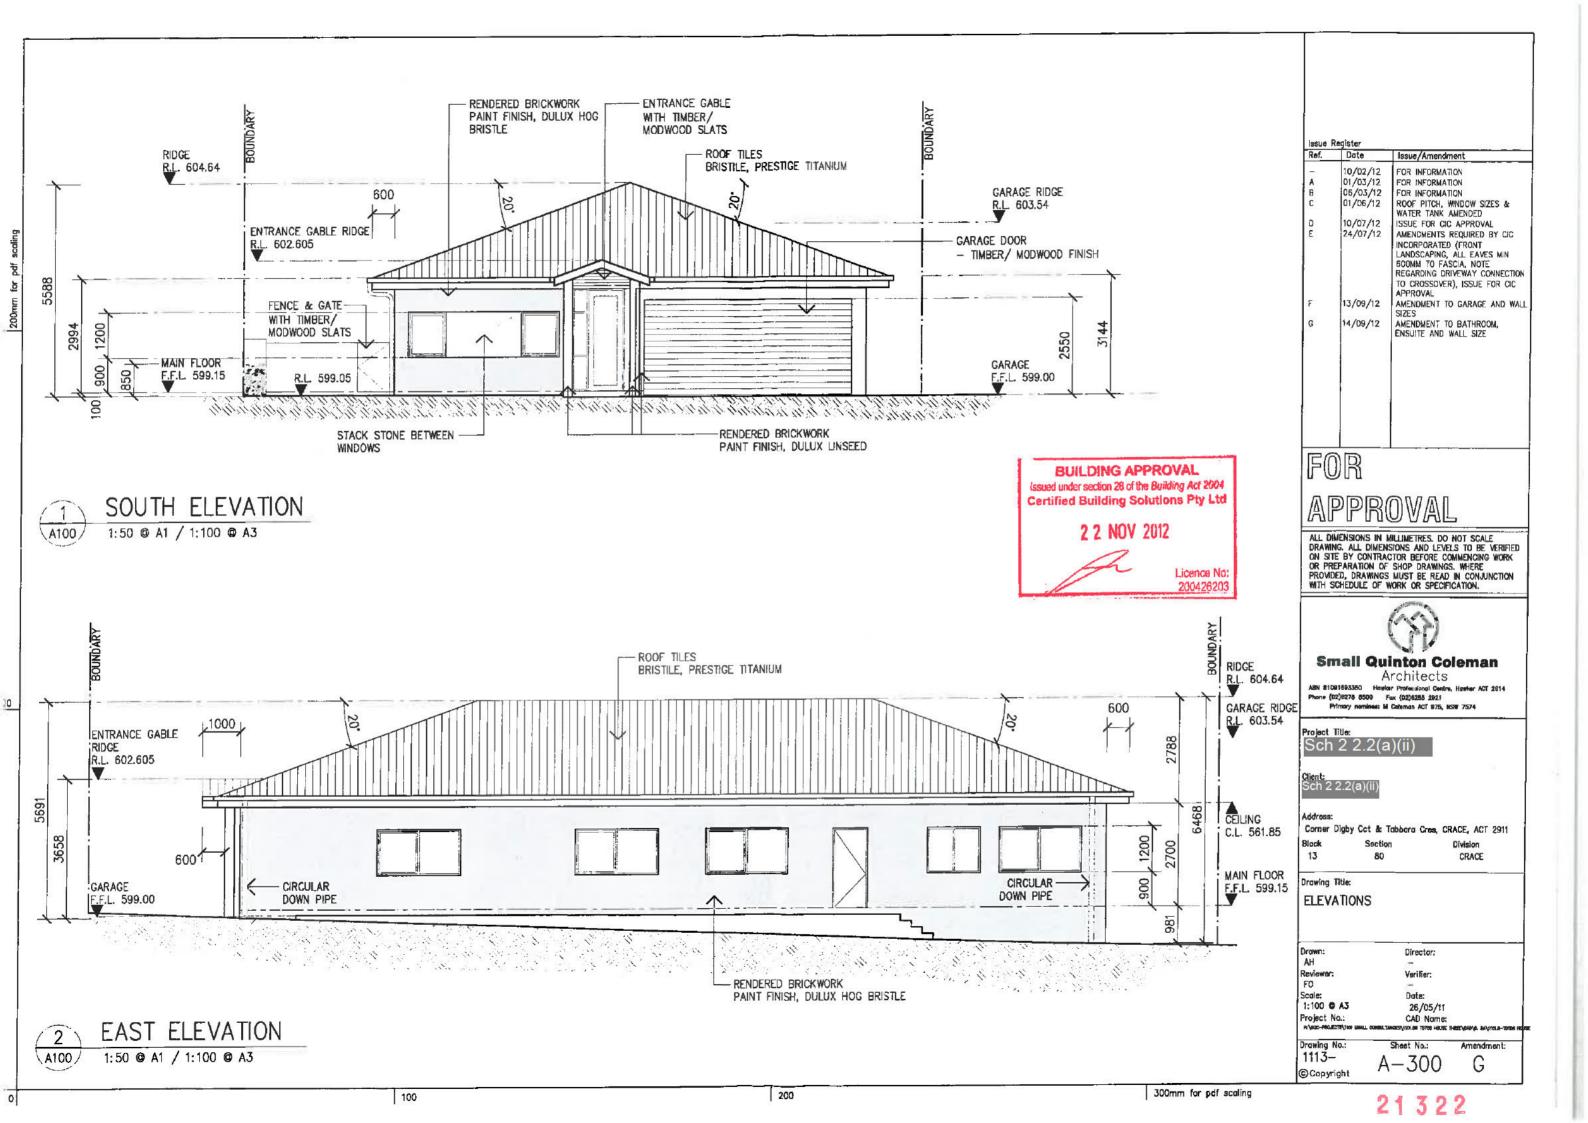

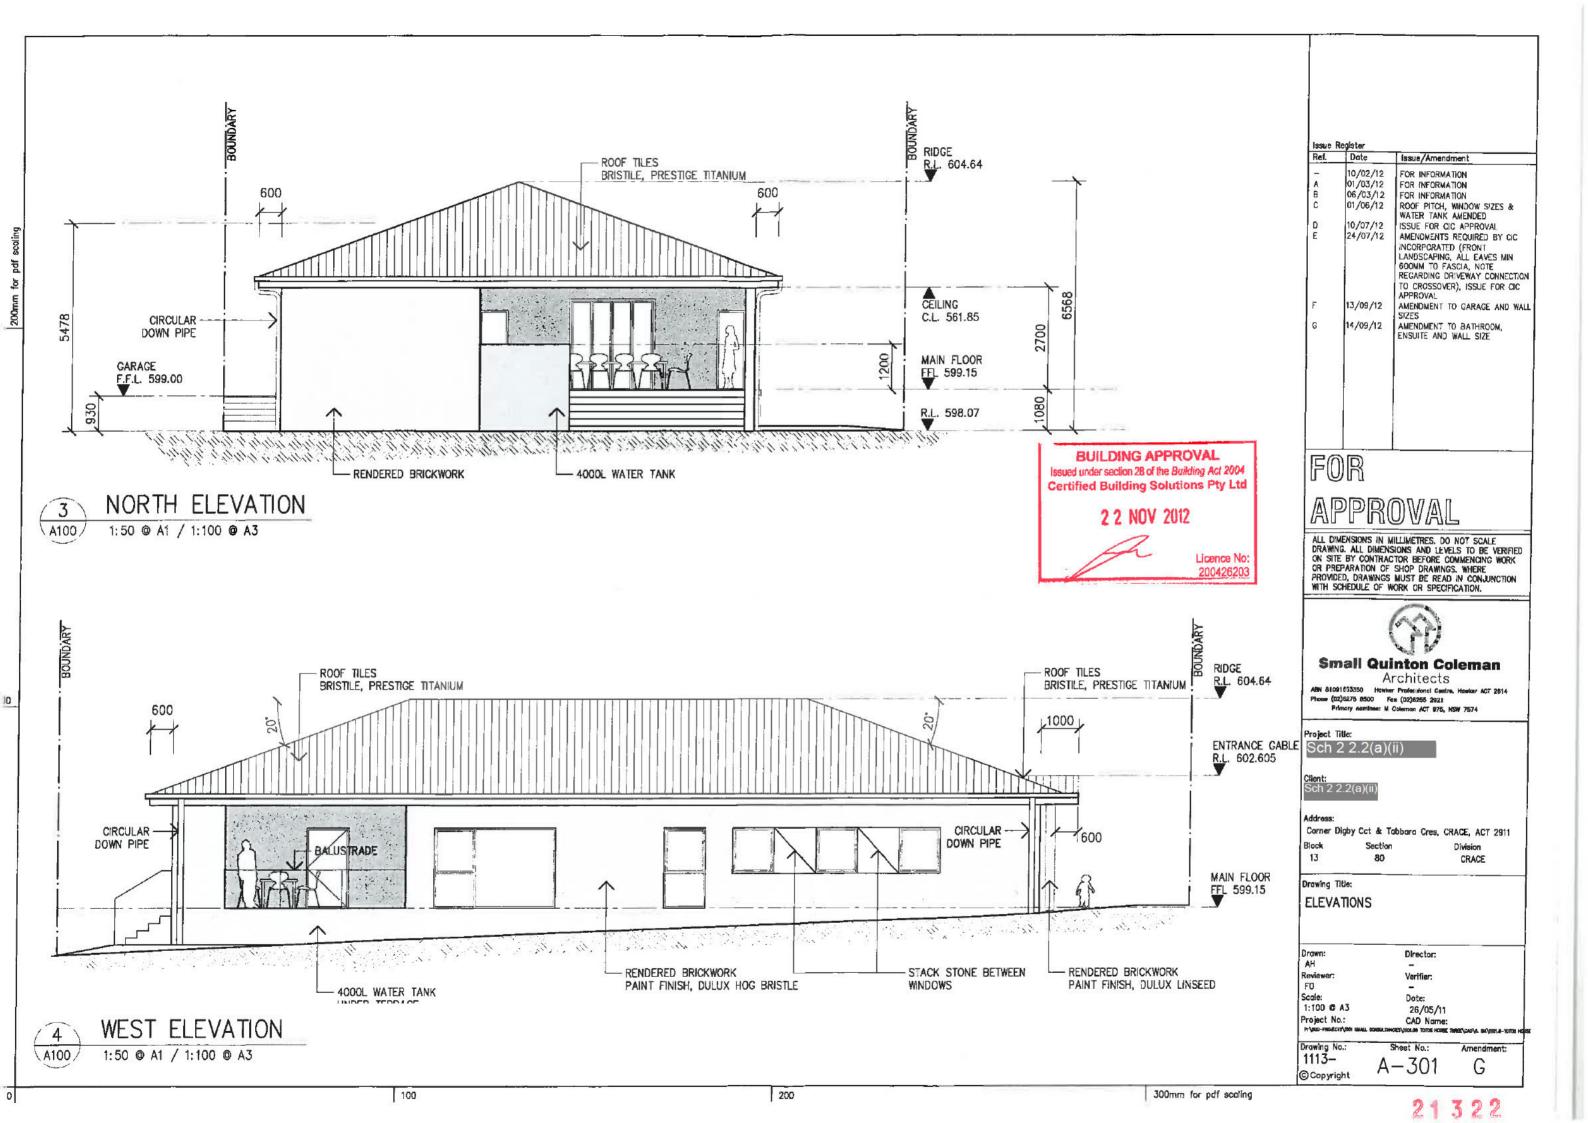

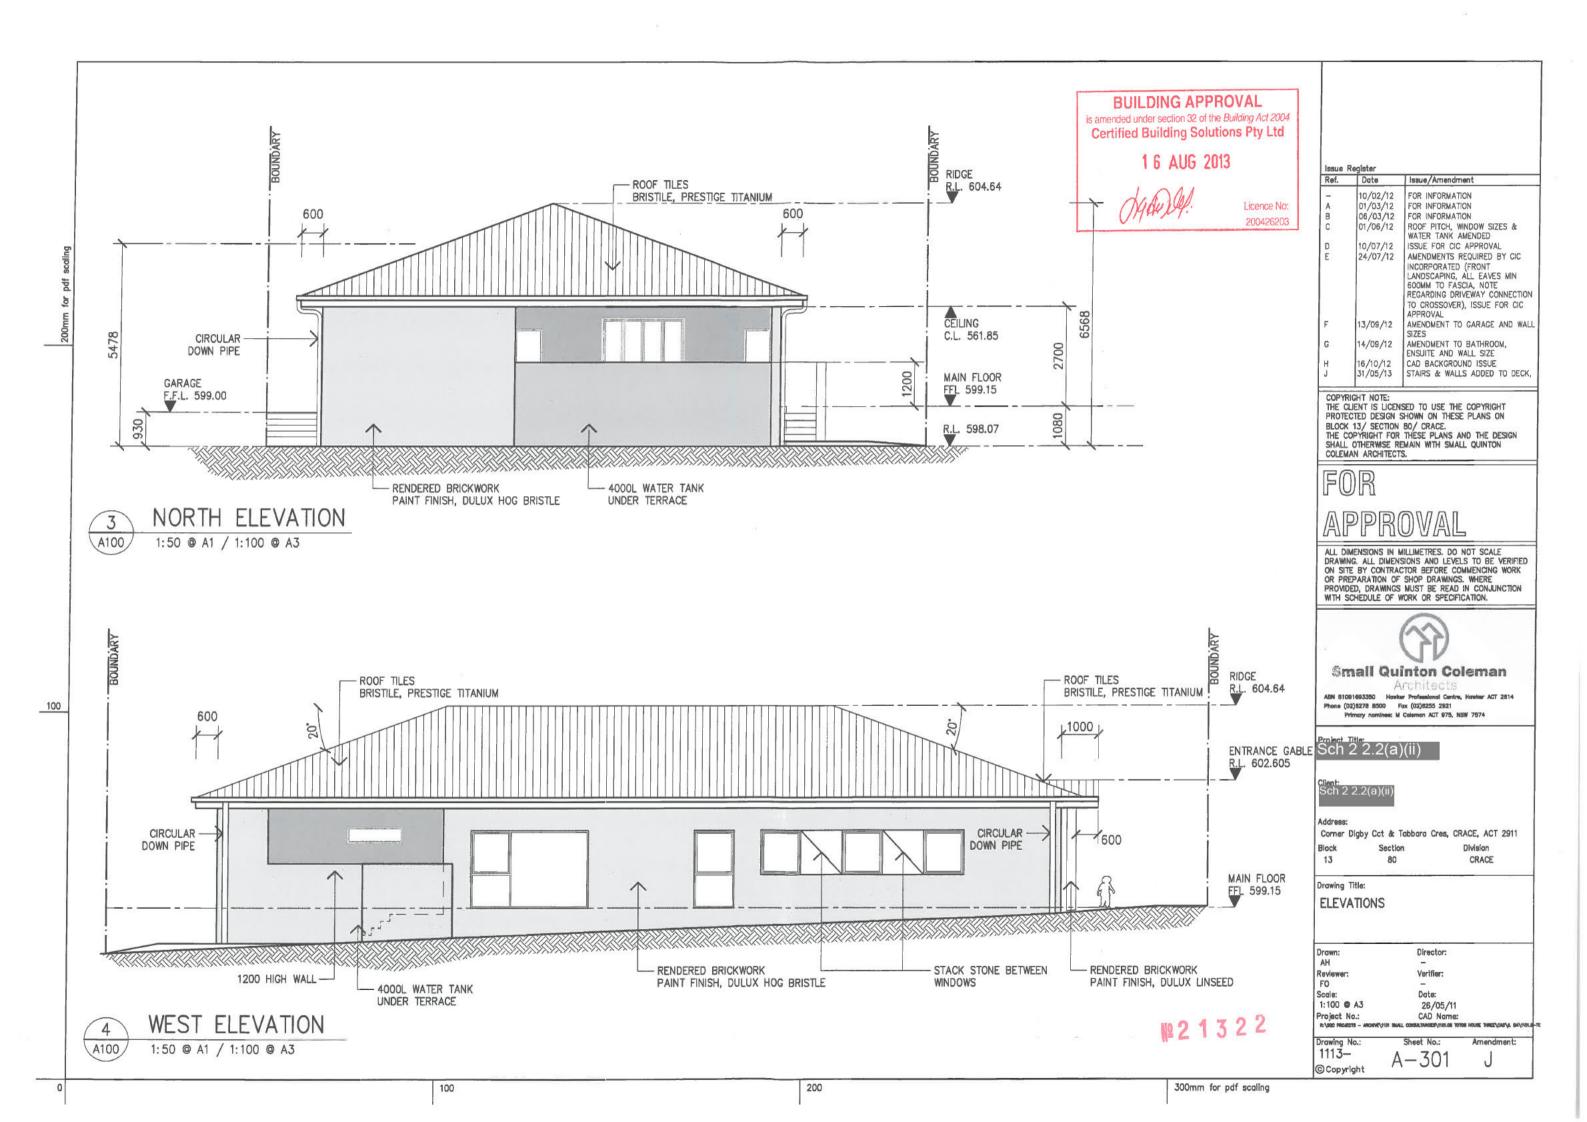

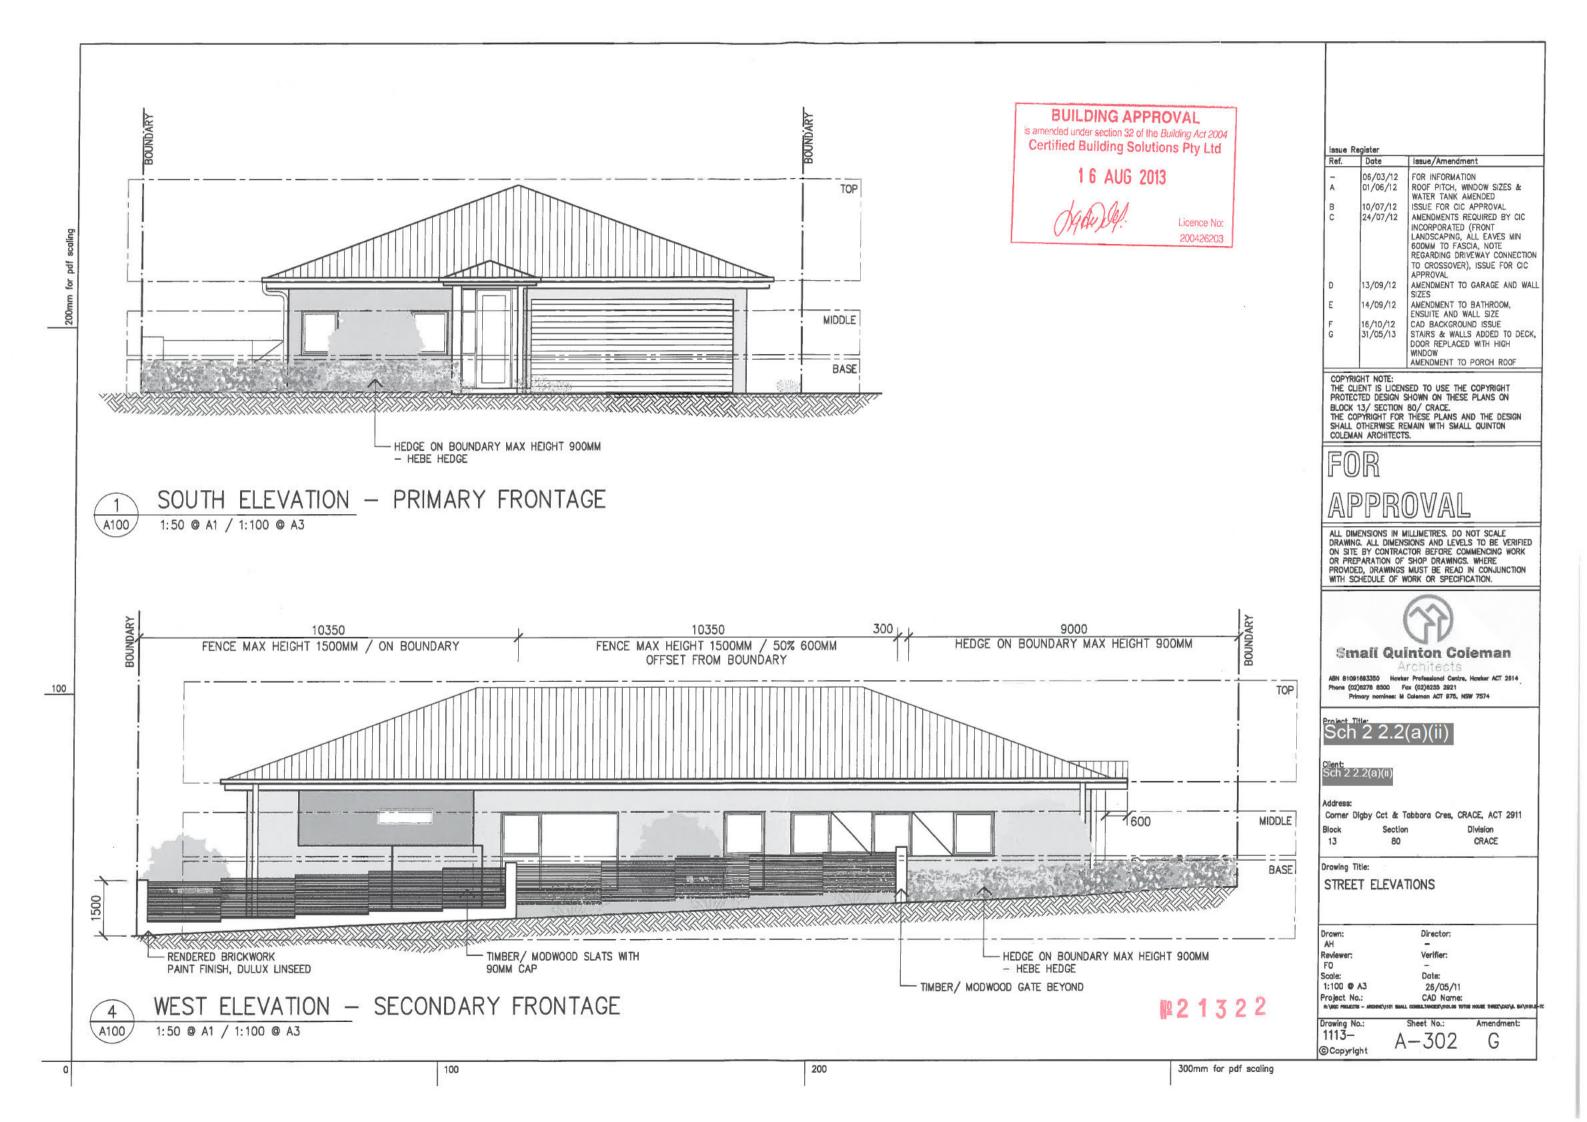

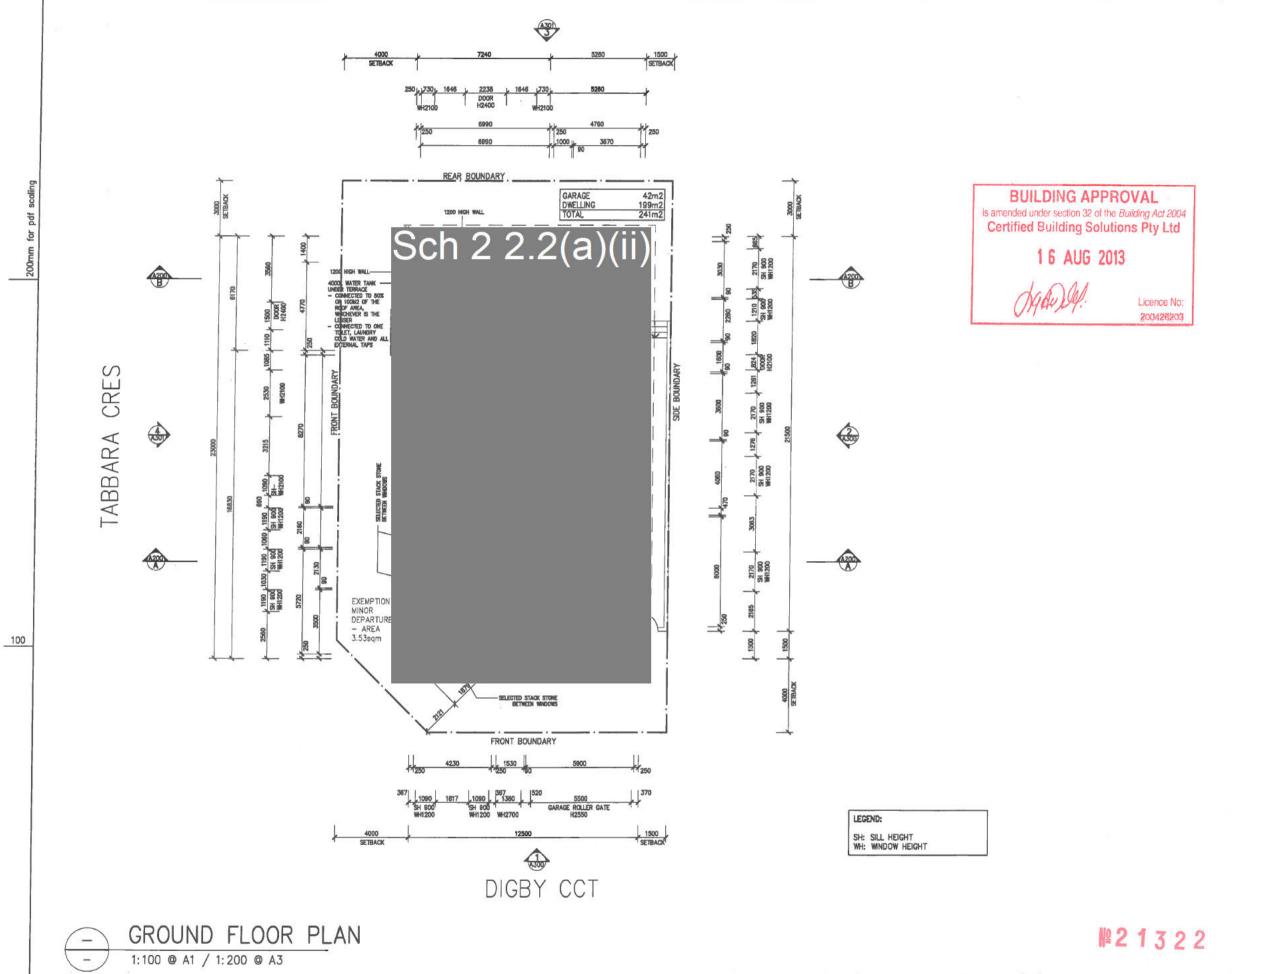



Ref.	Date	Issue/Amendment
D E	10/07/12 24/07/12	ISSUE FOR CIC APPROVAL AMENDMENTS REQUIRED BY CIC INCORPORATED (FRONT LANDSCAPING, ALL EAVES MIN 600MM TO FASCIA, NOTE REGARDING DRIVEWAY CONNECTION TO CROSSOVER), ISSUE FOR CIC APPROVAL
F	22/08/12	GARAGE NOMINATED AS MINOR DEPARTURE, REQUIRING ACTPLA APPROVAL, WATER TANK NOTE ADDED
G	13/09/12	AMENDMENT TO GARAGE AND WALLSIZES
Н	14/09/12	AMENDMENT TO BATHROOM, ENSUITE AND WALL SIZE
J	16/10/12	CAD BACKGROUND ISSUE
K	31/05/13	STAIRS & WALLS ADDED TO DECK, DOOR REPLACED WITH HIGH

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Small Quinton Coleman

ABN 81091893350 Howker Professional Centre, Howker ACT 2814
Phone (02)8278 8500 Fax (02)8255 2921 Primary nominee: M Coleman ACT 975, NSW 7574

Project Title: Sch 2 2.2(a)(ii)

Client: Sch 2 2.2(a)(ii

Address:

Corner Digby Cct & Tabbara Cres, CRACE, ACT 2911 Division

Block 13

CRACE

Drawing Title:

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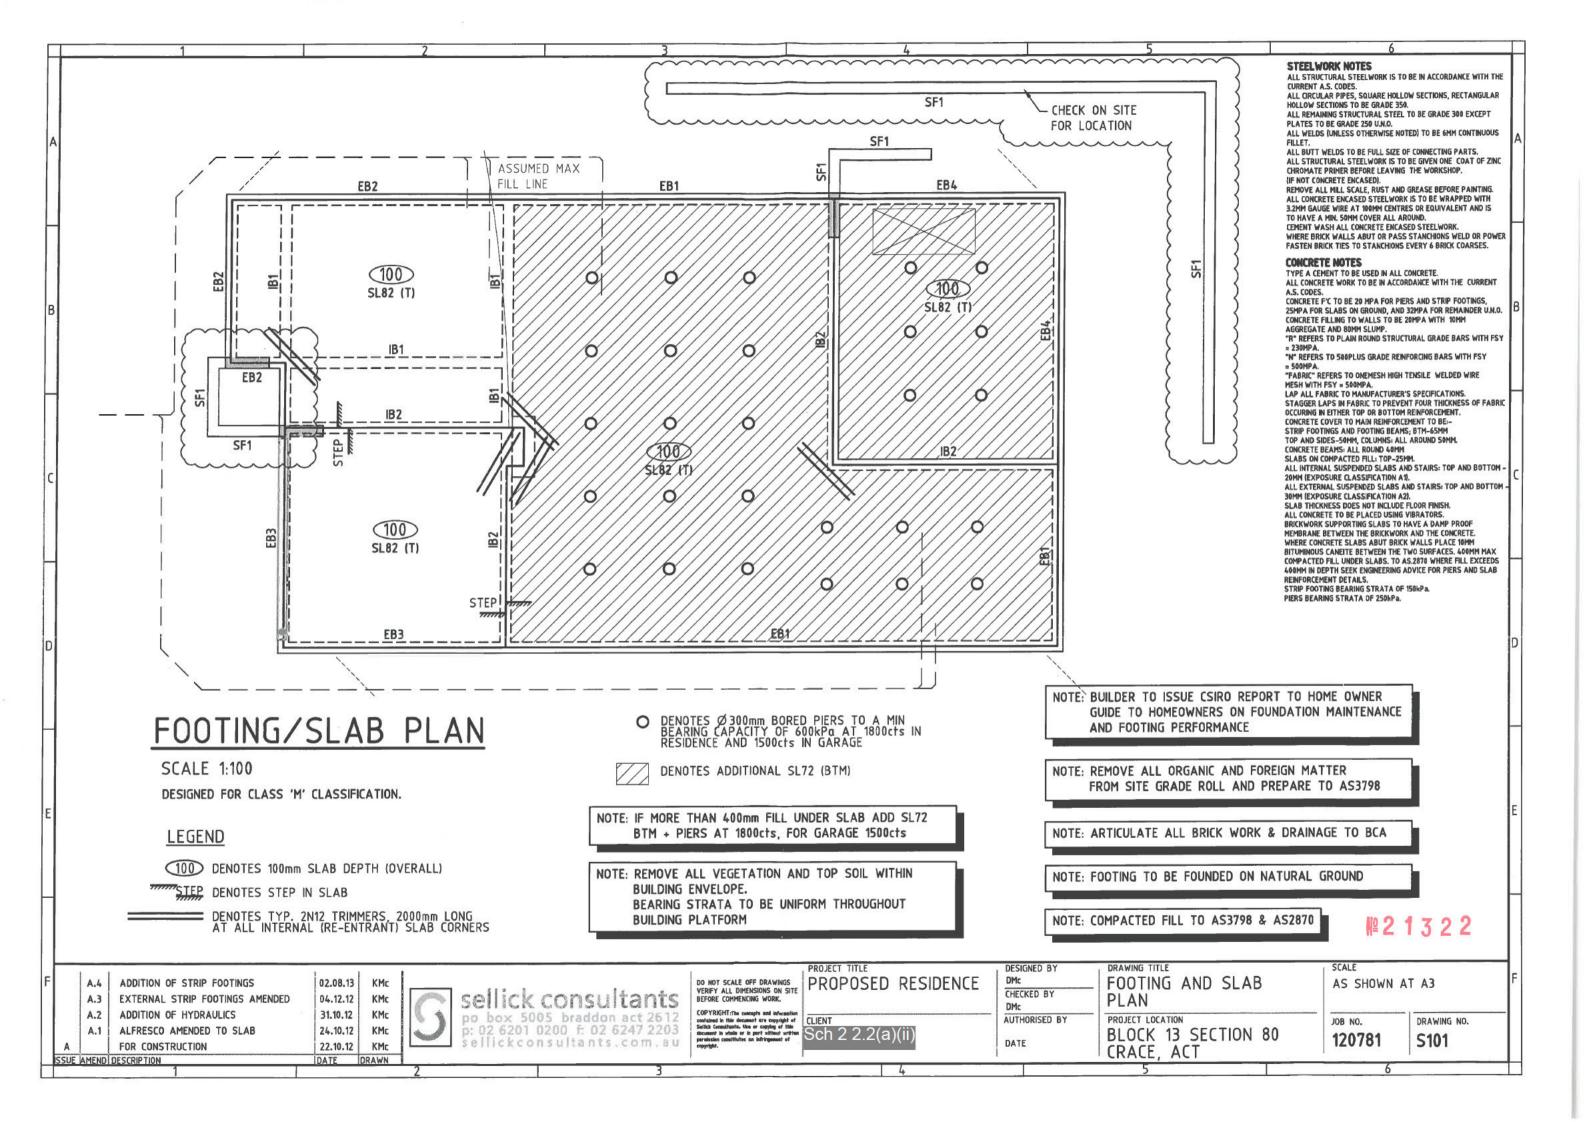
GROUND FLOOR PLAN


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Drawing No. A - 100K

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	Issue	Reg	ister
-1	Ref.	\neg	Dat

Ref.	Date	Issue/Amendment
A	01/06/12	ROOF PITCH, WINDOW SIZES & WATER TANK AMENDED
В	10/07/12	ISSUE FOR CIC APPROVAL
С	24/07/12	AMENDMENTS REQUIRED BY CIC INCORPORATED (FRONT LANDSCAPING, ALL EAVES MIN 600MM TO FASCIA, NOTE REGARDING DRIVEWAY CONNECTION TO CROSSOVER), ISSUE FOR CIC APPROVAL
D	20/08/12	VERGE AND VERGE CROSSING SHOWN
E	22/08/12	GENERAL NOTES ADDED
F	13/09/12	AMENDMENT TO GARAGE AND WALL SIZES
G	14/09/12	AMENDMENT TO BATHROOM, ENSUITE AND WALL SIZE
H	16/10/12	CAD BACKGROUND ISSUE
J	31/05/13	STAIRS & WALLS ADDED TO DECK, DOOR REPLACED WITH HIGH WINDOW

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Small Quinton Coleman

ABN 81091693350 Howker Professional Centre, Howker ACT 2814 Phone (02)8278 8500 Fax (02)8255 2921 Primary nominee: M Coleman ACT 975, NSW 7574

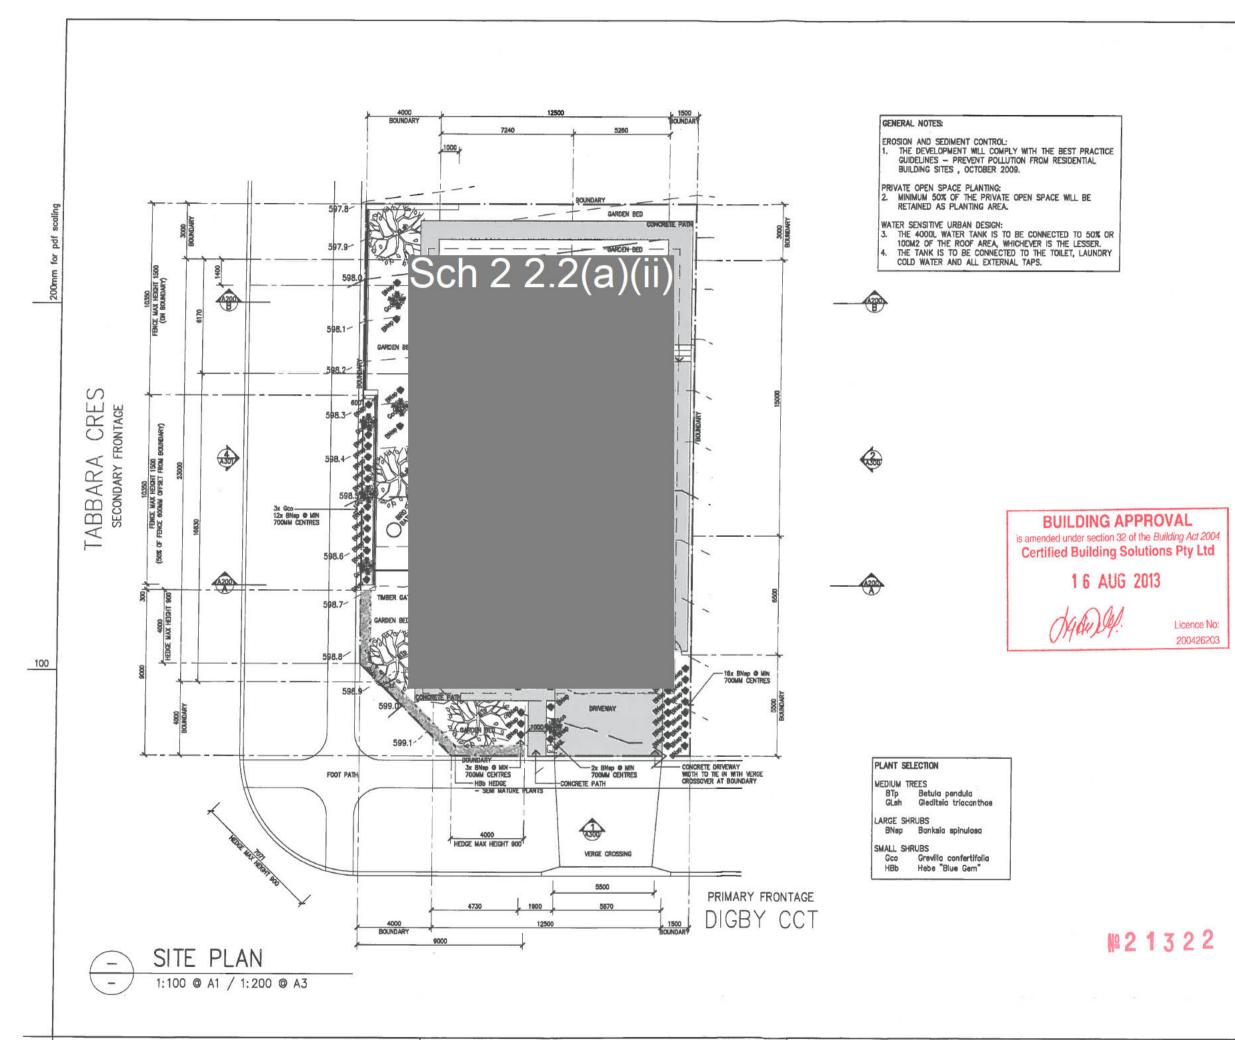Sch 2 2.2(a)(ii)

Address:

Corner Digby Cct & Tabbara Cres, CRACE, ACT 2911 Block Division Section


CRACE

13

Drawing Title: SITE PLAN

Director: Verifier: FO Scale: Date: 1:200 C A3 26/05/11 Project No.: CAD Name:

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1	Issue	Reg	ist

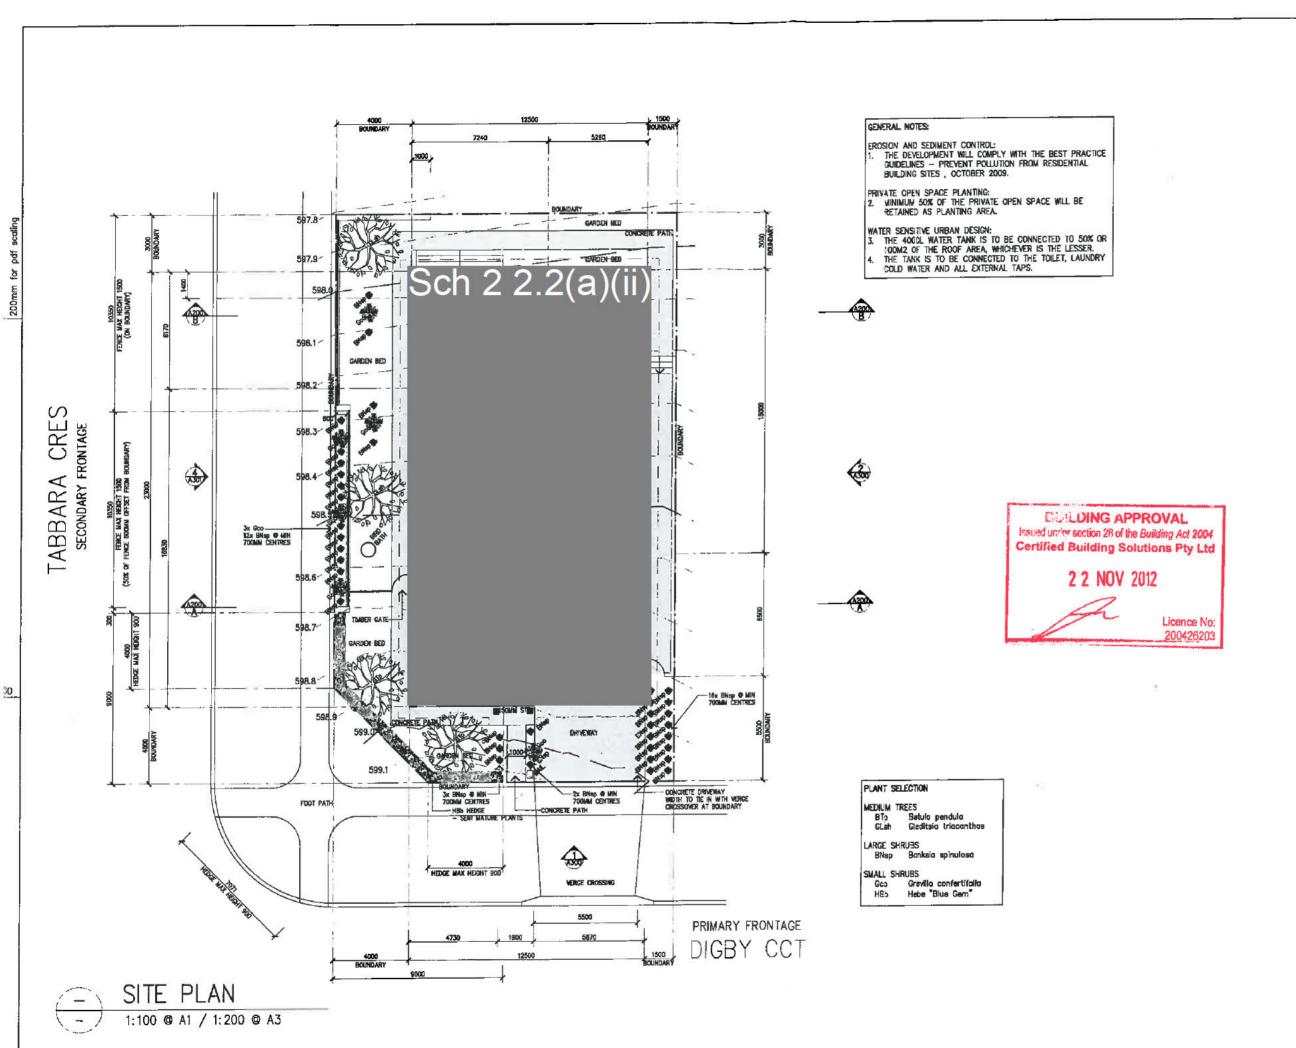Date	Issue/Amendment
06/03/12	FOR INFORMATION
01/06/12	ROOF PITCH, WINDOW SIZES & WATER TANK AMENDED
10/07/12	ISSUE FOR CIC APPROVAL
24/07/12	AMENDMENTS REQUIRED BY CIC INCORPORATED (FRONT LANDSCAPING, ALL EAVES MIN 600MM TO FASCIA, NOTE REGARDING DRIVEWAY CONNECTION TO CROSSOVER), ISSUE FOR CIC APPROVAL
20/08/12	VERGE AND VERGE CROSSING SHOWN
22/08/12	GENERAL NOTES ADDED
13/09/12	AMENDMENT TO GARAGE AND WALL SIZES
14/09/12	AMENDMENT TO BATHROOM, ENSUITE AND WALL SIZE
	06/03/12 01/06/12 10/07/12 24/07/12 20/08/12 22/08/12 13/09/12

APPROVAL

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Small Quinton Coleman

Architects

ASN 81091933350 Howker Professional Centre, Healer ACT 2614 Phone (02)9276 8500 Fox (02)9255 2921 Primary homines: M Coloman ACT 975, NSW 7574



Client: Sch 2 2.2(a)(ii

Corner Digby Cct & Tabbara Cres, CRACE, ACT 2911

Block 13

G

Drawing Title: SITE PLAN

Raviewer: FO Scole:

1:200 O A3 Project No.:

Date: 26/05/11 CAD Name:


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Issue/Amendment FOR INFORMATION FOR INFORMATION 06/03/12 FOR INFORMATION 01/06/12 ROOF PITCH, WINDOW SIZES & WATER TANK AMENDED ISSUE FOR CIC APPROVAL 10/07/12 24/07/12 AMENDMENTS REQUIRED BY CIC INCORPORATED (FRONT
LANDSCAPING, ALL EAVES MIN
600MM TO FASCIA, NOTE
REGARDING DRIVEWAY CONNECTION
TO CROSSOVER), ISSUE FOR CIC APPROVAL
AMENDMENT TO GARAGE AND WALL
SIZES 13/09/12 AMENDMENT TO BATHROOM, ENSUITE AND WALL SIZE 14/09/12

FOR

APPROVAL

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Small Quinton Coleman

Architects
ABN 61081683350 However Professional Centre, However ACT 2814
Phone (02)8278 8500 Fax (02)8285 2921
Primary norsinee: M Collectual ACT 976, NSW 7574

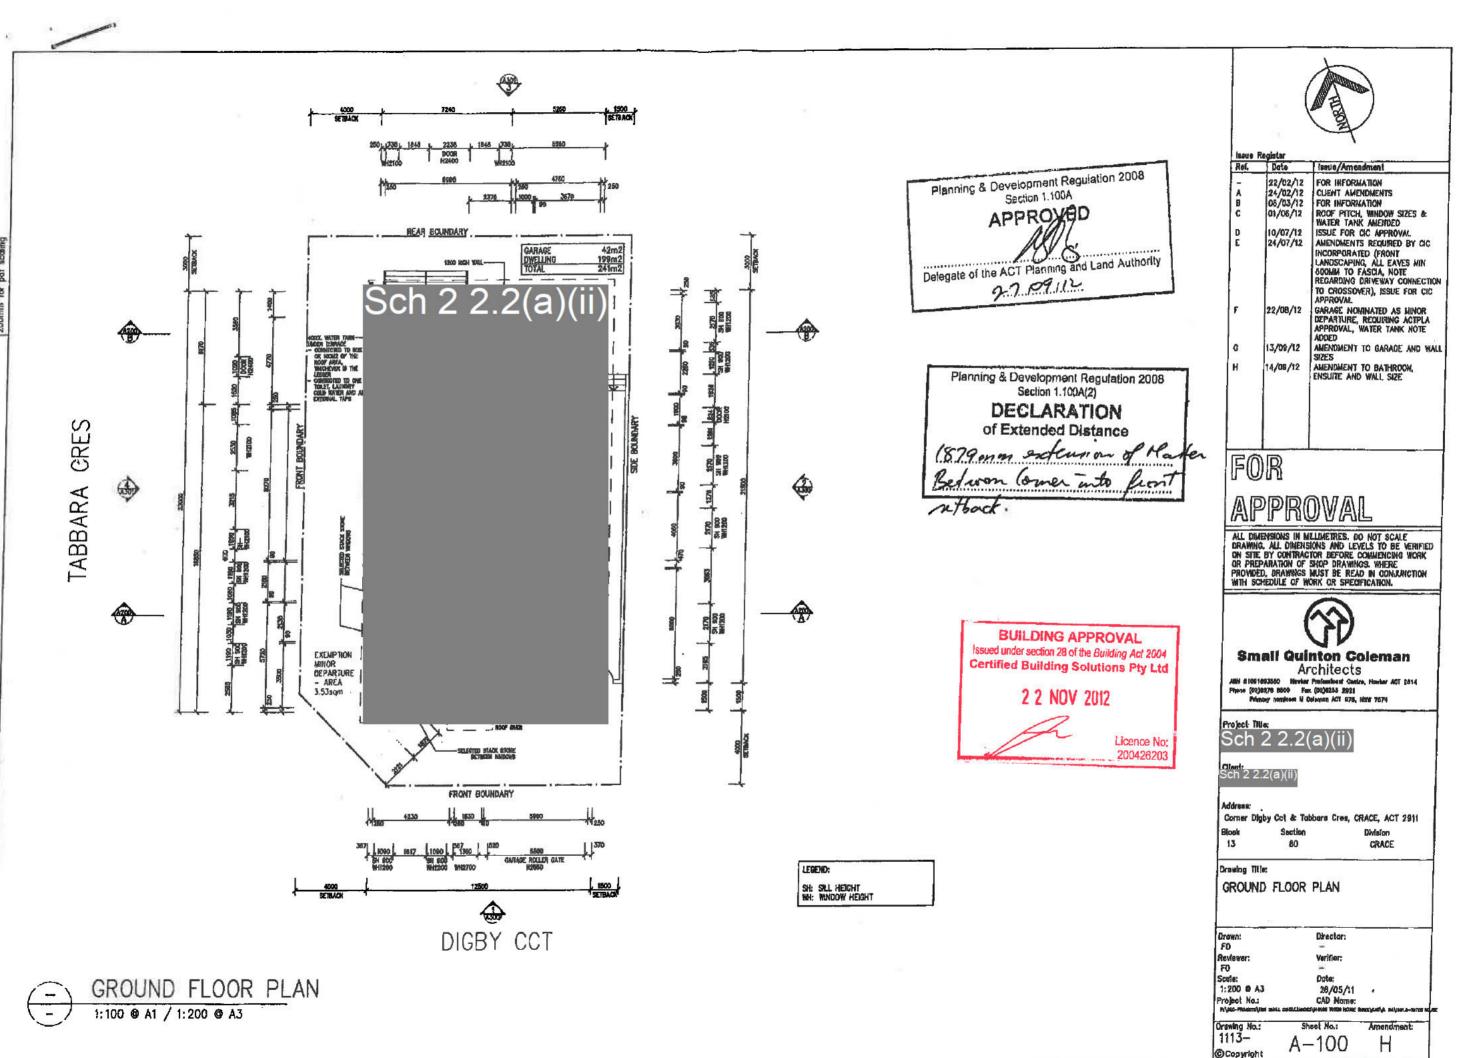Project Title: Sch 2 2.2(a)(ii)

Client: Sch 2 2.2(a)(ii)

Corner Digby Cct & Tabbora Cres, CRACE, ACT 2911

CRACE

Drawing Title:

ROOF PLAN

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Reviewer Verifier: FO Scale: Date:

1:200 0 A3 26/05/11 Project No.: CAD Name:

Drawing No.

G

3 NOTE: 1. TYPICAL ROOF PITCH 20 DEG

DIGBY CCT

ROOF PLAN 1:100 @ A1 / 1:200 @ A3

TABBARA CRES

20

300mm for pdf scaling


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BUILDING APPROVAL

Issued under section 28 of the Building Act 2004 Certified Building Solutions Pty Ltd

2 2 NOV 2012



From: Jeffrey, David

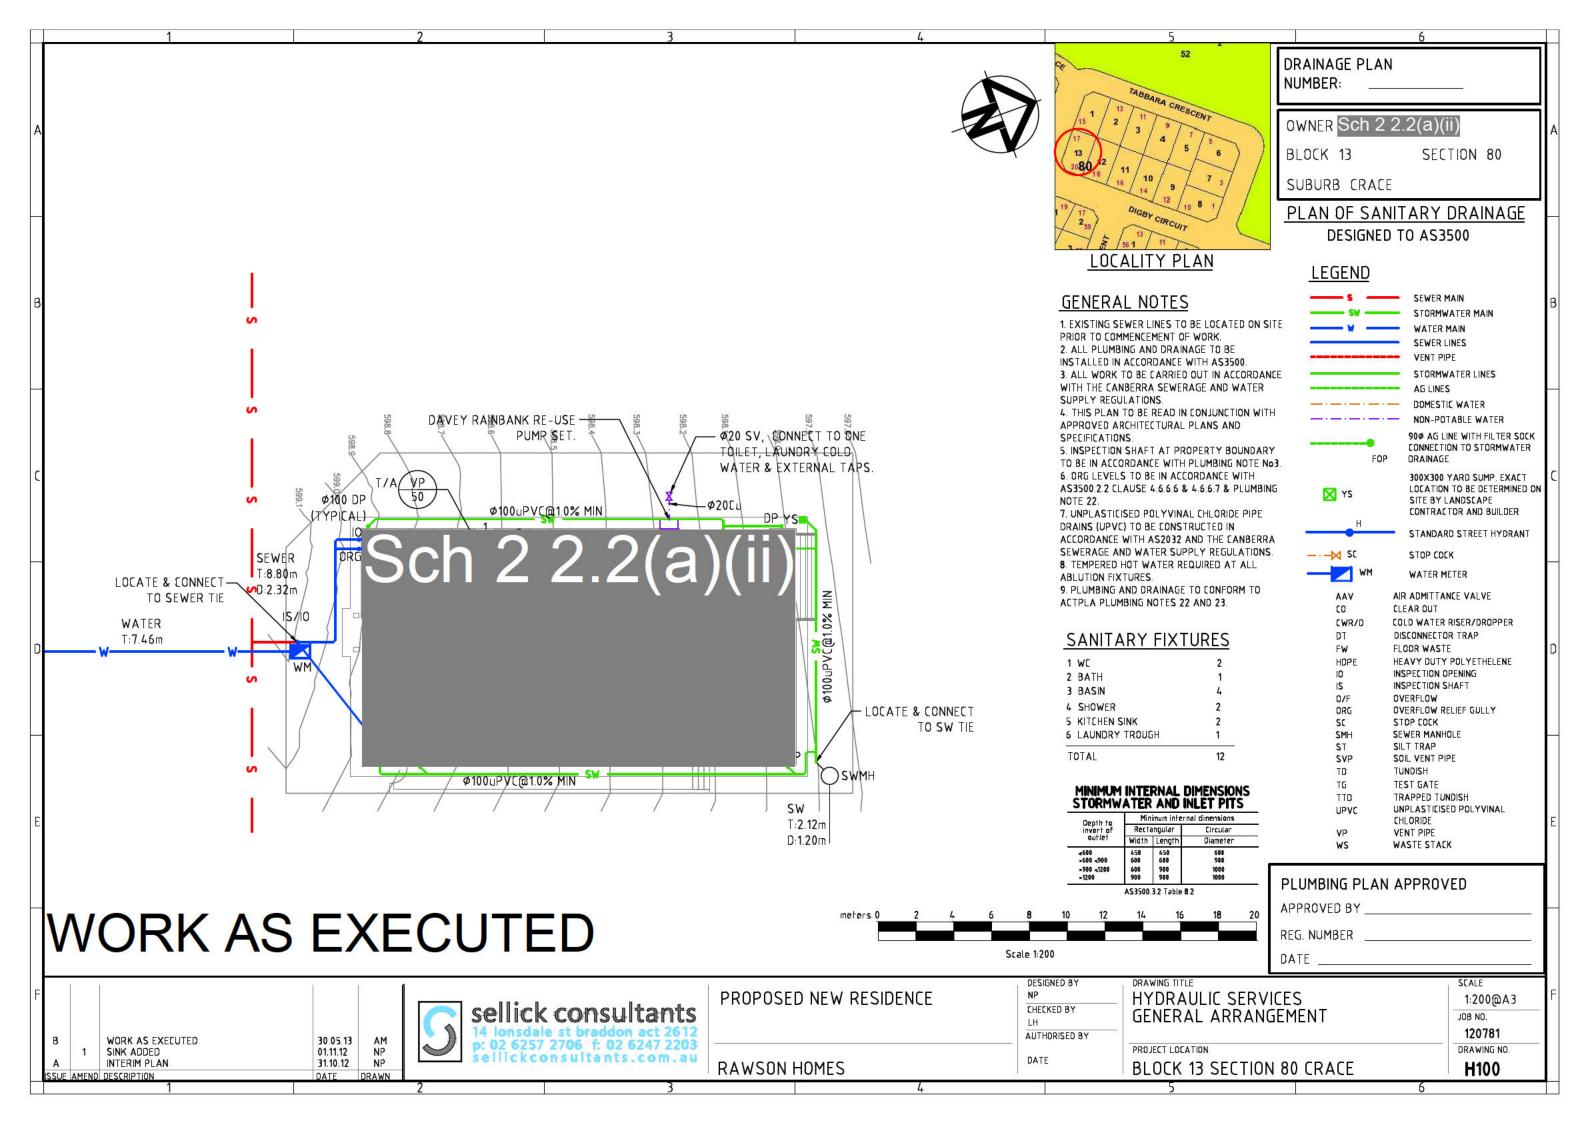Sent: Monday, 23 November 2009 4:45 PM

To: Marriage, Sue

Cc: Kelley, Rebecca; Rand, Rick

Subject: Community Recreation Irrigated Park

Importance: High

Hi Sue,

As discussed, please find attached the current landscape plan for the proposed Neighbourhood Oval in Crace. Rick and I have another meeting with Canberra Investment Corporation (CIC) this Thursday (26 November) to ratify the design and use of this facility.



As you aware, the provision of Neighbourhood Ovals has proven to be a flawed model in the ACT. SRS has floated the idea with CIC that we would prefer to forego the Neighbourhood Oval in preference for the provision of a smaller informal recreation space, what we are calling a Community Recreation Irrigated Park (CRIP). This concept is contained in the *Future Provision of Sportsgrounds in the ACT* paper that we are currently working on. For the meeting with CIC on Thursday, it would be great if we could get in principle support from the Minister to redesign the facility at Crace to become a CRIP.

In suggesting that Neighbourhood Ovals should be removed from the sportsground provision model, SRS is not suggesting that green (irrigated) open space does not have intrinsic value from a community health and physical recreation perspective. SRS is suggesting that a Community Recreation Irrigated Park should be approximately 0.75 to 1.0 hectare in size. Ideally the facility would be co-located next to or near a pond or body of water that could be utilised, in full or partially, to irrigate a drought tolerant turf species (e.g. couch). The use of non potable water and drought tolerant grass will reduce the operational cost to maintain these facilities, therefore making the concept more viable.

There is much research to suggest that open space planning and key design principles can have a positive effect on the physical and mental state of local residents. Healthy Spaces and Places is a landmark project that was developed to demonstrate the importance of taking a national perspective to:

- managing our environments, particularly how the physical characteristics of where Australians live, work and play can influence their physical and mental health and wellbeing;
- investing in Australia's future health and wellbeing;
- reducing health costs by preventive measures;
- fostering collaborative partnerships; and
- supporting social connectiveness.

Healthy Spaces and Places is a unique collaboration between the Australian Local Government Association, the National Heart Foundation of Australia and the Planning Institute of Australia, with funding support provided by the Department of Health and Ageing (refer to - http://www.healthyplaces.org.au/site/index.php).

Aesthetics is a critical design component that needs to be addressed in the construction and maintenance of passive recreation spaces. The climatic conditions in Canberra require turf to be irrigated in order for it to remain alive and healthy. Parks that are not irrigated offer little or no value to the community in terms of providing an open space that encourages recreational use, especially during the summer period.

Further background information in relation to what a CRIP may look like is detailed below. For the purposes of this exercise, I have also included a very simple design concept.

Community Recreation Irrigated Park (CRIP)

In suburbs where there is no District Playing Field, District Park or School Oval, a Community Recreation Irrigated Park will be provided. Generally 0.75 to 1.0 hectare, this space will provide an irrigated low maintenance play space to support informal physical activity and recreation activities. Where possible, will be connected to a non potable water source for irrigation purposes and utilise a drought tolerant grass species (e.g. couch).

As a guide a Community Recreation Irrigated Park would generally include the provision of a toilet block, community barbeque and picnic shelter. Other facilities that could also be considered include the provision of a children's playground, basketball half court, tennis wall and cricket nets. A variety of low maintenance, drought tolerant tree species should also be provided from an aesthetic perspective and to provide shade.

It should be noted that the irrigated grass area does not need to be uniform in its shape or design, but it should be large enough to accommodate a range of informal recreation pursuits and activities.




Let me know if you require any further information.


Cheers

David Jeffrey

Manager Strategic Projects and Planning Sport and Recreation Services Territory and Municipal Services

P: (02) 6207 5815 F: (02) 6207 2071 M: 0417 499 634

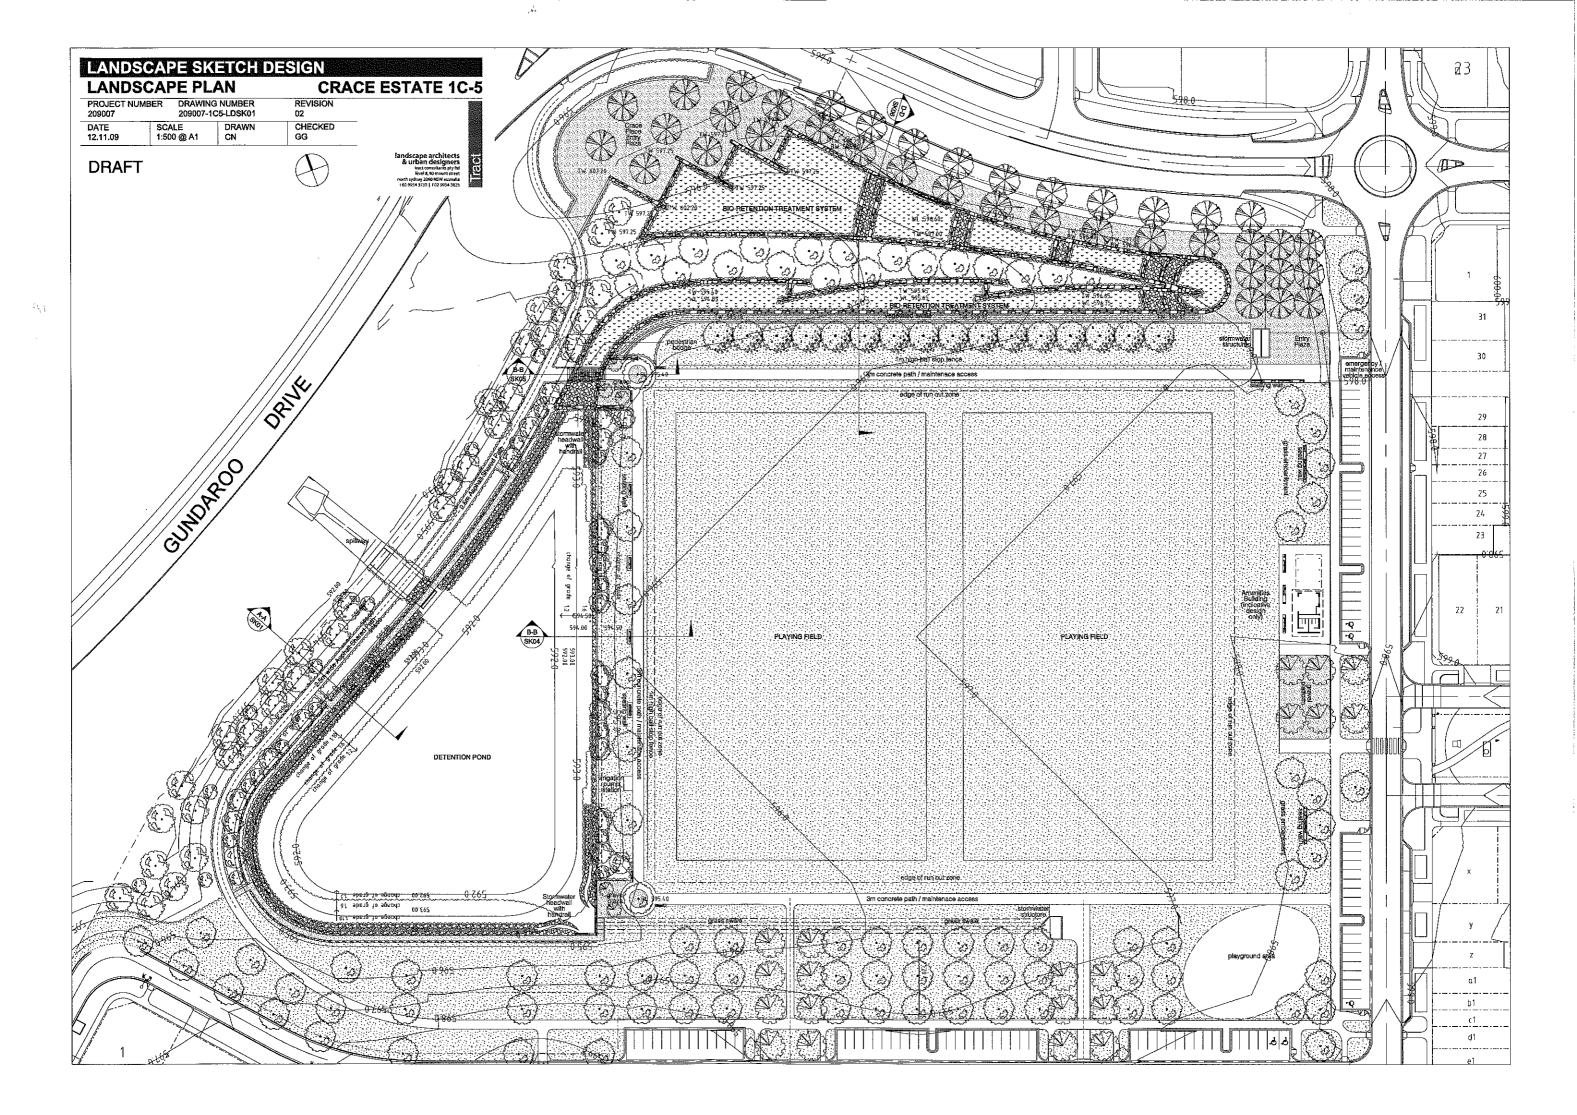

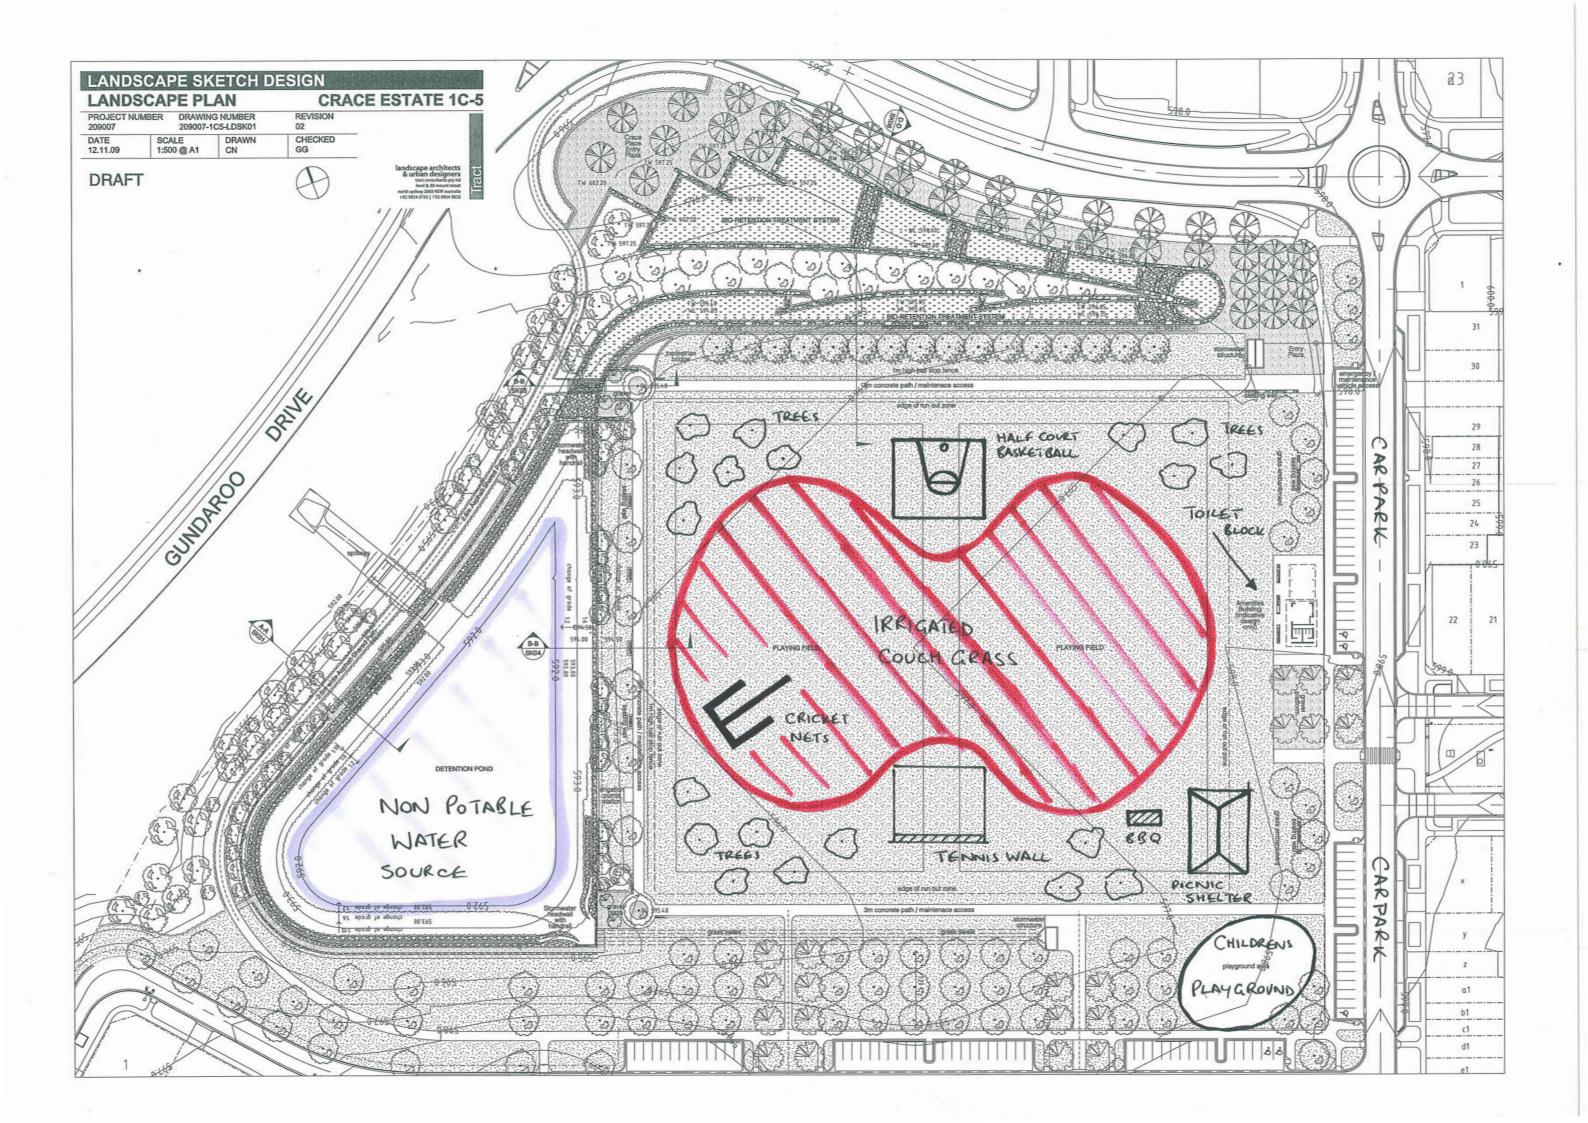

From: Sch 2 2.2(a)(ii)

Sent: Wednesday, 25 November 2009 10:07 AM

To: Jeffrey, David

Cc: Rand, Rick; Ian Dawkins

Subject: Crace - Community Recreation Irrigated Park

David

Thank you for the information. We shall utilise this and do some brief sketches.

Given the timing we'd need to work with you to achieve a reasonably confident agreement that a CRIP concept could be undertaken inline of the current neighbourhood oval required under the Deed of Agreement with ACTPLA. This would have to be achieved prior to Christmas so detailed designs could commence immediately in the new year together with any EDP/DA amendments.

Our current program is to commence construction activities on the oval in march 2010 with grassing being undertaken in the spring of 2010. With the possible change to concept we could accept works to commence in June /July with grassing in the early autumn of 2011 if not slightly earlier. For this the detailed designs would need to commence very early in 2010 as noted above.

Regards



From: Jeffrey, David [mailto:David.Jeffrey@act.gov.au]

Sent: Friday, 20 November 2009 1:22 PM

To: Sch 2 2.2(a)(ii) **Cc:** Rand, Rick

Subject: Community Recreation Irrigated Park

Hi Mitch,

As briefly discussed today, please find the draft documentation that Sport and Recreation Services (SRS) has put together to date in relation to the Community Recreation Irrigated Park (CRIP) concept. Most of the sportsground and irrigation design standards would still be applicable for this concept.

Community Recreation	In suburbs where there is no District Playing Field, District Park or School Oval, a
Irrigated Park (CRIP)	Community Recreation Irrigated Park will be provided. Generally 0.75 to 1.0 hectare,
	this space will provide an irrigated low maintenance play space to support informal
	physical activity and recreation activities. Where possible, will be connected to a non

potable water source for irrigation purposes and utilise a drought tolerant grass species (e.g. couch).

As a guide a Community Recreation Irrigated Park would generally include the provision of a toilet block, community barbeque and picnic shelter. Other facilities that could also be considered include the provision of a children's playground, basketball half court, tennis wall and cricket nets. A variety of low maintenance, drought tolerant tree species should also be provided from an aesthetic perspective and to provide shade.

It should be noted that the irrigated grass area does not need to be uniform in its shape or design, but it should be large enough to accommodate a range of informal recreation pursuits and activities.

It would great if you could let us know when you need a decision by regarding what type of facility is ultimately to be provided as part of the Crace EDP.

Let me know if you require any further information.

Kind regards,

David Jeffrey

Manager

Strategic Projects and Planning Sport and Recreation Services

Territory and Municipal Services

P: (02) 6207 5815 F: (02) 6207 2071 M: 0417 499 634

This email, and any attachments, may be confidential and also privileged. If you are not the intended recipient, please notify the sender and delete all copies of this transmission along with any attachments immediately. You should not copy or use it for any purpose, nor disclose its contents to any other person.

From: Jeffrey, David

Sent: Wednesday, 16 December 2009 9:54 AM

To: McPhail, Sean

Cc: Marriage, Sue; Kelley, Rebecca; Rand, Rick

Subject: Crace Playing Field

Attachments: 20091123150601783_0001.pdf

Hi Sean,

SRS is supportive of the shift to provide a Community Recreation Irrigated Park (CRIP) as part of the CIC Limited development at Crace. I can confirm that SRS has had a couple of meetings with CIC Limited regarding the CRIP concept. The attached plan (better quality copy is attached) was provided to CIC Limited as a very basic starting point to commence the redesign process. It is also worth noting that the Minister for Sport (Andrew Barr) is supportive of the CRIP concept.

Please let me know if you require any further information.

Regards,

David Jeffrey

Manager Strategic Projects and Planning Sport and Recreation Services Territory and Municipal Services

P: (02) 6207 5815 F: (02) 6207 2071 M: 0417 499 634

From: McPhail, Sean

Sent: Tuesday, 15 December 2009 3:33 PM

To: Rand, Rick

Cc: Gianakis, Steven; Brooker, Ron; Billing, Dale

Subject: Crace Playing Field

Rick,

As discussed in our phone conversation, attached is the plan received detailing the change of direction for the Crace neighbourhood playing field.

ACTPLA is currently considering an amendment to the Crace Stage 1 Estate Development Plan to formalise the development of this site. The site has been identified as a neighbourhood playing field in accordance with the Crace Precinct Code and the executed Deed of Agreement. I understand that Sport and Recreation do not support the development of this site as a neighbourhood playing field due to its small size and the lack of a primary school within the suburb of Crace. It is understood that Sport and Recreation prefer the site to be developed as an irrigated community recreation park as detailed in the attached plan.

Can you please provide written confirmation from your branch to confirm support for this change to the Crace neighbourhood playing field. Can you also confirm whether the attached plan has been discussed twitch CIC Limited. ACTPLA will require written confirmation prior to discussing further with CIC Limited and requesting revisions to the plans lodged for the site.

Additionally, are you able to provide a better quality copy of the attached plan?

Regards

Sean McPhail

Technical Coordinator

Estates Assessment Unit Development Services Branch ACT Planning and Land Authority

Ph. (02) 62052874 sean.mcphail@act.gov.au **From:** Jeffrey, David

Sent: Wednesday, 10 March 2010 10:01 AM

To: Rand, Rick; Ashcroft, Brian

Subject: FW: CRIPS at Crace

Tracking: Recipient Read

 Rand, Rick
 Read: 10/03/2010 10:11 AM

 Ashcroft, Brian
 Read: 10/03/2010 10:59 AM

FYI

From: Kelley, Rebecca

Sent: Tuesday, 9 March 2010 11:07 AM

To: Jeffrey, David

Subject: FW: CRIPS at Crace

An answer....!!

From: Perram, Phillip

Sent: Friday, 5 March 2010 6:19 PM

To: Marriage, Sue

Cc: Kelley, Rebecca; Corey, Janelle **Subject:** FW: CRIPS at Crace

Sue

Further to the CRIP for Crase

Please see Kelvin's comments below

Regards

Phillip

Phillip Perram
Executive Director - Territory Services
Territory and Municipal Services
Telephone (02) 6207 2333
Mobile 0435 659 263

From: Walsh, Kelvin

Sent: Friday, 5 March 2010 5:14 PM

To: Perram, Phillip

Cc: Gianakis, Steven; Murray, Chris; McPhail, Sean; Ponton, Ben; Wilden, Karen

Subject: CRIPS at Crace

Phillip,

Just to follow up on our conversation yesterday. We met with CIC on 09 Feb 2010 regarding the CRIP at Crace and ACTPLA's inability to approve an EDP that did not meet the Territory Plan requirements (ie demonstrate ability to deliver a Basic Sports Unit on the site).

We discussed:

- our understanding of Govt's move to the CRIPS model and desire to deliver at Crace
- that the Territory Plan, through the Structure Plan, requires the delivery of a Basic Sports Unit
- that due to the requirements in the TP ACTPLA would not be able to approve an EDP that didn't demonstrate ability to deliver a Basic Sports Unit.
- that ACTPLA, together with Sport and Rec, was happy to review this requirement in the Territory Plan and that the process would take 12 - 18 months

It was agreed at the meeting that:

- CIC would lodge a new EDP DA that demonstrated ability to deliver a Basic Sports Unit and may also show and enable delivery of the CRIP
- that ACTPLA would engage with Sport and Rec with the aim of reviewing the TP so that a Basic Sport Unit may not be required
- that if the TP is varied, CIC would come back to ACTPLA and seek to amend the EDP to deliver the alternate scheme presented (ie CRIP and housing)
- in lodging the new EDP DA CIC would also need to demonstrate that Sport and Rec are happy with the proposed configuration

Status

- CIC have not lodged the EDP DA in line with what was discussed at the meeting
- ACTPLA will shortly commence discussions with Sport and Rec regarding the TP review process in relation to this matter.

Happy to discuss further if anything requires clarification.

Kind regards Kelvin.

Kelvin Walsh

Director Planning Services ACT Planning and Land Authority telephone 02 6207 1950 e-mail kelvin.walsh@act.gov.au

Please respect the environment and think about the impact of printing this email.

From: Jeffrey, David

Sent:Tuesday, 16 March 2010 12:59 PMTo:Kelley, Rebecca; Marriage, SueSubject:FW: Crace - Community Park

Attachments: FW: CRIPS at Crace

Tracking: Recipient Read

Kelley, Rebecca Read: 16/03/2010 2:48 PM

Marriage, Sue

Hi Sue/Bec.

I need to respond to Jacqui Lavis (GHD) regarding this, can we please discuss when you have a chance. I have also attached Kelvin Walsh's email regarding Crace.

Cheers DJ

From: Sch 2 2.2(a)(ii)

Sent: Friday, 12 March 2010 1:01 PM

To: Jeffrey, David **Cc:** Marriage, Sue

Subject: Crace - Community Park

Hi David,

Thanks for meeting with me regarding the Crace Park.

The next step for CIC will be to submit a new development appliaction for the area of the site that comprises the parkland and the new residenital blocks

We would like to have Sport and Rexcreation support for the park concept before lodgement

Our understanding of the current issues to be addressed are as follows

The Territory Plan 2008

Territory Plan - Definitions

Playing field means the use of land which is unrestricted to public access and which is used for the conduct of sports, athletics and games and includes facilities with such land for the enjoyment or convenience of the public such as kiosks, car parks, changing facilities, pavilions and the like.

Gungahlin – Suburb of Crace Structure Plan

A structure plan has been produced for the suburb of Crace. There is a specific policy in relation to playing fields:

Provide playing fields (neighbourhood oval consisting of a Basic Sports Unit)

There is no definition provided for "Basic Sports Unit".

Crace Concept Plan

A concept plan has been produced for the suburb of Crace. The structure plan 'playing field' policy has been adapted into the concept plan:

6.5 Open Space Provision

The Crace Concept Plan contains a hierarchy of open spaces totalling about 48Ha serving different purposes. The spaces are to be provided/ located generally in accordance with Important Planning Requirements and the Concept Plan.

A neighbourhood playing field (basic sports unit) is also to be provided within the suburb and form part of the open space network. The location of the playing fields is shown in the Important Planning Requirement plan.

Design Standard for Urban Infrastructure

These design standards are used by professionals involved in the planning, design and construction of Urban Infrastructure in the ACT.

DS 24 Sportsground Design

This design standard specifies requirements for sportsground within the ACT. The document provides the following relevant definitions:

24.3.1 Playing Field

The term playing field refers to the total area provided at any site or complex for organised sport. Playing fields usually comprise an irrigated playing surface and surrounds that may or may not be irrigated. Their size allows several options for field layout.

Sports field

The term sports field refers to the marked out area for one sport. A sportsfield can accommodate one game of Rugby, Soccer, Hockey, Australia Rules or Cricket depending on the marking.

Neighbourhood Oval

The term neighbourhood oval refers to playing field sporting facilities generally located adjacent to both a suburban primary school and the local shopping centre. Together the three land uses generate a focus of activity for the neighbourhood. Usage is predominantly, but not necessarily, by juniors for training and competition and by the primary school. Informal used by local residents is also significant.

Sporting clubs have adopted neighbourhood playing fields and pressures of use have resulted in the construction of toilet facilities in some cases. In order to accommodate future development, designs should identify a possible future toilet block site.

Training lights may be provided.

District Playing Fields

The term district playing field refers to sporting facilities that serve several suburbs and comprise a number of fields with at least one pavilion. They are often associated with a high school and have a total area of at least eight hectares. District playing fields area heavily used for senior and junior competition and training and commonly they become associated with one particular sporting code whereby several games can be played concurrently at the one venue, for ease of administration and organisation of voluntary officials.

These facilities are also heavily used for night time training under lights and appropriate lighting and other safety requirements are needed.

Conclusion

We have concluded that since "District Playing Fields" are provided in the neighbouring suburb of Palmerston, that a "playing field" as per 24.3.1 will satisfy the current requirement of both the Territory Plan and Design Standard for Urban Infrastructure

I would be grateful if you could confirm that if CIC resubmit with a plan showing an irrigated playing field area that you will endorse this concept as a referral authority, in the conetx of any EDP circulation. I would also be grateful if you could confirm whether such plan should show an area capable of being marked out for specific sports

Sch 2 2.2(a)(ii)

From: Gianakis, Steven

Sent: Friday, 30 April 2010 2:39 PM

To: Jeffrey, David

Cc: Kelley, Rebecca; Ashcroft, Brian **Subject:** RE: Crace and playing field - CRIP

ΑII

Thank you for your advice. I'm seeking a time with Kelvin to discuss ACTPLA's response to GHD's letter. I will advise of outcome prior to responding to GHD. thanks again.

Steven

From: Jeffrey, David

Sent: Friday, 30 April 2010 11:21 AM

To: Gianakis, Steven

Cc: Kelley, Rebecca; Ashcroft, Brian

Subject: RE: Crace and playing field - CRIP

Hi Steven,

Thanks for your email. I would like to provide the following comments for your consideration from a Sport and Recreation Services (SRS) perspective:

- SRS is committed to the development of a pilot Community Recreation Irrigated Park (CRIP) in Crace that
 meets the informal sport and physical recreation needs of the local community.
- The proposed model (Attachment 1) does meet the long term expectations of SRS in respect to what a CRIP should provide. SRS would support the proposed model as a Stage 1 concept should CIC agree to undertake a range of further improvements (Stage 2) sometime in the future at a time agreed by all parties. In particular. SRS would suggest that a greater range of facilities need to be accommodated/provided (e.g. toilet block, shelter, barbeque, tennis wall, basketball half court, cricket nets, etc). The cost of these improvements would need to be met by the developer (CIC).
- It should be noted that the proposed size of the open space detailed in Attachment 1 (90 x 60 metres) is not large enough to support any formal sporting activity. This is in accordance with the CRIP concept as this facility will not be available for groups to formally hire. The cost to maintain this facility will be reduced due to its smaller size.
- The relevant Design Standards for Urban Infrastructure will need to be applied (DS21 Irrigation, DS24 -Sportsground Design).

Please let me know if you require any further information.

Kind regards,

David Jeffrey Manager

Strategic Projects and Planning Sport and Recreation Services Territory and Municipal Services

P: (02) 6207 5815 F: (02) 6207 2071 M: 0417 499 634

----Original Message-----From: Gianakis, Steven

Sent: Monday, 19 April 2010 1:59 PM

To: Jeffrey, David

Subject: Crace and playing field - CRIP

Hi David

FYI - please find attached a letter received on the above. In essence, GHD is arguing that what is proposed in Attachment 1 meets both TaMS and ACTPLA requirements. Thus no Variation is required and they can lodge an estate development plan (subdivision) DA for the revised open space and additional dwellings. We have yet to review, as I have been too busy and Kelvin is away.

Any comments on the letter or it's logic?

Steven

From: Gianakis, Steven

Sent: Thursday, 6 May 2010 11:44 AM

To: Jeffrey, David

Cc: Kelley, Rebecca; Ashcroft, Brian **Subject:** RE: Crace and playing field - CRIP

ΑII

In response to the letter from GHD and your advice, I wish to advise the following:

- ACTPLA from a planning policy perspective is now supportive of a CRIP in Crace, in the first instance;
- No Territory Plan variation will be required to incorporate the CRIP into Crace.
- the developer will incorporate the CRIP into the proposed estate development plan development application (EDP DA) for the remaining unapproved area within Stage 1 of the Crace estate.
- Obviously the outcome is subject to EDP DA.
- Stephan Docherty advised me on 4th May 2010 that it is the developer's intention to deliver and fund the CRIP, not merely a "neighbourhood playing field" as indicated in the letter from GHD.
- The developer will need to discuss and seek your (Sport and Recreation Services) agreement to the specific details and facilities to be accommodated within the proposed CRIP for the EDP DA.
- I understand the developer is seeking a pre-development application meeting with ACTPLA to go through the EDP. Once I have details, I will forward for your attendance, if possible.

I will provide a copy of ACTPLA's response to GHD, once signed.

As discussed to permit the CRIP to proceed, you will need to have all necessary agreements in place with other areas of TaMS (eg. maintenance) to ensure that there are no delays through the DA process. Cheers.

Steven

From: Jeffrey, David

Sent: Friday, 30 April 2010 11:21 AM

To: Gianakis, Steven

Cc: Kelley, Rebecca; Ashcroft, Brian

Subject: RE: Crace and playing field - CRIP

Hi Steven,

Thanks for your email. I would like to provide the following comments for your consideration from a Sport and Recreation Services (SRS) perspective:

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- The relevant Design Standards for Urban Infrastructure will need to be applied (DS21 Irrigation, DS24 -Sportsground Design).

Please let me know if you require any further information. Kind regards,

David Jeffrey

Manager Strategic Projects and Planning Sport and Recreation Services Territory and Municipal Services

P: (02) 6207 5815 F: (02) 6207 2071 M: 0417 499 634

-----Original Message-----From: Gianakis, Steven

Sent: Monday, 19 April 2010 1:59 PM

To: Jeffrey, David

Subject: Crace and playing field - CRIP

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