

Freedom of Information Publication Coversheet

The following information is provided pursuant to section 28 of the *Freedom of Information Act 2016*.

FOI Reference: CMTEDDFOI 2019-048

Information to be published	Status
1. Access application	Published
2. Decision notice	Published
3. Documents and schedule	Published
4. Additional information identified	No
5. Fees	Waived
6. Processing time (in working days)	13
7. Decision made by Ombudsman	N/A
8. Additional information identified by Ombudsman	N/A
9. Decision made by ACAT	N/A
10. Additional information identified by ACAT	N/A

Bailey Kim.P on behalf of ACDLO CMTEDD FOI From:

To:

Tw: Correspondence From Minister Gentleman MLA - [DLM=For-Official-Use-Only] Tuesday, 26 February 2019 10:14:16 AM Subject:

Date: Attacl

Variation to territory plan crace 2.pdf ACT Geotechnical .png

ndence From Minister Gentleman MLA SECUNCLASSIFIED.msc

Importance:

Good morning FOI team,

Can I please pass this on to you to action FOI request?

I am also going to need some standard words that the Minister's office can go back to the constituent with stating that they have referred her request to the appropriate team to action.

Can you please come back to me?

Thanks in advance

Regards

Kim Bailev ACDLO - #54007

From: Landon, Daniel

Sent: Monday, 25 February 2019 12:15 PM To: EPSDD DLO < EPSDDDLO@act.gov.au> Cc: GENTLEMAN <GENTLEMAN@act.gov.au>

Subject: FW: Correspondence From Minister Gentleman MLA

Importance: High

Hi Erica

Please note the FOI request below.

I have been advised by the legal adviser in the Attorney-General's office that this is a matter that I can refer to EPSDD and/or Access Canberra to action.

Can EPSDD please:

• Advise if EPSDD and/or Access Canberra can action the request

 Draft a holding response that this office can send to to advise her of next steps.

Kind regards

Dan

From: GENTLEMAN

Sent: Tuesday, 19 February 2019 8:36 AM To: Landon, Daniel < Daniel.Landon@act.gov.au >

Subject: FW: Correspondence From Minister Gentleman MLA

Importance: High

Hey Dan,

Please see the email below for some context. has requested information under the FOI scheme. Can I get some advice on how to handle this

Kind Regards

Eben Leifer | Office Manager / Policy adviser

Office managers: Natasha Apostoloski (Mon-Wed), Eben Leifer (Thu-Fri)

Office of Mick Gentleman MLA

Member for Brindabella

Minister for the Environment and Heritage Minister for Planning and Land Management Minister for Police and Emergency Services

Minister assisting the Chief Minister on Advanced Technology and Space Industries

Manager of Government Business

t: 620 50218 | e: gentleman@act gov au

Please note that from 1 January 2018 ACT Government ministerial diaries are subject to publication on the ACT Government's open access website under section 23 of the Freedom of Information Act 2016.

Sent: Monday, 18 February 2019 7:47 PM To: GENTLEMAN < GENTLEMAN@act.gov.au> Cc: HANSON < HANSON@parliament act.gov.au>

Subject: Re: Correspondence From Minister Gentleman MLA

Importance: High

Dear Minister Gentleman,

thank you for your response to my email dated 16/11/18. I cannot express to you how upset I am by the current situation that I have been put in. I am so very disappointed in the ACT Government on how they are treating this matter.

I have been dealing with Reuben Gaze at Access Canberra, and have been advised that the Builder has been cleared of any wrong doing and the matter is now closed

As you are aware the issue I am having is that the ACT Land Development Agency and CIC Crace provided me with the WRONG soil classification, and from images provided by Access Canberra there appears that there was a creek line or waterway flowing through the block. I have recently contacted Fair Trading, The ACCC and lodged a complaint with the ACT Ombudsman (ref 2019-300-507). I was informed by Fair Traiding & the ACCC that Land Sales/Purchases still fall under the Consumer Law Act, and we are entitled to receive correct and accurate information. The information provided to me in my sales contract is for an 'M' Class Block & this is what I believed I was purchasing. Further investigation has determined that the block is actually a 'H1'. I would not have considered the purchase of this block if I new that the block had previously had a water way flowing through it and that the classification was a 'H1'. Under the Consumer Law Act I have been provided with false and misleading information

.consumerlaw.gov.au/files/2015/06/ACL_framework_overview.pdfPlanning and Development Act 2007

Can you confirm that the correct procedures were followed in relation to the development of the Suburb (Crace)? In particular, Section 80 as this was never in the original development plans of the suburb, this section was planned as being a playing field/oval/open space. Under the Freedom Of Information Act can you provide all information in relation to the removal of the playing field/oval/open space, when and if the amendment went to public consultation & if not how was the change approved, and was legislation on public consultation and technical amendments followed?.

Last year ACT Geotechnical Engineers dug 3 core samples from around my property. In there report they note that there is a layer of topsoil/slopewash below the controlled fill. I was informed that this could be contributing to the movement of the home and normally all topsoil would be removed before the fill is laid. Is it possible that the developers had prepared this area for the planned oval that was originally on the plans and not for residential use?

Excavation No. 2A **Excavation Log** Sheet 1 of 1 Job No. CLIENT: Sellick Consultants C9244 Location : See report Geotechnical Investigation **PROJECT** '80 Crace Surface Level: Not Known Equipment Type : Push Tube Excavation Dimensions : 50mm diameter Material Description, Structure Casing or Relative Density Geological Profile Test Metres CONCRETE GRAVELLY SAND/BASE COARSE; fine to coasre sand, gravels up to 20mm in size, 0.15 SANDY CLAY; high plasticity clay, fine to coarse sand, brown, some grey, moist 2A/1D DISTURBED SAMPLE FIRM TO STIFF SLOPEWASH/ STIFF TO VERY STIFF ALLUVIUM 2A/2D SANDY CLAY; high plasticity clay, fine to coarse sand, brown, some angular and rounded grayels up to 30mm in size, moist. None Encountered EXCAVATION TERMINATED AT 2m Logged By: MD Date: 19-4-18 Date: Checked By: **ACT Geotechnical Engineers**

Under the Freedom of Information Act I would like all information in relation to:

- Waterways and Creeks in Crace
- · Fill type, soil testing and regrading in section 80 Crace
- All Civil / Engineers reports and plans of Crace and in particular section 80 Crace
- All drainage plans including any inspection reports that have been done to check pipework in section 80 Crace

All I am asking is that the damage to my home is fixed by the responsible parties as the damages are a result of their negligence ie; LDA and CIC for providing

incorrect and misleading information

There has been some recent media attention around some defected units in Canberra & Parliament now has a committee in place looking into building defects. I will also forward this information onto Jeremy Hanson who is heading up the committee and perhaps they can add the LDA and CIC to the list of developers that they need to investigate

 $\underline{https://www.canberratimes.com.au/politics/act/scarred-by-the-experiee-actbuildingnightmares-revealed-20181001-p5074t.htm}\\$

I look forward to your response as this matter needs urgent attention

Kind Regards

On 16 Nov 2018, at 9:20 am, GENTLEMAN < GENTLEMAN@act.gov.au > wrote:

Dear ,

Please find the attached correspondence from Minister Mick Gentleman MLA.

Kind Regards,

Eben Leifer | Office Manager / Policy adviser

Office managers: Natasha Apostoloski (Mon-Wed), Eben Leifer (Thu-Fri)

Office of Mick Gentleman MLA

Member for Brindabella

Minister for the Environment and Heritage

Minister for Planning and Land Management

Minister for Police and Emergency Services

Minister assisting the Chief Minister on Advanced Technology and Space Industries

Manager of Government Business

t: 620 50218 | e: gentleman@act gov au

Please note that from 1 January 2018 ACT Government ministerial diaries are subject to publication on the ACT Government's open access website under section 23 of the Freedom of Information Act 2016.

This email, and any attachments, may be confidential and also privileged. If you are not the intended recipient, please notify the sender and delete all copies of this transmission along with any attachments immediately. You should not copy or use it for any purpose, nor disclose its contents to any other person.

<20181116085930142.pdf>



Our ref: CMTEDDFOI 2019-048

Ms		
via email:	l	
Dear		

FREEDOM OF INFORMATION REQUEST

I refer to your application under section 30 of the *Freedom of Information Act 2016* (the Act), received by the Chief Minister, Treasury and Economic Development Directorate (CMTEDD) on 1 March 2019.

Specifically, you are seeking:

"All information in relation to:

- Waterways and Creeks in Crace
- Fill type, soil testing and regrading in section 80 Crace
- All Civil / Engineers reports and plans of Crace and in particular section 80 Crace
- All drainage plans including any inspection reports that have been done to check pipework in section 80 Crace

All information in relation to the removal of the playing field/oval/open space, when and if the amendment went to public consultation & if not how was the change approved, and was legislation on public consultation and technical amendments followed?"

The scope was narrowed by a telephone conversation between yourself and Mr Simon McPhan of this office on 15 March 2019. You agreed to reduce the scope of your request to section 80 Crace.

Authority

I am an Information Officer appointed by the Director-General under section 18 of the Act to deal with access applications made under Part 5 of the Act.

Timeframes

In accordance with section 40 of the Act, CMTEDD is required to provide a decision on your access application by 1 April 2019.

Decision on access

Searches were completed for relevant documents and 11 documents were identified that fall within the scope of your request.

No information for the first two points of your request was found. I note that your request has also been transferred to the Environment, Planning and Sustainable

Development Directorate (EPSDD). EPSDD may be better suited to respond to these points of your request.

I have included as **Attachment A** to this decision the schedule of relevant documents. This provides a description of each document that falls within the scope of your request and the access decision for each of those documents.

I have decided to grant access in full to seven documents relevant to your request. I have decided to grant partial access to the remaining documents as I consider them to be information that would, on balance, be contrary to the public interest to disclose under the test set out in section 17 of the Act.

My access decisions are detailed further in the following statement of reasons and the documents released to you are provided as **Attachment B** to this letter.

Material considered

In reaching my access decision, I have taken the following into account:

- the Act:
- the content of the documents that fall within the scope of your request; and
- the Information Privacy Act 2014.

Exemption claimed

My reasons for deciding not to grant access to the identified documents and components of these documents are as follows:

Public Interest

The Act has a presumption in favour of disclosure. As a decision maker I am required to decide where, on balance, public interests lies. As part of this process I must consider factors favouring disclosure and factors favouring non-disclosure.

In Hogan v Hinch (2011) 243 CLR 506, [31] French CJ stated that when 'used in a statute, the term [public interest] derives its content from "the subject matter and the scope and purpose" of the enactment in which it appears'. Section 17(1) of the Act sets out the test, to be applied to determine whether disclosure of information would be contrary to the public interest. These factors are found in subsection 17(2) and Schedule 2 of the Act.

Taking into consideration the information contained in the documents found to be within the scope of your request, I have identified that the following public interest factors are relevant to determine if release of the information contained within these documents is within the 'public interest'.

Factors favouring disclosure in the public interest:

- (a) disclosure of the information could reasonably be expected to do any of the following:
 - (i) promote open discussion of public affairs and enhance the government's accountability.

Factors favouring nondisclosure in the public interest:

- (a) disclosure of the information could reasonably be expected to do any of the following:
 - (ii) prejudice the protection of an individual's right to privacy or any other right under the Human Rights Act 2014.

Having considered the factors identified as relevant in this matter, I consider that the release of the information contained in these documents may promote open discussion of public affairs and enhance the government's accountability by allowing you to have a copy of the documents CMTEDD holds relating to section 80 Crace and the playing field opposite section 80.

However, when considering this finding against the factor favouring non-disclosure, I am satisfied that the protection of an individual's right to privacy, especially the names of non-ACT Government employees and home owners, is a significant factor as the parties involved have provided their personal information for the purposes of meeting obligations under relevant legislation which, in my opinion, outweighs the benefit which may be derived from releasing the personal information of the individual's involved in this matter. These individuals are entitled to expect that the personal information they have supplied as part of this process will be dealt with in a manner that protects their privacy.

Charges

Pursuant to Freedom of Information (Fees) Determination 2017 (No 2) processing charges are applicable for this request because the total number of pages to be released to you exceeds the charging threshold of 50 pages. However, the charges have been waived in accordance with section 107(2)(b) of the Act.

Online publishing - Disclosure Log

Under section 28 of the Act, CMTEDD maintains an online record of access applications called a disclosure log. Your original access application, my decision and documents released to you in response to your access application will be published in the CMTEDD disclosure log three days after the date of my decision. Your personal contact details will not be published.

You may view the CMTEDD disclosure log at https://www.cmtedd.act.gov.au/functions/foi/disclosure-log.

Ombudsman Review

My decision on your access request is a reviewable decision as identified in Schedule 3 of the Act. You have the right to seek a review by the Ombudsman of this outcome under section 73 of the Act within 20 working days from the day that my decision is published in the CMTEDD disclosure log, or a longer period allowed by the Ombudsman.

If you wish to request a review of my decision you may write to the Ombudsman at:

The ACT Ombudsman GPO Box 442 CANBERRA ACT 2601

Via email: actfoi@ombudsman.gov.au

ACT Civil and Administrative Tribunal (ACAT) Review

Under section 84 of the Act, if a decision is made by the Ombudsman under section 82(1), you may apply to the ACAT for review of the Ombudsman decision. Further information may be obtained from the ACAT at:

ACT Civil and Administrative Tribunal Level 4, 1 Moore St GPO Box 370 Canberra City ACT 2601 Telephone: (02) 6207 1740

http://www.acat.act.gov.au/

Should you have any queries in relation to your request please contact me by telephone on 6207 7754 or email CMTEDDFOI@act.gov.au.

Yours sincerely,

Sarah McBurney Information Officer Information Access Team

Chief Minister, Treasury and Economic Development Directorate

21 March 2019



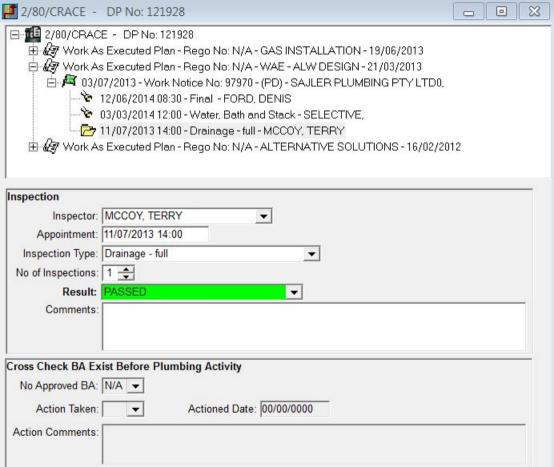
FREEDOM OF INFORMATION REQUEST SCHEDULE

NAME	WHAT ARE THE PARAMETERS OF THE REQUEST	Reference NO.
	All information in relation to:	CMTEDDFOI 2019-048
	Waterways and Creeks in Crace	
	Fill type, soil testing and regrading in section 80 Crace	
	All Civil / Engineers reports and plans of Crace and in particular section 80 Crace	
	All drainage plans including any inspection reports that have been done to check pipework in section 80 Crace	
	All information in relation to the removal of the playing field/oval/open space, when and if the amendment went to public consultation & if not how was the change approved, and	
<u>¢</u>	was legislation on public consultation and technical amendments followed?	

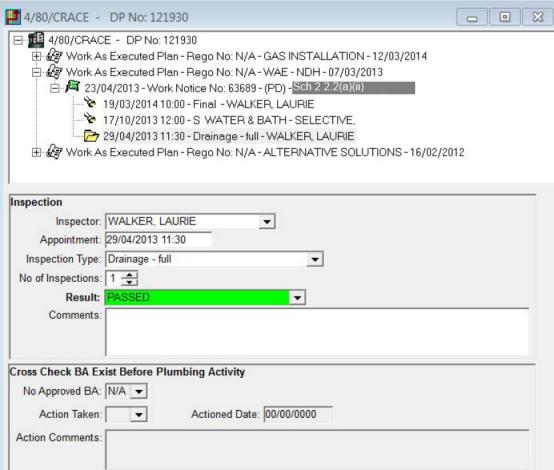
Ref No	Page number	Description	Date	Status	Reason for Exemption	Online Release Status
1	1-13	Drainage inspection records – Section 80 Crace	Nil	Partial release	Sch 2 s2.2 (a)(ii)	Yes
2	14-219	Plans - Section 80 Crace	Various	Partial release	Sch 2 s2.2 (a)(ii)	Yes
3	220-221	Email	23-Nov-09	Full release	N/A	Yes
4	222	Attachment to previous email	23-Nov-09	Full release	N/A	Yes
5	223	Attachment to previous email	23-Nov-09	Full release	N/A	Yes
6	224-225	Email chain	25-Nov-09	Partial release	Sch 2 s2.2 (a)(ii)	Yes
7	226-227	Email chain	26-Dec-09	Full release	N/A	Yes
8	228-229	Email chain	10-Mar-10	Full release	N/A	Yes
9	230-232	Email chain	16-Mar-10	Partial release	Sch 2 s2.2 (a)(ii)	Yes
10	233-234	Email chain	30-Apr-10	Full release	N/A	Yes

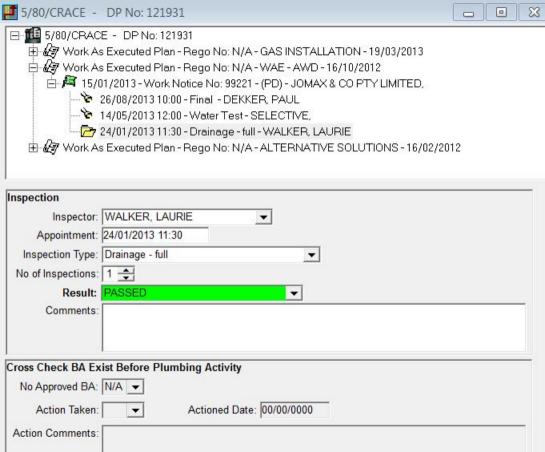
11	235-236	Email chain	6-May-10	Full release	N/A	Yes
Total No						
of Docs						
11						

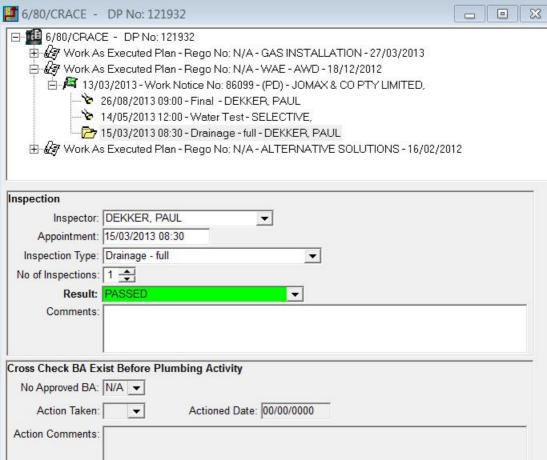
1/80/CRACE -	DP No: 121927	
田子 Work As 日子 Work As 日子 29/0	E - DP No: 121927 E Executed Plan - Rego No: N/A - GAS INSTALLATION - 29/08/2017 E Executed Plan - Rego No: N/A - WAE - AWD - 18/08/2017 18/2017 - Work Notice No: 8324692 - (PD) - Sch 2 2.2(a)(ii) 103/07/2018 08:30 - Final - HOWARD, STUART 1030/11/2017 12:00 - S WATER, BATH & STACK - SELECTIVE, 1031/08/2017 13:00 - Drainage - full - HOWARD, STUART 1031/08/2017 13:00 - Rego No: N/A - ALTERNATIVE SOLUTIONS - 16/02/201	12
Appointment: Inspection Type: No of Inspections:		
Cross Check BA Ex No Approved BA: Action Taken: Action Comments:		



3/80/CRACE -	DP No: 121929	
⊕ ⊌ Work A: □ ⊌ Work A: □ № 05/0	E - DP No: 121929 S Executed Plan - Rego No: N/A - GAS INSTALLATION - 11/11/2013 S Executed Plan - Rego No: N/A - WAE - PIROTTA - 05/07/2013 07/2013 - Work Notice No: 92722 - (PD) - Sch. 2 2.2(a)(ii) 25/11/2013 13:00 - Final - GIBBS, ALAN 11/09/2013 12:00 - S WATER & BATH - SELECTIVE, 09/07/2013 11:30 - Drainage - full - GIBBS, ALAN s Executed Plan - Rego No: N/A - ALTERNATIVE SOLUTIONS - 16/0	02/2012
Appointment: Inspection Type: No of Inspections:		
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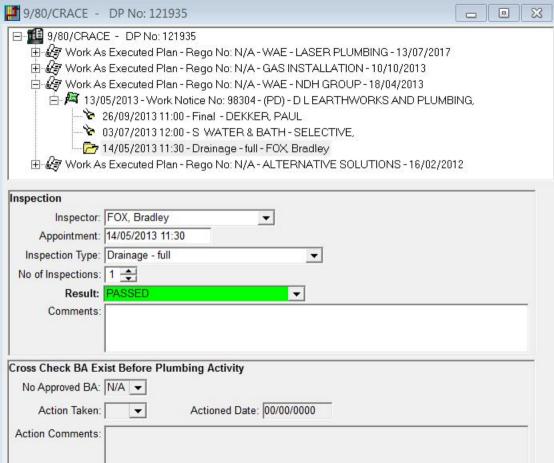


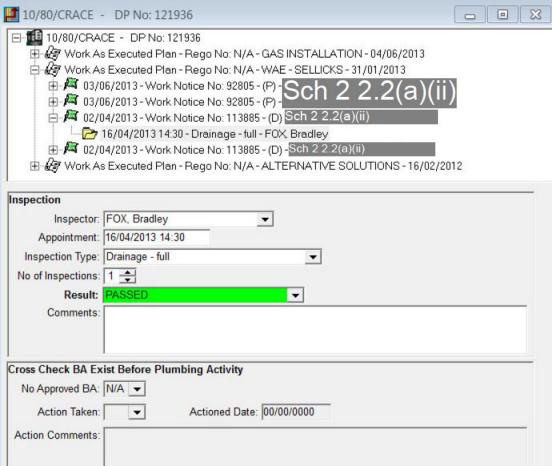


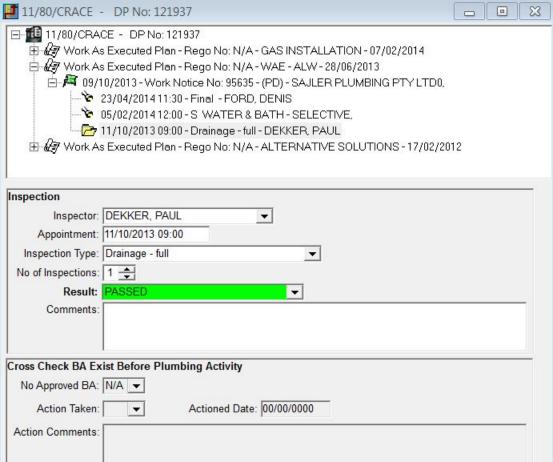


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Appointment: Inspection Type: No of Inspections:				
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8/80/CRACE -	DP No: 121934	0	0	2
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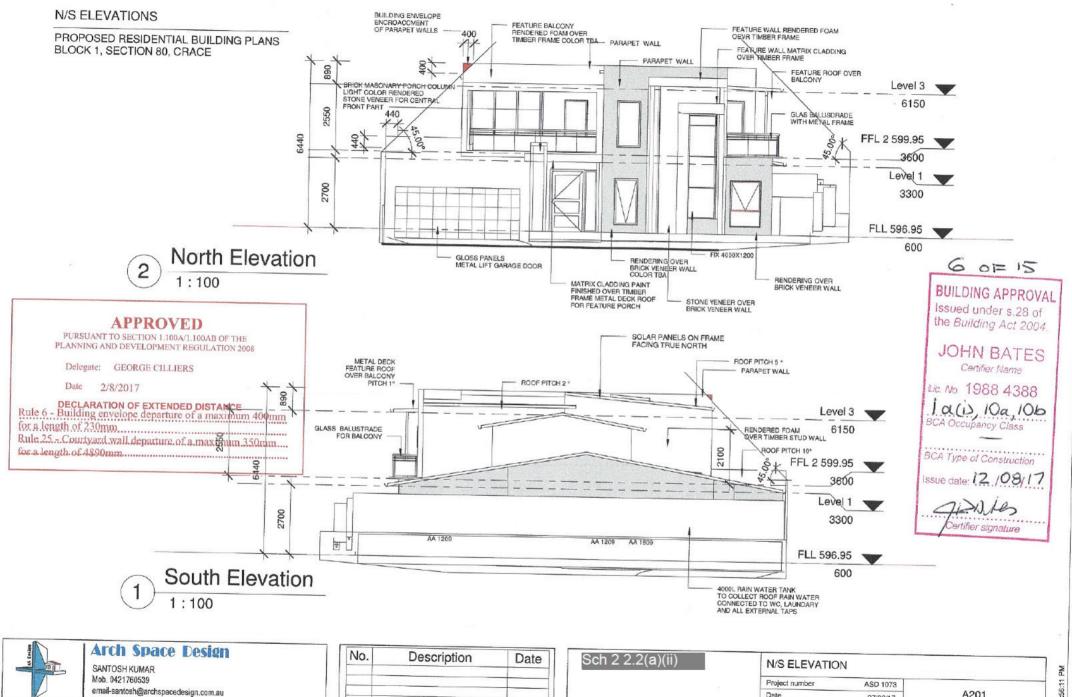






12/80/CRACE - DP No: 126713	0	X
□ 12/80/CRACE - DP No: 126713 □ 47 Work As Executed Plan - Rego No: N/A - GAS INSTALLATION - 01/10/2014 □ 47 Work As Executed Plan - Rego No: N/A - WAE - ALW - 23/07/2014 □ 47 24/09/2014 - Work Notice No: 107102 - (PD) - SAJLER PLUMBING PTY LTD0, □ 18/03/2015 10:00 - Final - MCCOY, TERRY □ 28/11/2014 12:00 - S WATER & BATH - SELECTIVE, □ 25/09/2014 09:00 - Drainage - full - ORD, GRAEME		
Inspection		_
Inspector: ORD, GRAEME		
Appointment: 25/09/2014 09:00		
Inspection Type: Drainage - full ▼		
No of Inspections: 1		
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Comments:		-
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No Approved BA: N/A ▼		
Action Taken: Actioned Date: 00/00/0000		
Action Comments:		_

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Inspection Inspector: DEKKE Appointment: 11/12/2 Inspection Type: Drainag No of Inspections: 1 \$\displayset{\displayset}\$ Result: PASSE Comments:	2012 09:00 ge - full	
Cross Check BA Exist Before No Approved BA: N/A Action Taken: Action Comments:		



novative residential designi & architectural drafting

www.archspacedesign.com.au

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A201

27/06/17

Author

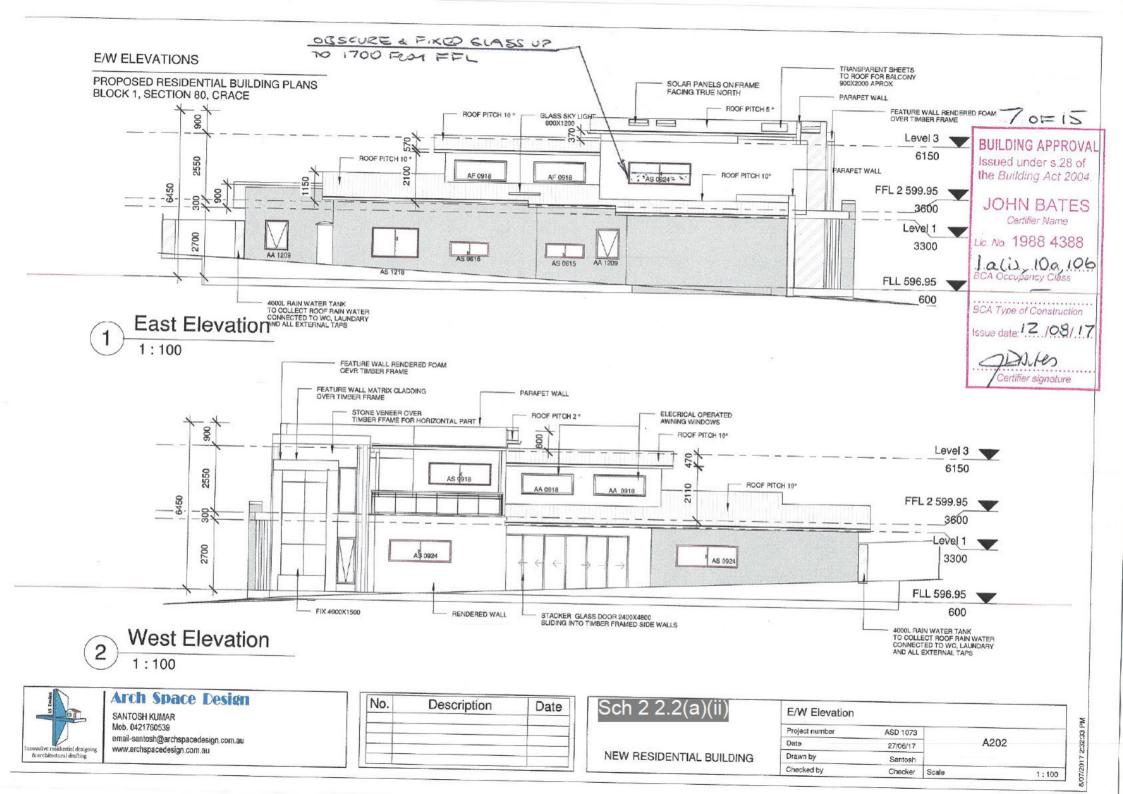
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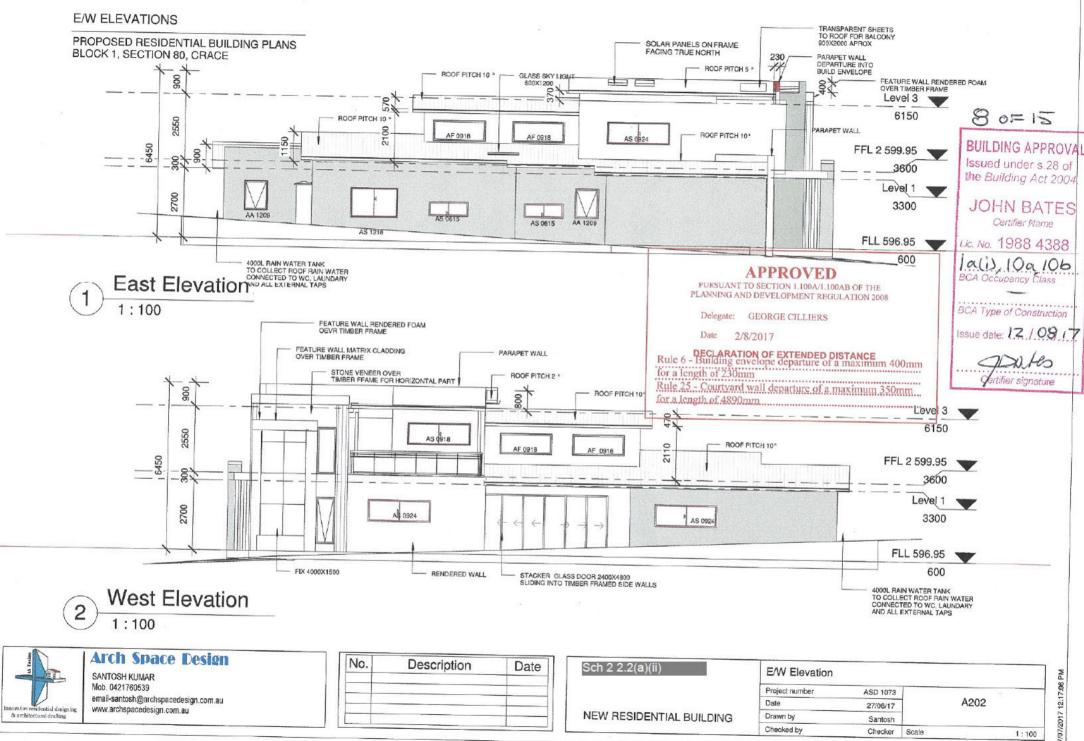
Date

Drawn by

Checked by

NEW RESIDENTIAL BUILDING





PROPOSED RESIDENTIAL BUILDING PLANS BLOCK 1, SECTION 80, CRACE

9 0 15

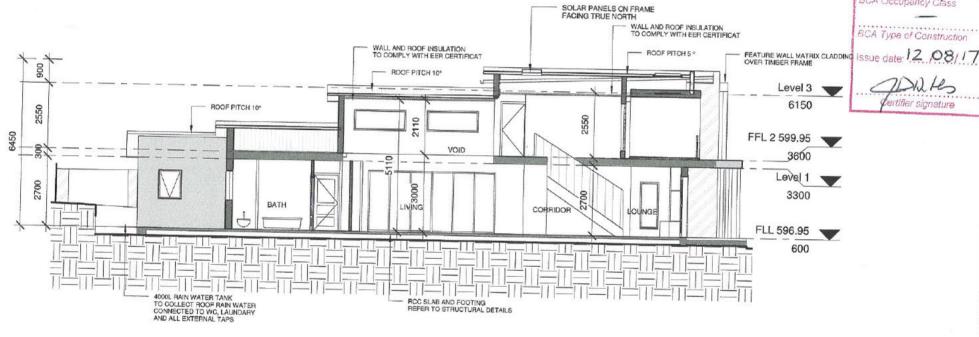
BUILDING APPROVAL

Issued under s.28 of the Building Act 2004.

JOHN BATES

Certifier Name. Lic. No. 1988 4388

BCA Type of Construction






Arch Space Design

SANTOSH KUMAR Mob. 0421760539 email-santosh@archspacedesign.com.au www.archspacedesign.com.au

No.	Description	Date

Sch 2 2.2(a)(ii)
NEW RESIDENTIAL BUILDING

SECTION	STATE OF THE PARTY		-
Project number	ASD 1073		
Date	27/06/17	A:	301
Drawn by	Author		
Checked by	Checker	Scale	1:100

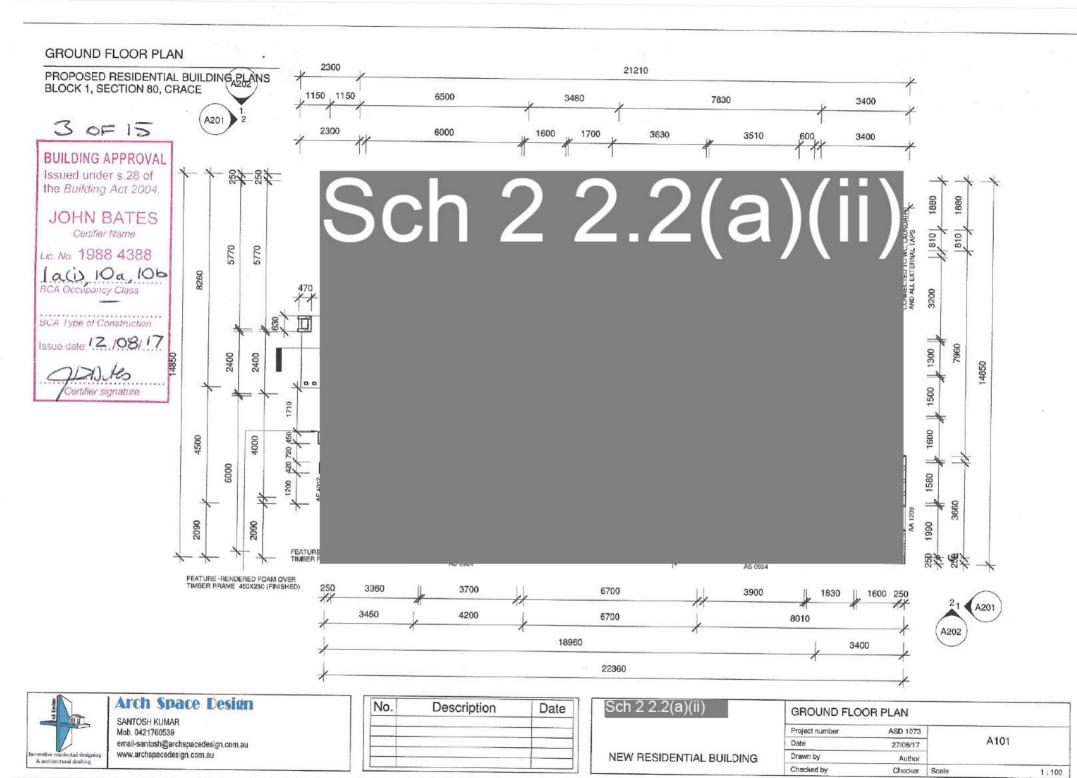

07/2017 2:28:50 PM

BLOCK 1, SECTION 80, CRACE

PROPOSED RESIDENTIAL BUILDING PLANS

4 OF 15

BUILDING APPROVAL

Issued under s.28 of the Building Act 2004.

JOHN BATES

Certifier Mame

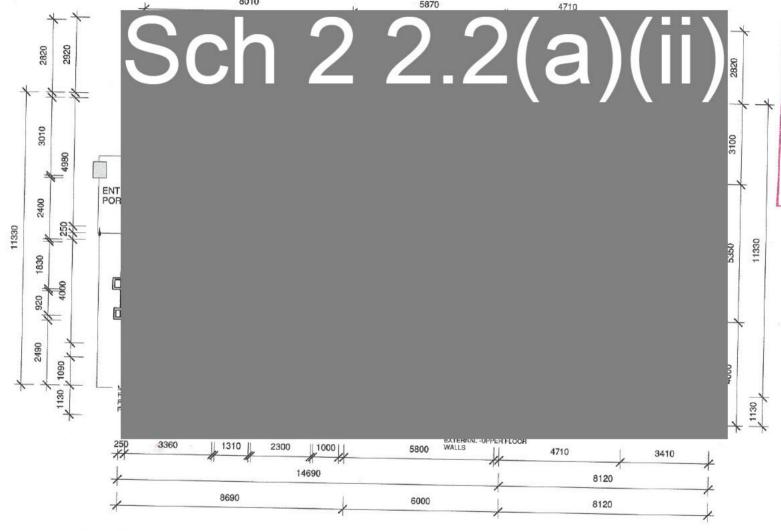
Lic. No. 1988 4388

BCA Occupancy Class

BCA Type of Construction

Issue date 12 08/17

Certifier signature





Arch Space Design

SANTOSH KUMAR Mob. 0421760539 email-santosh@archspacedesign.com.au www.archspacedesign.com.au

No.	Description	Date

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OUI			~\ `	

NEW RESIDENTIAL BUILDING

FIRST FLOOR	PLAN		
Project number	ASD 1073	T	
Date	27/06/17	A	102
Drawn by	Author		
Checked by	Checker	Scale	1:100

PIERRE DRAGH CONSULTING ENGINEERS

OFFICE

ADDRESS: 16 VICTORIA STREET, HALL, ACT, 2618

TEL: 0438 625 440 FAX: (02) 6230 9695

EMAIL: PDRAGH@BIGPOND.COM

10 0F 15

BUILDING APPROVAL

Issued under s.28 of the Building Act 2004.

JOHN BATES
Cestifier Name

Lic. No. 1988 4388

lacis 10a 10t

BCA Type of Construction

Issue date 12 /08/17

JON HS

Jertifier signature

SITE ADDRESS

BLOCK O1 SECTION BO CRACE

JOB DESCRIPTION

PROPOSED NEW DWELLING

CLIENT:

Sch 2 2.2(a)(ii)

DRAWING LIST

S1 - GENERAL NOTES

S2 - FOOTING & SLAB LAYOUT

S3 - FOOTING DETAILS

S4 - JOIST & BEAM LAYOUT

S5 - ROOF BEAM LAYOUT

NOTE

IT IS THE RESPONSIBILITY OF THE CLIENT IN CONSULTATION WITH THEIR BUILDER TO CHECK AND VERIFY THE BUILDABILITY OF THE DESIGN AS PRESENTED AND REFER ANY CONCERNS BACK TO THE ENGINEER PRIOR TO CONSTRUCTION. THESE DRAWINGS ARE TO BE READ IN CONJUNCTION WITH THE PROJECT ARCHITECTURAL AND OTHER CONSULTANTS DRAWINGS AND SPECIFICATIONS.

APPROVED BY:

Dwg No.

GENERAL NOTES:

- THESE DRAWINGS SHALL BE READ IN CONJUNCTION WITH ALL ARCHITECTURAL AND OTHER CONSULTANTS DRAWINGS AND SPECIFICATIONS AND WITH SUCH OTHER WRITTEN INSTRUCTIONS AS MAY BE ISSUED DURING THE COURSE OF THE CONTRACT, ALL DISCREPANCIES SHALL BE REFERRED TO THE ARCHITECT/ENGINEER FOR DECISION BEFORE PROCEEDING WITH THE WORK,
- DIMENSIONS SHALL NOT BE OBTAINED BY SCALING THE
- STRUCTURAL DRAWINGS. SETTING OUT DIMENSIONS SHOWN ON THE DRAWINGS SHALL BE VERIFIED BY THE BUILDER.
- DURING CONSTRUCTION THE STRUCTURE SHALL BE MAINTAINED A STABLE CONDITION AND NO PART SHALL BE OVERSTRESSED.
- ALL WORKMANSHIP AND MATERIAL SHALL BE IN ACCORDANCE WITH THE REQUIREMENTS OF THE CURRENT EDITIONS OF THE A.S. CODES AND THE BY-LAWS AND ORDINANCES OF THE RELEVANT BUILDING AUTHORITY.
- THE STRUCTURAL ELEMENTS SHOWN ON THE DRAWINGS HAVE BEEN DESIGNED IN ACCORDANCE WITH THE FOLLOWING CODES:

CONCRETE - A.S 3600 FOOTING . A.S 2870

STEEL A.S 4100 & A.S. 4600

FOUNDATIONS AND FOOTINGS:

- F.1 FOOTINGS HAVE BEEN DESIGNED FOR A UNIFORM BEARING PRESSURE (refer to sheet 2), FOUNDATION MATERIAL SHALL BE APPROVED FOR THIS PRESSURE BEFORE PLACING CONCRETE FOOTING
- THE SITE IS CLASSIFIED IN ACCORDANCE WITH GEOTECHNICAL REPORT (refer to sheet 2). WE DISCLOSE THAT WE HAVE NOT VERIFIED THIS REPORT AND THAT WE RELY ON ITS FINDINGS.
- FOOTING SHALL BE PLACED CENTRALLY UNDER WALLS AND COLUMNS UNLESS OTHERWISE NOTED.
- ALL WORKMANSHIP & MATERIALS SHALL BE IN ACCORDANCE WITH
- THE FOOTING DETAILS SHOWN ARE FOR THE SITE CLASSIFICATION STIPULATED, PDCE CONSULTING ENGINEERS TAKES NO. RESPONSIBILITY FOR VARIATIONS WHICH MAY OCCUR DUE TO VARIATIONS IN SITE CONDITIONS
- FILL USED IN THE CONSTRUCTION OF A SLAB EXCEPT WHERE THE SLAB IS SUSPENDED SHALL CONSIST OF A CONTROLLED FILL OR ROLLED FILL IN ACCORDANCE WITH A.S. 2870
 - A) ROLLED FILL CONSISTS OF MATERIAL COMPACTED IN LAYERS BY REPEATED ROLLING WITH AN EXCAVATOR, ROLLED FILL SHALL NOT EXCEED 600mm COMPACTED IN LAYERS NOT MORE THAN 300mm, FOR SAND MATERIEL OR 400mm COMPACTED IN LAVERS NOT MORE THAN 150mm FOR OTHERS MATERIAL. B) CONTROLLED FILL SHALL CONSIST OF WELL GRADED SAND FILL
 - UP TO SOOMM DEEP, WELL COMPACTED IN NOT MORE THAN 300mm LAYERS BY VIBRATING PLATE OR VIBRATING ROLLER NON SAND FILL UP TO 400mm DEEP, WELL COMPACTED IN NOT MORE THAN 150 LAYERS BY A MECHANICAL ROLLER, CLAY FILL SHOULD BE MOIST DURING COMPACTION. THE DEPTHS OF FILL GIVEN ABOVE ARE DEPTHS MEASURED AFTER COMPACTION. FOR DEPTHS GREATER THAN THAT GIVEN ABOVE THE FILL SHALL BE SUBJECT TO CONTROL AND TESTING. IF TEST FAILS THEN PIERS ARE REQUIRED. CONTACT THIS OFFICE PRIOR TO FURTHER
 - CONSTRUCTION. EDGE BEAMS MAY BE FOUNDED ON CONTROLLED FILL EDGE BEAMS SHALL NOT BE FOUNDED ON ROLLED FILL
- TOP SOIL CONTAINING GRASS ROOTS OR OTHER ORGANIC MATERIAL SHALL BE REMOVED FROM THE AREA ON WHICH THE SLAB IS TO
- IF ANY FOOTING IS LOCATED SUCH THAT A LINE DRAWN AT 45 DEGREES FOR CLAY AND 30 DEGREES FOR SAND FROM ITS BASE INTERSECTS A SERVICE TRENCH THEN PIERS ARE REQUIRED AS PER DETAIL BELOW.

BUILDING APPROVAL

the Building Act 2004.

ISSUED UNDER S. 28 OC. 17 ALL REINFORCEMENT SHALL BE FIRMLY SUPPORTED ON INSULATED STEEL, PLASTIC OR CONCRETE CHAIRS GENERALLY AT NOT GREATER THAN 800 CENTERS BOTH WAYS, RODS SHALL BE TIED AT ALTERNATE INTERSECTIONS. C.18 ALL TENSILE REINFORCEMENT TO BE LAPPED AS SHOWN (U.R.O.):-

> REINE, BAD N12 N16 N20 N24 LAP LENGTH mm 500 600 700 800

DRAINAGE NOTES:

TURIS GROUND 1988 438 (D.1) ALL WORKMANSHIP & MATERIALS SHALL BE IN ACCORDANCE WITH A.S. 2870

Lic. No. 1988 438 (D.2) GRAINAGE SHALL BE CONSTRUCTED TO AVOID WATER PONDING AGAINST OR NEAR THE FOOTING. THE GROUND IN THE IMMEDIATE VICINITY OF THE PERIMETER FOOTING, INCLUDING THE GROUND UPHILL FROM THE SLAB ON CUT-AND-FILL SITES, SHALL BE GRADED TO FALL 50mm MINIMUM AWAY FROM THE FOOTING OVER A DISTANCE OF m. SURFACE OR SUBSURFACE DRAINS SHALL BE USED TO CHANNEL WATER AWAY AND CONNECTED TO STORM WATER SYSTEM. ANY PAVING SHALL ALSO BE SUITABLY SLOPED

FLUMBING TRENCHES SHALL BE SLOPED AWAY FROM THE HOUSE AND SHALL BE BACKFILLED WITH CLAY IN THE TOP 300mm WITHIN 1.5m OF THE HOUSE. THE CLAY USED FOR BACKFILLING SHALL BE COMPACTED. WHERE PIPES PASS UNDER THE FOOTING, SYSTEM, THE TRENCH SHALL BE BACKFILLED WITH CLAY OR CONCRETE TO BESTRICT THE INGRESS OF WATER BENEATH THE FOOTING SYSTEM. EXCAVATIONS NEAR THE EDGE OF THE FOOTING SYSTEM SHALL BE BACKFILLED IN SUCH A WAY AS TO PREVENT ACCESS OF WATER TO THE FOUNDATION. FOR EXAMPLE, EXCAVATIONS SHOULD BE BACKFILLED ABOVE OR ADJACENT TO THE COTING. WITH MOIST CLAY COMPACTED BY HAND-RODDING OR -TAMPING, POROUS MATERIAL SUCH AS SAND, CRAVEL OR BUILDING RUBBLE SHOULD NOT BE USED. WATER RUN-OFF SHALL BE COLLECTED AND CHANNELLED AWAY FROM THE HOUSE DURING CONSTRUCTION.

- PENETRATIONS OF THE EDGE BEAMS AND FOOTING BEAMS ARE TO BE AVOIDED, BUT
- WHERE NECESSARY SHALL BE SLEEVED TO ALLOW FOR MOVEMENT. CONNECTION OF STORMWATER DRAINS AND WASTE DRAINS SHALL INCLUDE FLEXIBLE

STRUCTURAL STEEL:

- ALL WORKMANSHIP & MATERIALS SHALL BE IN ACCORDANCE WITH A.S. 4100 EXCEPT WHERE VARIED BY THE CONTRACT DOCUMENTS.
- S.2 UNLESS OTHERWISE NOTED, ALL STEEL SHALL BE IN ACCORDANCE WITH:
 - A.S. 3679.1 GRADE 300 FOR ROLLED SECTIONS. A.S. 1163 GRADE 350 FOR RHS SECTIONS.
 - A.S. 1163 GRADE 350 FOR CHS SECTIONS
 - A.S. 3378 GRADE 350 FOR ALL PLATE.
- A.S. 3679.1 GRADE 350 FOR ALL FLAT A.S. 1397 GRADE 450 FOR 1.5, 1.9, 2.4 AND 3.0 BMT OF COLD FORMED STEEL SECTIONS.
- S.3 UNLESS NOTED OTHERWISE ALL WELDS SHALL BE 6mm CONTINUOUS FILLET WELDS AND ALL GUSSET PLATES SHALL BE 10mm THICK.
- 5.4 BUTT WELDS WHERE INDICATED IN THE DRAWINGS ARE TO BE COMPLETE PENETRATION BUTT WELDS AS DEFINED IN A.S. 1554.
- S.5 UNLESS OTHERWISE SHOWN ALL BOLTS SHALL BE 16mm DIA HIGH STRENGTH (H.S.) BOLTS SHALL CONFORM TO A.S. 1252 AND SHALL BE INSTALLED IN ACCORDANGE. WITH A.S. 4100 AS DIRECTED BY THE ENGINEER.
- S.6 UNLESS NOTED OTHERWISE ALL BEAMS TO BE SUPPORTED ON BRICKWORK/ENGAGED BRICK PIERS (110mm BRICK BEARING REQUIRED) PLACE INCOMPRESSIBLE PACKING AS
- BROOK PIERS (110mm BHICK BEARING REQUIRE) PAGE EVEN BEARINGN ON BRIDKWORK.

 REQUIRED UNDER THE ENDS OF THE BEAM TO ENSURE EVEN BEARINGN ON BRIDKWORK.

 UNLESS NOTED OTHERWISE PROTECTIVE COATINGS FOR STEELWORK SHALL BE AS TABULATED BELOW AND IN ACCORDANCE WITH THE CURRENT EDITION OF THE BSA.

ENVIRONMENT (EXPOSURE CLASSIFICATION AS PER BCA)	(NOT BUILT INTO	UCTURAL MEMBERS MASONRY OR CONCRETE) EXTERNAL	(BUILT INTO MASONRY OR CONCRETE)
VERY LOW	RO	- ALTERIAGE	
LOW	RO	R1	R2
MEDIUM	RO	R2	R3
HIGH	RI	R3	84
VERY HIGH	RI	R4	R5

ON BATES LINE OF ZONE OF CERtifier Name INFLUENCE INTO HATURAL GROUND SERVICE. 1 a(i) 10 a 10b BCA Occupancy Class SERVICE TRENCH DETAIL CONCRETE WORK: D.3 BCA Type of Construction ALL WORKMANSHIP AND MATERIAL SHALL BE IN ACCORDANCE WITH A.S. 3600.17/08/17 CONCRETE QUALITY SHALL BE AS TABULATED BELOW U.N.O. AND SHALL BE VERIFIED BY TESTS. SLUMP MAX. SIZE CEMENT EXPOSURE CONCRETE COVER mm 100 20 TOP 30 ETM/IET S 40 EXTERNAL D.5 41 20N mature

ELEMENT SLARS ON GROUND FOOTINGS 100 20 A A1 PON 40 SUSPENDED 80 20 A A1 RSE SLAR

- ALL CONGRETE SHALL BE PLACED AND CURED IN ACCORDANCE WITH A.S. 3600. WHERE CURING COMPOUNDS ARE USED IT MUST BE APPLIED AS FOLLOWS A) ONTO SLAB WITHIN 2HRS OF FINISHING OPERATION
- B) ONTO WALLS AND COLUMNS IMMEDIATELY AFTER REMOVAL OF FORMWORK. SIZES OF CONCRETE ELEMENTS DO NOT INCLUDE THICKNESS OF APPLIED FINISHES. CONSTRUCTION JOINTS WHERE NOT SHOWN SHALL BE TO THE APPROVAL OF THE ENGINEER.
- BEAM DEPTHS ARE WRITTEN FIRST AND INCLUDE SLAB THICKNESS, IF ANY. HORIZONTAL FORMWORK SHALL BE STRIPPED WHEN APPROVED BY THE ENGINEER. UNLESS NOTED OTHERWISE NO ALLOWANCE HAS BEEN MADE FOR STACKED MATERIALS C.B
- OR MACHINERY ON THE CONCRETE STRUCTURE. 0.9 NO HOLES OR CHASES OTHER THAN THOSE SHOWN ON THE STRUCTURAL DRAWINGS
- SHALL BE MADE IN CONCRETE ELEMENTS WITHOUT THE PRIOR APPROVAL OF THE
- 0.10 REINFORCEMENT IS REPRESENTED DIAGRAMMATICALLY, IT IS NOT NECESSARILY SHOWN IN TRUE PROJECTION.
- C.11 SPLICES IN REINFORCEMENT MADE IN POSITIONS OTHER THAN SHOWN SHALL BE TO THE APPROVAL OF THE ENGINEER. WHERE THE LAP LENGTH IS NOT SHOWN IT SHALL BE SUFFICIENT TO DEVELOP THE FULL STRENGTH OF THE REINFORCEMENT.
- C.12 WELDING OF REINFORCEMENT SHALL NOT BE PERMITTED UNLESS SHOWN ON THE STRUCTURAL DRAWINGS.

 C.13 PIPES OR CONDUITS SHALL NOT BE PLACED WITHIN THE CONCRETE COVER TO REINFORCEMENT WITHOUT THE APPROVAL OF THE ENGINEER.
- C.14 ALL REINFORCING BARS SHALL COMPLY WITH A.S. 4671. ALL FABRIC SHALL COMPLY
- WITH A.S. 4671 AND SHALL BE SUPPLIED IN FLAT SHEETS. C.15 REINFORCING SYMBOLS: N - DENOTES GRADE 0500 HIGH STRENGTH DEFORMED BARS TO A.S. 4671.
 - DENOTES GRADE R250 HOT ROLLED PLAIN BARS TO A.S. 4671. - DENOTES HARD-DRAWN WIRE SQUARE REINFORCING FABRIC TO A.S. 4671. DENOTES HARD-DRAWN WIRE RECTANGULAR REINFORCING FABRIC TO A.S. 4671. THE NUMBER IMMEDIATELY FOLLOWING THESE SYMBOLS IS THE BAR DIAMETER IN MILLIMETRES.
- FABRIC REINFORCEMENT TO BE LAPPED ONE MESH PLUS 30mm, LAPS IN POSITIONS MAXIMUM MOMENT ARE NOT PERMITTED.

Contract of the	REVISION DETAILS					
NO.	DESCRIPTION	DATE	NAM			
			_			
-						

PIERRE DRAGH CONSULTING ENGINEERS

16 VICTORIA STREET.HALL ACT.2618 PH: 0436 625 440 Web: www.pdeengineers.com FAX: (02) 6230 8695 cmall: pdragh@bigpond.com


PROJECT BLOCK O1 SECTION RO CRACE

Sch 2 2.2(a)(ii)

GENERAL NOTES

SCALE: DATE: 1:100 | 11/07/17 Dwg No. DESIGNED: KZ S1 DRAWN: AFZAL CHECKED: PD
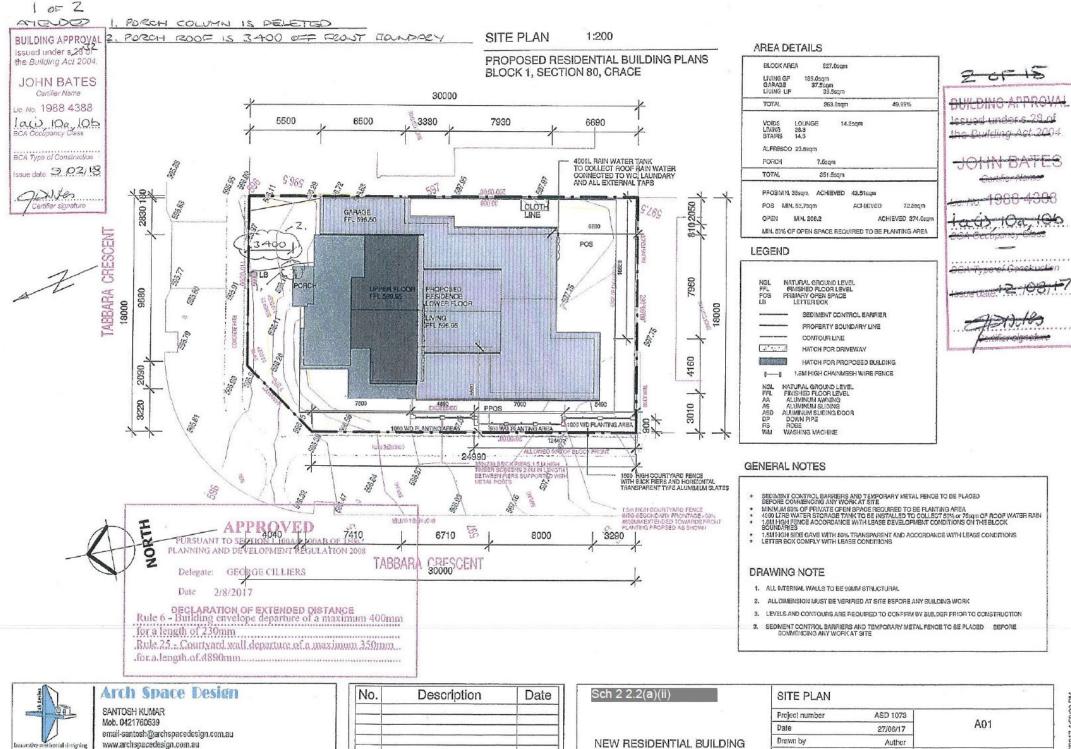
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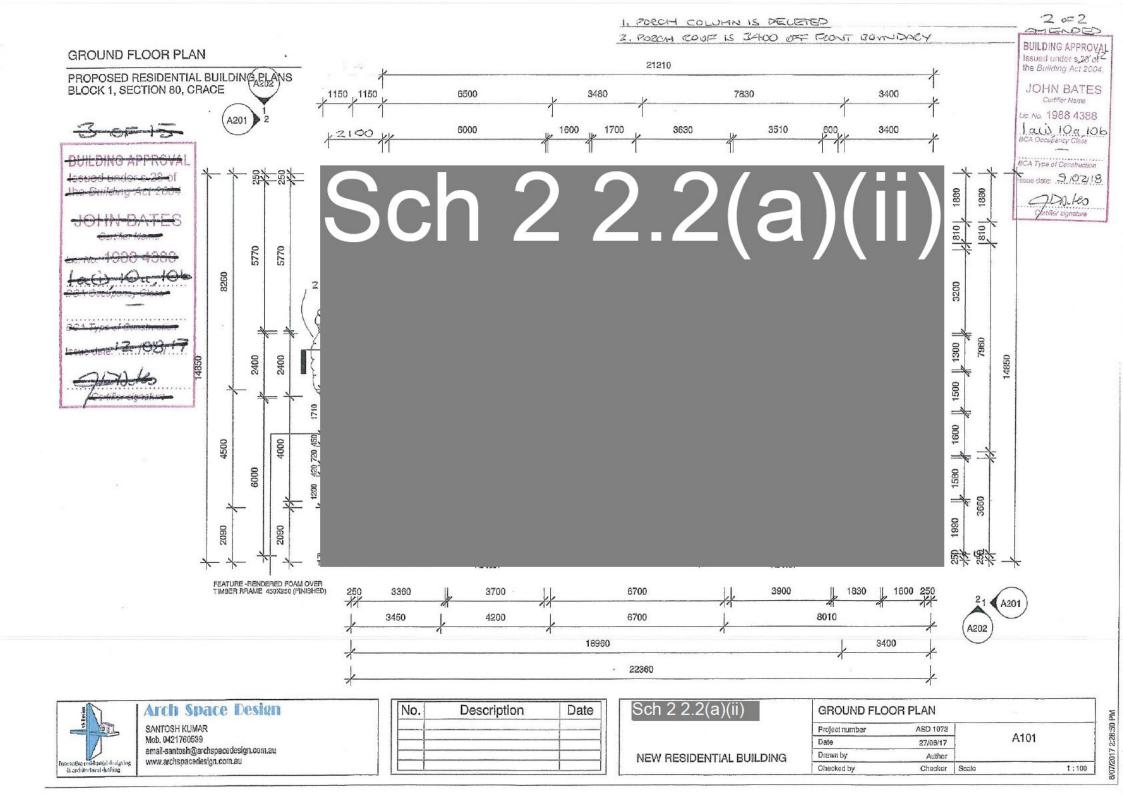



& architectural drafting

1:200

Checked by

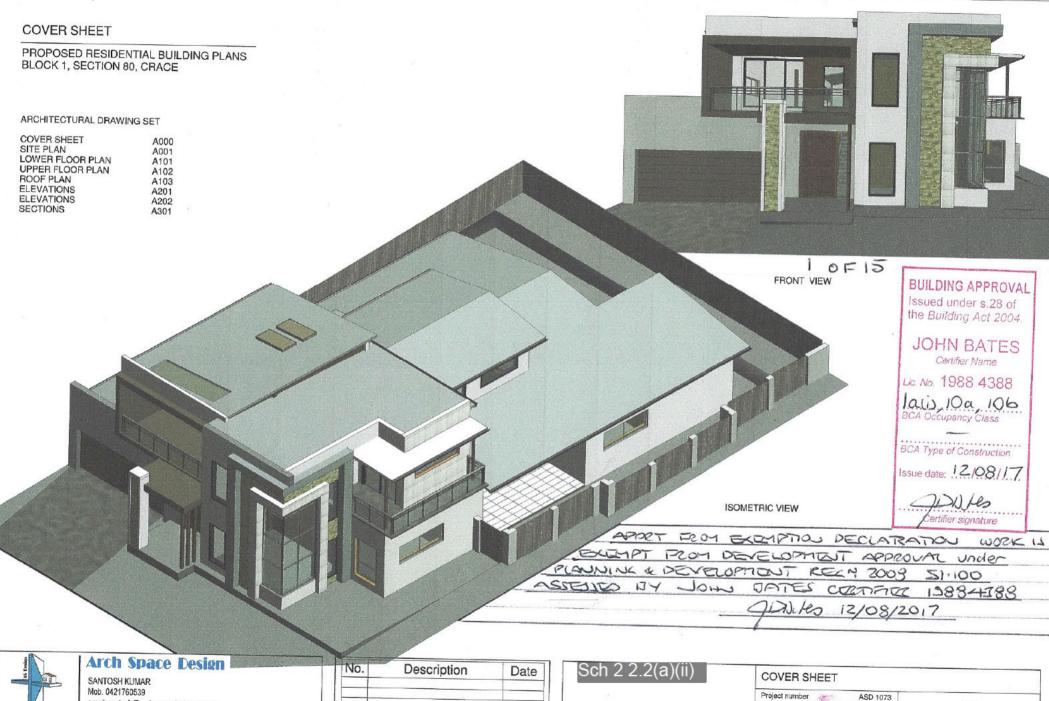Checker





email-santosh@archspacedesign.com.au

www.archspacedesign.com.au

Innovative residential designing 8. architectural drafting 20/07/2017 5:03:07

A00

27/06/17

Author

Checker Scale

Date

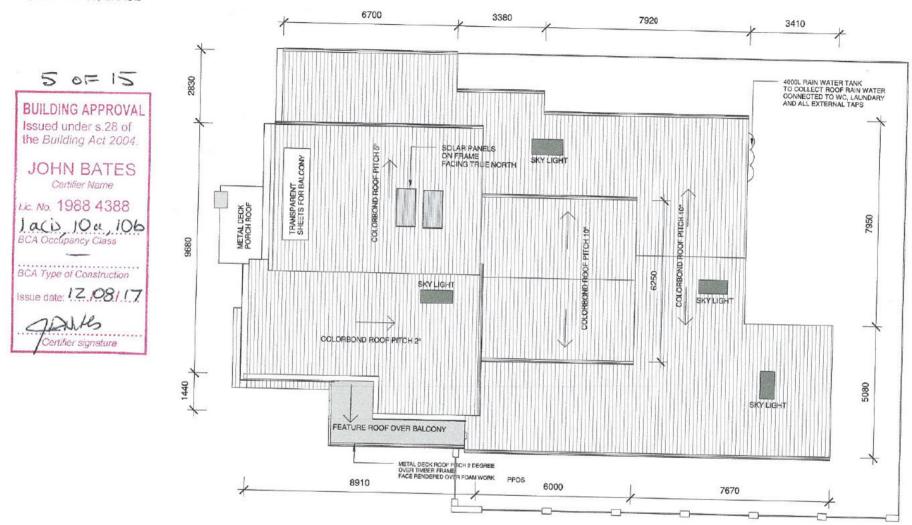
Drawn by

Checked by

NEW RESIDENTIAL BUILDING

ROOF PLAN

PROPOSED RESIDENTIAL BUILDING PLANS BLOCK 1, SECTION 80, CRACE





Arch Space Design


SANTOSH KUMAR Mob. 0421760539 email-santosh@archspacedesign.com.au www.archspacedesign.com.au

No.	Description	Date

Sch 2 2.2(a)(ii)	ROOF PLAN			
	Project number	ASD 1073		
	Date	27/06/17		A103
NEW RESIDENTIAL BUILDING	Drawn by	Author		
	Checked by	Checker	Scale	1:100

1:200

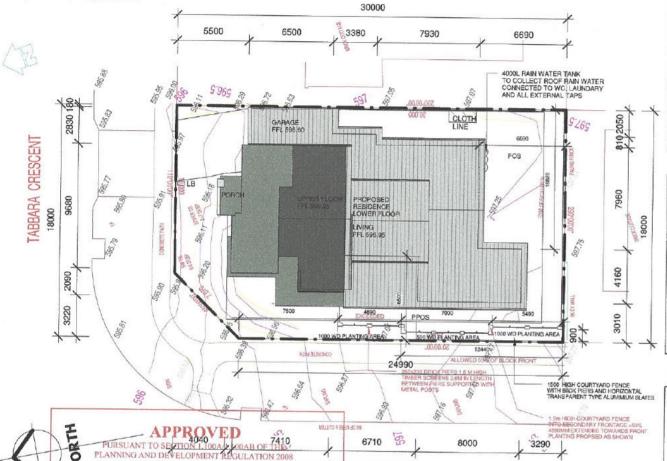PROPOSED RESIDENTIAL BUILDING PLANS BLOCK 1, SECTION 80, CRACE



TABBARA

AREA DETAILS

LEGEND

BLOCK AR	EA 527.	.0sqm	
LIVING GF GARAGE LIVING UF	37.5sqm	ōsqm	
TOTAL	263	.0sqm	49.99%
VOIDS LIVING STAIRS	LOUNGE 28.8 14.5	14.2sqm	
ALFRESCO	23.5sqm		
PORCH	7.5eqn	n	
TOTAL	351.5	sqm	
PPOS MIN.	36sqm ACHIE	VED 43.51sqm	
POS MIN	, 52.7sqm	ACHIEVED	72.3sgm
OPEN	MN. 266.2	AC	HIEVED 274.050
MIN. 50% O	OPEN SPACE	REQUIRED TO BE F	ANTING AREA

NATURAL GROUND LEVEL

FINISHED FLOOR LEVEL PRIMARY OPEN SPACE

NATURAL GROUND LEVEL FINISHED FLOOR LEVEL ALUMINUM AWNING

ALUMNUM SLIDING ALUMINUM SLIDING DOOR DOWN PIPE

ROBE WASHING MACHINE

SEDIMENT CONTROL BARRIER

PROPERTY BOUNDARY LINE CONTOUR LINE HATCH FOR DRIVEWAY

HATCH FOR PROPOSED BUILDING 1.8M HIGH CHAINMESH WIRE FENCE

BUILDING APPROVAL

Issued under s.28 of the Building Act 2004.

2 OF 15

JOHN BATES

Certifier Name

Lic. No. 1988 4388

Iaa) 10a, 10b BCA Occupancy Class

BCA Type of Construction

Issue date: 12, /08/17

GENERAL NOTES

FFL AA AS

- SEDIMENT CONTROL BARRIERS AND TEMPORARY METAL FENCE TO BE PLACED BEFORE COMMENCING ANY WORK AT SITE
- MINIMIN 69% OF PRIVATE O'PEN GRACE REQUIRED TO BE PLANTING AREA 4000 LTSE WATER STORAGE TAIN TO BE INSTALLED TO COLLECT 69% OF 7500TH OF ROOF WATER RAIN 1.9M HIGH FERICE ACCORDANCE WITH LEASE DEVELOPMENT CONDITIONS ON THE BLOCK BOUNDARIES
- 1.5M HIGH SIDE GAVE WITH 50% TRANSPARENT AND ACCORDANCE WITH LEASE CONDITIONS
 LETTER BOX COMPLY WITH LEASE CONDITIONS

DRAWING NOTE

- 1. ALL INTERNAL WALLS TO BE 90MM STRUCTURAL
- 2. ALL DIMENSION MUST BE VERIFIED AT SITE BEFORE ANY BUILDING WORK
- 3. LEVELS AND CONTOURS ARE REQUIRED TO CONFIRM BY BUILDER PRIOR TO CONSTRUCTION
- 3. SEDIMENT CONTROL BARRIERS AND TEMPORARY METAL FENCE TO BE PLACED. BEFORE COMMENCING ANY WORK AT SITE

SANTOSH KUMAR Mob. 0421760539

anovative recidential design: & erchitectural drefting

Arch Space Design

Delegate:

Date

for a length of 230mm

GEORGE CILLIERS

Rule 6 - Building envelope departure of a maximum 400mm

Rule 25 - Courtyard wall departure of a maximum 350mm .for.a.length.of.4890mm

2/8/2017

email-santosh@archspacedesign.com.au www.archspacedesign.com.au

No.	Description	Date
		_

Sch 2 2.2(a)(ii

NEW RESIDENTIAL BUILDING

SITE PLAN			
Project number	ASD 1073		100-2000
Date	27/06/17	1	A01
Drawn by	Author		
Checked by	Checker	Scale	1:200

SLAB DESIGN SUMMARY

225 & 150
100
325 / 250
1090 X 1090
SL82
1N12 BTM OR EQUIVALENT
3N12 BTM OR EQUIVALENT
1N12 BTM & 1N12 TOP OR EQUIVALENT
3N12 BTM OR EQUIVALENT

REINFORCEME EXCEEDS 301	NT FOR BEAMS WHI	ERE WIDTH
WIDTH (mm)	TOP	воттом
301-370	1N12 OR EQUIV	3N12 OR EQUIV
371-480	2N12 OR EQUIV	4N12 OR EQUIV
481-600	SN12 OH EQUIV	5N12 OR EQUIV

PIER DESIGN SUMMARY (U.n.o)

MEMBER EDGE BEAMS INTERNAL & STEP BEAMS INTERNAL RIB		PIER SPACING (mm)				
		2400 2400x2400 GRID 2400x2400 GRID				
				FOUNDATIONS	PIER Ø (mm)	SOCKET LENGTH (mm)
				STIFF CLAY	450	500
SHALE	400	200				
ROCK	300	100				

FOOTING DESIGN SUMMARY

(mm)	REINFORCEMENT
800	3-1 1TM TOP & BTM WITH R6 TIES @ 900 CTS
500	4-1 1TM TOP & BTM WITH
600	NONE (MASS CONCRETE)
	(mm) 800

EQUADATION DECION CURRENTS

SITE CLASSIFICATION	M		
SAFE BEARING CAPACITIES (SWL)	SLAB & FOOTINGS	100 kPa	
	PIERS	4500 with a 500 socket into natural material (stiff clay) & with a min capacity of 250 kPa	
GEOTECHNICAL REFI			

WAFFLE SLAB PLAN "M" CLASS

LEGEND

1 STANDARD 1090X1090 POD

3N12 OR 3L11TM, 2000mm LONG. TIED TO UNDERSIDE OF SLAB MESH

450mm DIA CONCRETE PIERS TO MIN 500mm INTO NATURAL GROUND

DENOTES STARTING POINT FOR POD LAYOUT.

P1: 600X600 CUT - OFF IN PODS

NO.	DESCRIPTION	DATE	NAME
-			
-			

PIERRE DRAGH

100mm SLAB

SL82 (TOP)

150mm POD

USE 65mm

MESH CHAIRS

EB2

CONSULTING ENGINEERS

16 VICTORIA STREET, HALL, ACT,2618 PH: 0436 625 440 Web: www.pdcengineers.com.s FAX: (02) 6230 9695 cmall: pdragh@blgpond.com

SF1 SF1

MR VENKATA DIVVELA

FOOTING & SLAB LAYOUT

EB1

Issued under s.28 of the Building Act 2004.

12 OF 15

BUILDING APPROVAL

JOHN BATES Cestifier Name

Lic. No. 1988 4388

Jaw 105 BCA Occupancy Class

BCA Type of Construction

Issue date: 12 /08/17

EB1

EB1

SITE CLASSIFICATION	M	
Safe Bearing Capacities (SWL)	SLAB & FOOTINGS	100 kPa
	PIERS	4500 with a 500 socket into natural material (stiff clay) & with a min capacity of 250 kPa

FOOTING & SLAB LAYOUT SCALE = 1:100

100mm SLAB SL82 (TOP)

225mm POD USE 65mm MESH CHAIRS

SOT

100mm SLAB SLB2 (TOP) 150mm POD

USE 65mm MESH CHAIRS

BLOCK O1 SECTION 80 CRACE

EB1

100mm SLAB

SLB2 (TOP)

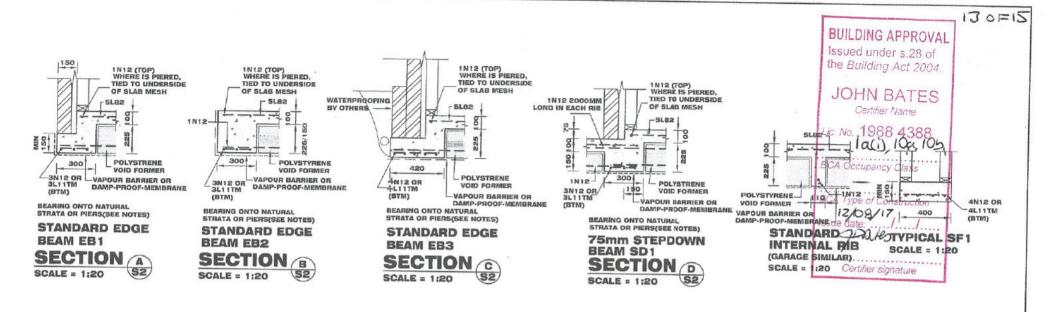
225mm POD

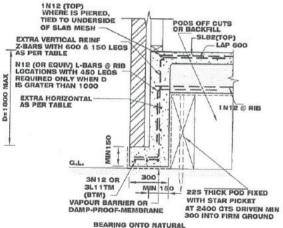
USE 65mm

MESH CHAIRS


Job No. SCALE: DATE: 1:100 11/07/17 DESIGNED: KZ

CHECKED: PD





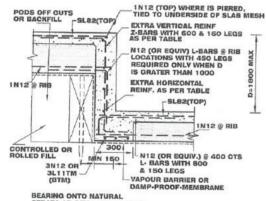STRATA OR PIERS(SEE NOTES) DEB DEEP EDGE BEAM (1800 MAX) SCALE = 1:20



STRATA OR PIERS(SEE NOTES) DEEP STEP BEAM (1800 MAX)

EXTRA REINFORCEMENT TO DEEP EDGE & DEEP STEP BEAM **EXTRA VARTICAL EXTRA HORIZONTAL** DEPTH 'D' REINFORCEMENT REINFORCEMENT 'D' IS LESS **THAN 400** NONE NONE D' IS BETWEEN 401 & 900 N12 @400CTS N12 @400CTS 'D' IS BETWEEN 901 & 1200 N12 @300CTS N12 @400CTS 'D' IS BETWEEN 1201 & 1800

N12 @300CTS

N12 @200CTS

REVISION DE	TAILS			
DESCRIPTION	DATE	NAME	Military CE STATE STATE, STATE, STATE,	
				DRAGH
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OFFICE: 16 VICTORIA STREET HALL PROJECT BLOCK O1 SECTION 80 CRACE Sch 2 2.2(a)(ii)


FOOTING DETAILS

Job No. SCALE: DATE: 1:100 11/07/17 Dwg No. DESIGNED: KZ **S3** CHECKEDI PD

CONSULTING	ENGINEE	RS STREE ACT, 24 Web: www.pdcen email i pdragh@bi	T,HALL,
PH: 04 FAX: (0	438 625 440 (2) 6230 9695	Web: www.pdcendmail: i pdragh@bi	glacers,com

SCALE = 1:20

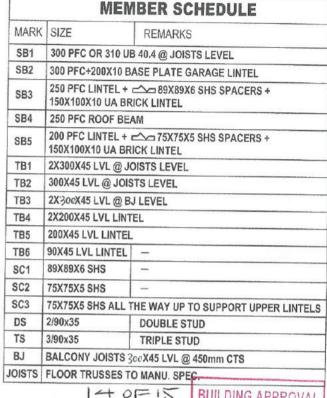Sch 2 2.2(a)(ii)




200 PFC

175 | 15

200 PFC + 75X75X5 SHS

JOIST & BEAM LAYOUT

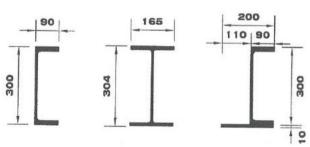SCALE = 1 : 100



BEAM SB1 OR 300 PFC

SCALE 1:10

BEAM SB1 310 UB 40.4 **SCALE 1:10**

BEAM SB2 300 PFC+200x10 BASE PLATE SCALE 1:10

89X89X6 SHS SPACERS 250 PFC 150X100X10 UA 90 20 || 100 40 BEAM B3

COLUMN

250 PFC + 89X89X6 SHS SPACERS + 150X100X10 UA SCALE 1:10

75X75X5 SHS SPACERS 150X100X10 UA 20 1100 40 **BEAM SB4 BEAM SB5**

250 PFC SCALE 1:10

BUILDING APPROVAL

Issued under s.28 of the Building Act 2004.

JOHN BATES

Cestifier Name

Lic. No. 1988 4388

1aci, 10a 105 BCA Occupancy Class

BCA Type of Construction

Issue date: 12/08/17

SPACERS + 150X100X10 UA tifier signature

REVISION DETAILS

PIERRE DRAGH CONSULTING ENGINEERS

OFFICE: STREET, HALL

FAX: (02) 6230 9695 email: pdragh@t

BLOCK O1 SECTION BO

Sch 2 2.2(a)(ii)

JOIST & BEAM LAYOUT

SCALE 1:10

SCALE: DATE: 1:100 11/07/17 DESIGNED: KZ

CHECKED: PD

Sch 2 2.2(a)(ii)

	MEMBE	R SCHEDULE
MARK	SIZE	REMARKS
SB1	200 PFC LINTEL - 150X100X10 UA B	75X75X5 SHS SPACERS +
TB1	200X45 LVL	whomas and the state of the sta
TB2	2X200X45 LVL	- 1
TB3	2X300X45 LVL	-
SC1	75X75X5 SHS FROM SLAB	
DS	2/90x35	DOUBLE STUD
TS	3/90x35	TRIPLE STUD

15 OF 15

BUILDING APPROVAL

Issued under s.28 of the Building Act 2004.

JOHN BATES

Certifier Name

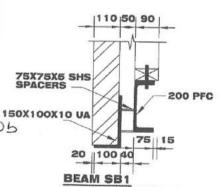
Lic. No. 1988 4388

Jaw 10a Law 10a

BCA Type of Construction

Issue date: 12,08/17

Certifier signature



200 PFC + 75X75X5 SHS SPACERS + 150X100X10 UA

REVISION DETAILS

NO. DESCRIPTION DATE NAME

PIERRE DRAGH
CONSULTING ENGINEERS

ROOF BEAM LAYOUT

SCALE = 1:100

DRAGH
TING ENGINEERS
TREET, HALL,
ACT, 26 18
PH 1 0438 625 440 Web: www.ydoenglineera.pd
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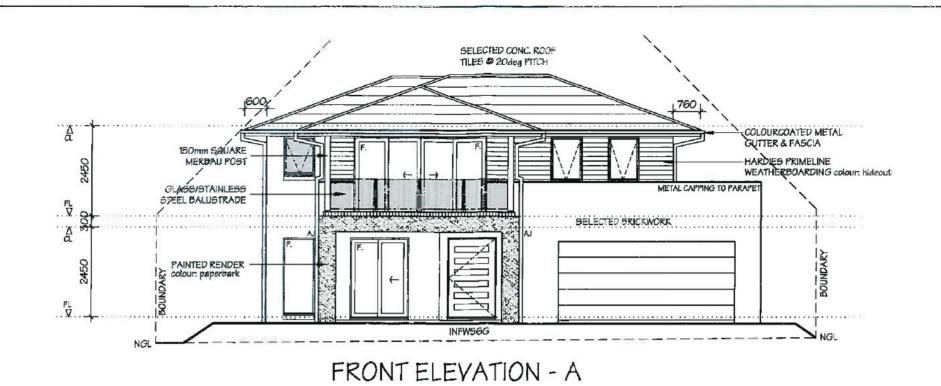
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Sch 2 2.2(a)(ii)

DRAWIN

ROOF BEAM LAYOUT

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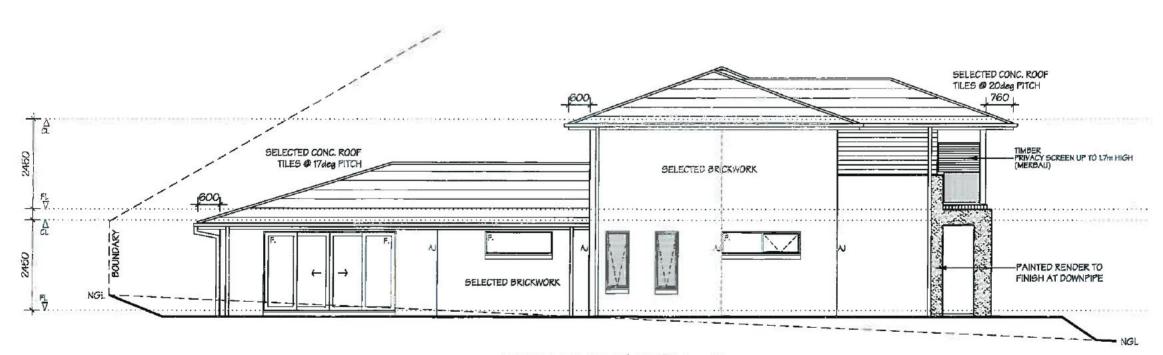


PAUL DIMG APPROVAL.

Insued under section 28 of the Building Act 2004
Coutined Building Solutions Fly Ltd

2 7 MAY 2013

Licence Not 200423203



SIDE ELEVATION - B

21924

NOTES

PLEASE NOTE: DETAILS SHOWN ON THESE PLANS ARE INTENDED TO BE ACCURATE - HOWEVER INFORMATION WRITTEN INTO INDIVIDUAL CONTRACTS WILL TAKE PRECEDENCE OVER PLANS

- * ALL DIMENSIONS ARE IN MILLIMETRES
- * DO NOT SCALE USE WRITTEN DIMENSIONS

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RAWSON HOMES

UNIT G1, 169 NEWCASTLE STREET FYSHWICK ACT 2609 TELEPHONE 02 6280 0800 FAX 02 6280 0700

Builder's Licence No. ACT - 19936252 Builder's Licence No. NSW - 33493C

CLIENT: Sch 2 2.2(a)(ii)

SITE ADDRESS:
BLOCK 2 SECTION 80
13 TABBARA CRES.
CRACE ACT

HOUSETYPE:		DR.
MODEL:	BEDARRA 31	
FACADE:	MAJESTIC	-
SPECIFICATION:	LUXE+ GOLD INCLUSIONS	CO

DRAWING TITLE:

ELEVATIONS 1

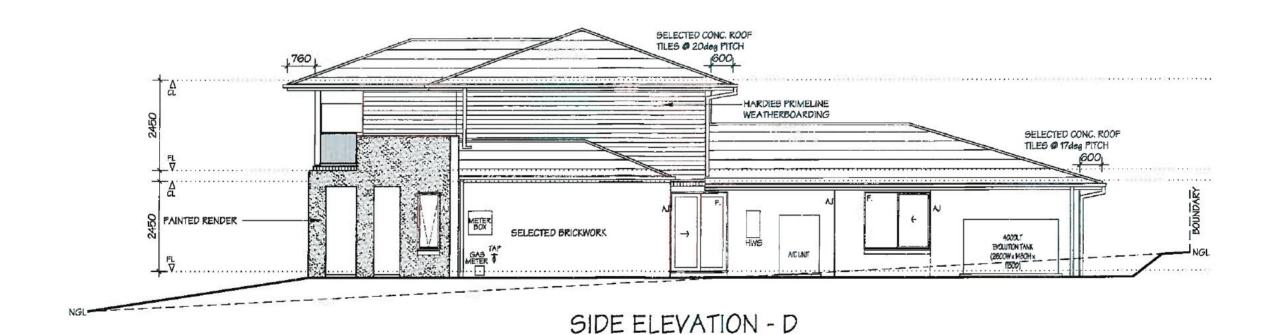


SUELDING APPTOVAL
Issued unfor extended file quiring act 2004
Condition Sulfiding Software Pty Ltd

2.7 MAY 2013

Licence No: 200426203

REAR ELEVATION - C



21924

NOTES

PLEASE NOTE: DETAILS SHOWN ON THESE PLANS ARE INTENDED TO BE ACCURATE - HOWEVER INFORMATION WRITTEN INTO INDIVIDUAL CONTRACTS WILL TAKE PRECEDENCE OVER PLANS

- * ALL DIMENSIONS ARE IN MILLIMETRES
- * DO NOT SCALE USE WRITTEN DIMENSIONS

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RAWSON HOMES

UNIT G1, 169 NEWCASTLE STREET FYSHWICK ACT 2609 TELEPHONE 02 6280 0800 FAX 02 6280 0700

Builder's Licence No. ACT - 19936252 Builder's Licence No. NSW - 33493C

Sch 2 2.2(a)(ii)

SITE ADDRESS:
BLOCK 2 SECTION 80
13 TABBARA CRES.
CRACE ACT

HOUSETYPE:		DRAI
MODEL:	BEDARRA 31	Т
FACADE:	MAJESTIC	0011
SPECIFICATION:	LUXE+ GOLD INCLUSIONS	cou

DRAWING TITLE:

ELEVATIONS 2

INSULATION:

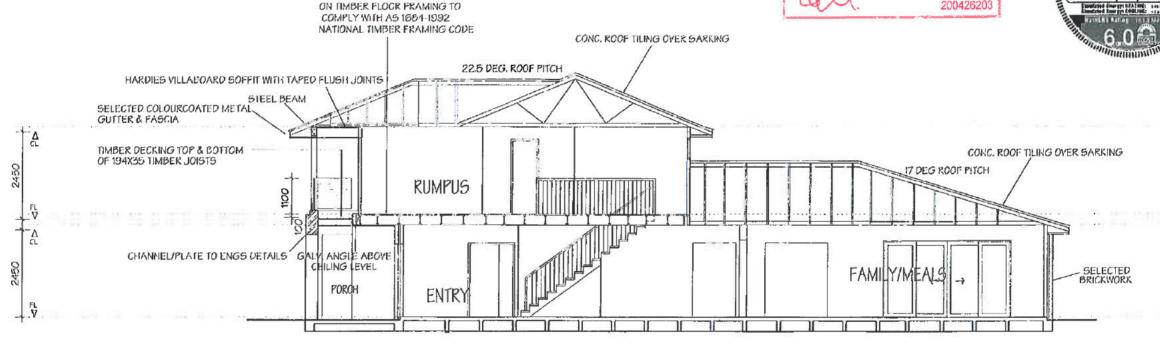
MAD TO CEILINGS (EXCLUDING CEILING (MER GARAGE, PORCH & ALFREDSO) RAID BETWEEN GARAGE & UNPER FLOOR TALO TO GLERHANGING SECTIONS OF UTTER FLOCK F20 TO EXTERNAL WALLS (INCLUDATS WALL BETWEEN GARAGE & NO 188) TRUINE DAMPER SEALS TO ALL ENHAUST ENHS REPLECTIVE FOLL CARRY PLANCER ROLF & TO EXTERNAL WALLS

BUILDING APPROVAL issued under anniien 28 of the Building Act 2004 Certified Building Bolutions Pty Ltd

2 7 MAY 2013


Licence No: 200426203





SECTION A-A

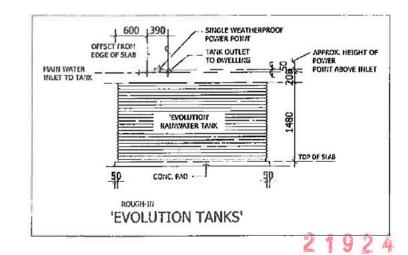APPROVED



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STRUCTURAL SHEET FLOORING

Builder's Licence No. ACT - 19936252 Builder's Licence No. NSW - 33493C



RC SLAB TO ENG'S DETAILS

SITE ADDRESS: **BLOCK 2 SECTION 80** 13 TABBARA CRES. CRACE ACT

HOUSETYPE:
MODEL -

DRAWING TITLE:

BEDARRA 31

MAJESTIC

FACADE: SPECIFICATION: LUXE+ GOLD INCLUSIONS

TLE COUNCIL AREA: **ACTPLA**

DRAWN BY:

28.02.13 SCALE: 1:100@A3

DATE DRAWN:

JOB No: SECTION

DRWG No.: J002558

CHECKED:

ISSUE: 07



MASS CONCRETE PIERS.
REFER PIER SPECIFICATION

START POD LOCATION

1090 SQ STANDARD POD

CENTRE LINE
OF RIB

3-N12 TRIMMERS 2000 LONG

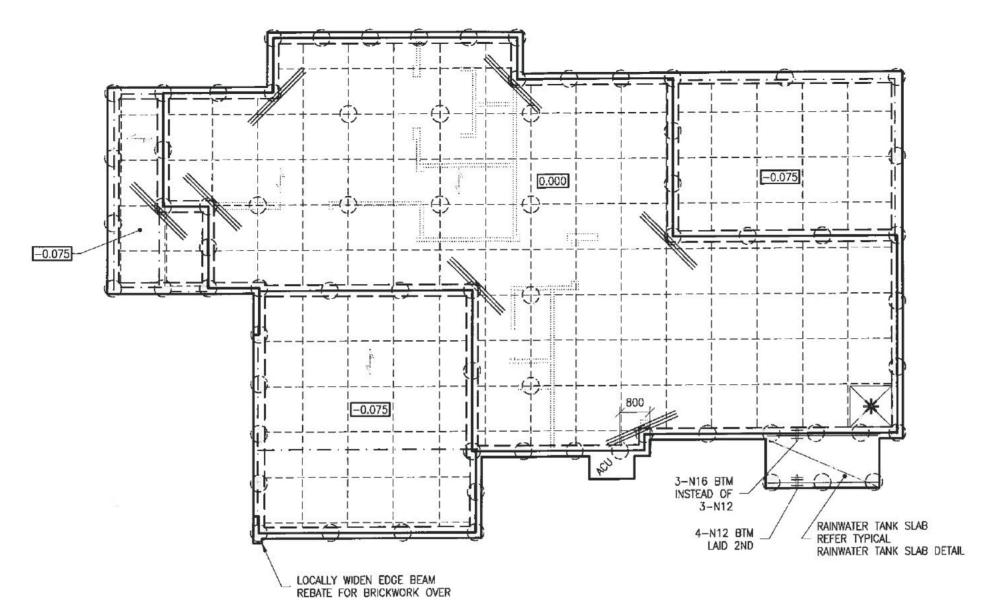
0.000 DENOTES TOP OF MAIN SLAB

DENOTES STEPDOWN FROM TOP OF MAIN SLAB

__ · __ STEEL/T!MBER BEAMS OVER

WALLS OVER

FLOOR JOIST DIRECTION OVER BY BUILDER



WAFFLE RAFT DESIGN LAYOUT DRAWING

WAFFLE RAFT SPECIFICATION SLAB THICKNESS: 85 SLAB FABRIC: SL72 CONCRETE STRENGTH: (F'c AT 28 DAYS) N20 U.N.O SLUMP: 100 MAXIMUM SIZE AGGREGATE 20

THE OWNERS ATTENTION SHALL BE DRAWN TO APPENDIX 'A' 'PERFORMANCE REQUIREMENTS AND FOUNDATION MAINTENANCE' OF AS 2870 AND CSIRO PUBLICATION 'GUIDE TO HOME OWNERS ON FOUNDATION MAINTENANCE AND FOOTING PERFORMANCE'. CURRENT EDITIONS.

ARTICULATION NOTE:

THIS SLAB IS DESIGNED FOR ARTICULATED MASONRY VENEER TYPE CONSTRUCTION AND ARTICULATION JOINTS ARE TO BE PROVIDED AS PER THE B.C.A. VOL.2 CURRENT EDITION

TRUSSED ROOF NOTE:

SLAB HAS BEEN DESIGNED FOR ROOF LOADING TO BE SUPPORTED BY PROPRIETARY TRUSSES ONTO EXTERNAL WALLS ONLY.

PIER SPECIFICATION		
DIAMETER Ø	400	
CONCRETE STRENGTH: (F'c AT 28 DAYS)	N20 U.N.O	
SLUMP:	100	
MAXIMUM SIZE AGGREGATE	20	

EXPECTED CONCRETE PIERS/FOOTINGS REQUIRED TO UNIFORM BEARING, ENGINEER AND/OR CERTIFIER TO INSPECT GROUND BEARING OF PIERS/FOOTINGS PRIOR TO POURING OF CONCRETE.

ENGINEER TO BE NOTIFIED IF PIERS/FOOTINGS COLLAPSE IN CONSTRUCTION. BUCKET OR SCREW PIERS MAY NEED TO BE USED

SITE CLASSIFIC	ATION	М
WIND CLASSIFIC	CATION	N2
SITE LOCATION CLASSIFICATION	REFER SITE CLASSIFICATION NOTES FOR DETAILS	SL3

IN ACCORDANG	S HAVE BEEN PREPARED CE WITH ARCHITECTURAL	
DESIGN NAME: BEDARRA	31 - MAJESTIC	
PREPARED BY:	RAWSON HOMES	
DRAWING/JOB No	. J002558	
REVISION/ISSUE:	B 94094	
DATED:	28-02-13	

IF IN DOUBT, CONTACT ENGINEER.



CONSULTING ENGINEERS
1/19 Jonathan Street, Greystanes NSW 2145 T: 02 9896 5494 F: 02 9636 1064

V: 8P8 0255 COPYRIGHT:

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ENGINEERING WRITTEN CONSENT

T: 02 4869 5003 F: 02 4869 5008

enquiries@residentialengineering.com.au

A.W. McCARTHY

B.Sc.(Eng), M.I.E.Aust, N.P.E.R., C.P.Eng.

APPROVED BY:

DATE:
11DRAWN:
SCALE:

1:100

CLIENT REF:

J002558

DATE:

11-04-13

DRAWN:

R.M.

CLIENT:

RAWSON

FAM:

UNIT 34/11-21 UNDERWOOD 6

HOMEGISH NSW 2140

HOMES
UNIT 34/11-21 UNDERWOOD ROAD
HOMEBUSH NSW 2140
TELEPHONE 02 9784 6442
FAX 02 9784 6932
Railder's Leannan No.334930

FOR:
Sch 2 2.2(a)(ii)

DRAWN DATE AMENDMENT REV JOB No: ISSU
RW1399

SITE ADDRESS:
BLOCK 2 SECTION 80
13 TABBARA CRESCENT, CRACE

DRAWN DATE AMENDMENT REV JOB No: ISSU
RW1399

SHEET No:
01 of 08

3/256 Argyle Street, Moss Vale NSW 2577

www.residentialengineering.com.au

GENERAL NOTES

- G1. Engineers structural drawings are signed and issued on the understanding that the builder maintains in force, proper and adequate contract works insurance and public liability insurance during the full course of the construction. and/or any maintenance period, claims of damage to any adjacent property or building is not the responsibility of the engineer.

 G2. These drawings shall be read in conjunction with
- all architectural and other consultants drawings and specifications and with such other written instructions as may be issued during the course of the contract, all discrepancies shall be referred to the architect for decision before proceeding with the work.
- All workmanship and materials shall be in accordance with the requirements of the current editions of the sag codes and there-by laws and ordinances of the relevant building authority.
- G4. Dimensions shall not be obtained by scaling the structural drawings, refer to architectural drawings for set out plan measurements, any set out dimensions shown on this document shall be verified by the builder.
- G5. Any discrepancies/substitution in these documents shall be referred to the engineer for decision before proceeding with the work.
- G6. The sections/details on these drawings are intended to give the structural specifications only. architectural sections/details on these drawings are illustrative only.
- G7. These documents are signed subject to certificate of inspection being issued by this firm, all piers, slab and footing reinforcement shall be inspected by the engineer prior to the pouring of concrete. give 24hrs notice to the engineer.

SITE CLASSIFICATION

C1. The site has been the subject of a geotechnical investigation requiring adherence to particular construction procedures and/or techniques. therefore these documents have been prepared using the recommendations of the geotechnical engineer.

Site classification: 'M' Classified by: DOUGLAS PARTNERS Report/Project no: 50563.09 Dated: AUGUST 2012

- C2. The footing details shown are for the site classification stipulated, while every care has been taken to verify that the information shown is correct, Residential Engineering takes no responsibility for variations which may occur in site conditions subsequent to construction.
- C3. SL1: less than 1km from breaking surf or less than 100m from salt water not subject to breaking surf or within heavy industrial areas.
- C4. SL2: 1km or more but less than 10km from breaking surf or 100m or more but less than 1km from salt water not subject to breaking surf
- C5. SL3: 10km or more from breaking surf or 1km or more from salt water not subject to breaking surf.
- C6. Refer BCA class 1 and class 10 buildings housing provisions volume 2 for tables: Protective Coatings For Steelwork (table 3.4.4.2) Corrosion Protection Of Built-In Structural Steel Members (table 3.3.3.2)

Corrosion Protection For Wall Ties (table 3.3.3.1)

FOUNDATION AND FILLING

- F1. Strip topsoil or other organic matter to a depth of 100 mm and stockpiled.
- Filling used for the support of a slab shall be controlled fill or rolled fill as follows:
- CONTROLLED FILL: Shall be placed, tested and certified by a qualified Geotechnical Engineer as defined in AS 3798. This is deemed to be adequate to support the footing system.
- ROLLED FILL: consists of material compacted in layers by repeated rolling with an excavator or similar equipment. The depth shall not exceed 0.6 m compacted in layers not more than 0.3 m thick for sand material or 0.3 m compacted in layers not more than .15m thick for other material.
- F3. Where fill consists of reactive clay, the fill shall be placed in a moist condition.
- F4. Any fill shall continue past the edge of the building by at least 1 m and shall be retained or battered beyond this point by a slope not steeper than 1:2.
- F5. Except for sites with aggressive soils, a blinding layer of sand is not required. Where used, the blinding layer of sand shall comply with rolled fill requirements

DRAINAGE DESIGN REQUIREMENTS

- D1. Surface drainage shall be designed and constructed to avoid water ponding against or near the footing.
- D2. The ground in the immediate vicinity of the perimeter footing shall be graded to fall 50 mm min away from the footing over a distance of 1 m.
- D3. The min height of the slab above F.C.L., landscaping or paving shall be 150 mm. Where adjoining paved areas slope away from the building, this height may reduced to 50 mm.
- D4. The base of trenches shall be sloped away from the building and backfilled in accordance with AS 2870
- D5. During construction, water run-off shall be collected and channeled away from the building.

CONCRETE PIERS

- P1. Pier diameter and locations are shown on plan. P2. u.n.o minimum pier depth is 600 mm below footings
- and wherever nominated should be socketed a minimum 300 mm into stiff clay.
- P3. All pier holes shall be cleaned and dewatered prior to the placement of concrete.
- P4. All piers shall be poured separate to footings. P5. It should be noted that if any of the footings
- encounter rock or shale, then all footings shall be piered to rock or shale. if partially piered to rock then articulation joints shall be provided at the rock/non-rock interface.
- P6. Concrete piers/footings are required to uniform bearing, engineer or council shall inspect ground bearing of piers/footings prior to pouring of

Strata	Stiff Clay	Rock and Shale	Notural Sand	
Min Bearing Capacity 'kPa'		600	150	

DAMP PROOFING MEMBRANE

APPROVED BY:

- DP1. A 0.2 mm min polyethylene damp-proofing high impact resistant membrane shall be placed beneath the slab so that the bottom surface is entirely underlaid and terminate at ground level.
- DP2. The membrane shall be branded continuously 'AS 2870 concrete underlay, 0.2 mm high impact resistant', together with manufacturer or distrubutors name, trademark or code.
- DP3. Lapping shall be 200 mm at joints and taped or sealed at plumbing penetrations with continuous close fitting sleeve or made continuous with the vapour barrier by taping and be made waterproof.

PLUMBING

PL1. Close cell polyethylene lagging shall be used around all stormwater and sanitary plumbing drain pipe penetrations through footings. The lagging shall be a minimum of 20 mm thick on H1 sites and 40 mm thick on Class H2 and Class E sites. Vertical penetrations do not require lagging. Additionally drains attached to or emerging from underneath the building including stormwater, sanitory and discharge pipes shall incorporate flexible joints immediately cutside the footing and commencing within 1 m of the building perimeter to accommodate a total range of differential movement of the site (ys).

REINFORCEMENT AND FIXING

- R1. Minimum concrete cover as follows:
 - 40 mm to unprotected ground
 - 30 mm to a membrane in contact with the ground
 - 40 mm to an external surface 20 mm to an internal surface
- R2. Slab fabric shall be supplied in flat sheets and be lapped one full square plus 25 mm at splices and placed on bar chairs at 1 m cts both ways.
- R3. Reinforcing bars shall have a lap length at splices not less than:
 - 500 mm up to a bar ø of 12 mm 700 mm up to a bar of 16 mm
- At T and L intersections the bars shall be continued across the full width of the intersection.
- R4. Service penetrations are permitted through the middle third of the depth of the edge beam and stiffening
- R5. Reinforcement and void formers shall be fixed in position prior to concreting by means of proprietary spacers, bar chairs with bases, ligatures or other appropriate fixings to achieve the required reinforcement position and concrete cover.
- R6. Bar reinforcement shall be tied beneath the slab fabric if used or otherwise placed on bar chairs
- Concrete shall be transported, placed, compacted and cured in accordance with good building practice.
- Trenches, pier holes and beams shall be dewatered and cleaned prior to concrete placement such that no significant softened or loosened material remains.
- R9. Concrete in trenches and beams shall be mechanically vibrated.

EXCAVATIONS

- E1. Temporary excavations in the area of the footing shall be carried out only where adequate support for the footing system is maintained such as piering beneath the expected excovation level or underpinning.
- E2. Permanent excavations of any vertical or near vertical structure within 2 m of the building and deeper than 0.6m in material other than rock shall be adequately retained or battered.
- Excavations shall not extend below a line drawn at 30' for sand, 45' for clay to the horizontal from the bottom edge of the footing/pier without prior assessment.

AGGRESSIVE SOILS

- A1. Buildings with masonry or concrete exposed to saline soils or to acid sulfate soils shall be protected from the aggressive soil or groundwater.
- A2. Where a layer of bedding sand 100 mm deep is provided, it shall comply with the 'FOUNDATION AND FILLING' notes.
- A3. Protection requirements from Geotechnical & local authorities shall be adhered to and provided to this office before commencing detailing.

SHRINKAGE CRACKING CONTROL

- S1. At re-entrant corners, one strip of 3-L11 or 3-N12 bar 2 m long shall be placed across the direction of potential cracking.
- S2. Where brittle floor coverings are to be used over an area greater than 16 m² the following applies:
- Slab reinforcement in part of the slab which brittle finishes are applied shall not be less than SL92 or equivalent.
- (b) The bedding system for brittle coverings shall be selected on the basis of the expected slab movement
- (c) The placement of floor coverings shall be delayed by a minimum period of 3 months.
- S3. Water shall not be added to the concrete on site so as to increase the slump above that specified.
- S4. Curing the concrete shall start immediately after finishing by continually wetting for 7 days min. Plastic or wax liquid sprays may be used in accordance with the manufacturers specifications. extra precaution such as the method of evaporative retardation (the use of aliphatic alcohols) is recommended during hot weather pours to help avoid thermal related slab cracking.

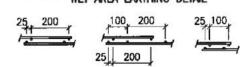
SUB-TERRANEAN TERMITE PROTECTION AND MAINTENANCE

- T1. All works to be in accordance with AS 3660.1
- T2. Any future cracking occurring in the slab/footing system is to be assessed by a qualified pest expert and where directed be sealed by epoxy injection.
- T3. Inspections of the residence and immediate surrounds to be carried out by a qualified pest expert on an annual basis by the home owner.
- T4. Site maintenance is the responsibility of the owner. All recommendations outlined in the CSIRO phamphlet. Building Technology File 18, Foundation Maintenance and Footing performance: A Homeowners Guide, and its recommendations should be followed in full.


MASONRY NOTES

- M1. Load bearing masonry shall comply with AS 3700 M2. Mosonry, Mortar durability and Articulation shall comply with the B.C.A class 1 and 10 buildings volume 2, form TN61 articulated walling and AS 2870
- M3. Internal brickwork built off the slab shall be laid on two layers of 'alcor' or '3 ply malthoid' or equivalent material.







ALTERNATIVE METHODS OF LAPPING OF MESH

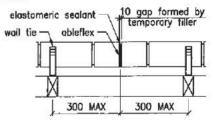

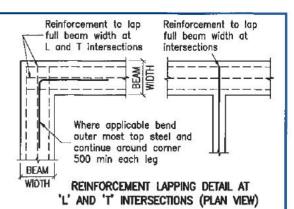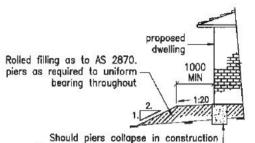
ARTICULATION JOINT AND WALL TIE DETAIL All wall ties to be built in and fixed to frame progressively as construction proceeds spaced at each side of expansion joints and at each third course, the spacing of all other ties shall be as described in the b.c.a class 1 and 10 buildings housing provisions volume 2.






then screw piers may need to be used

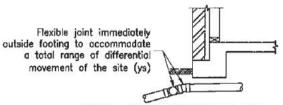FILLING SPECIFICATION DETAIL



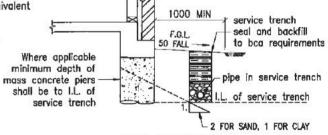UNDER SLAB PLUMBING DETAIL FOR FOR H1, H2 AND E SITES



HOUSE SERVICES DETAIL It is outside the control of the engineer to ensure the drainage contractor complies with this detail. The builder shall ensure that the drainage contractor complies with this detail in full

HORIZONTAL		
HURIZUNTAL	VERTICAL	
SPACING	SPACING	
600mm	600mm	
600mm	600mm	
600mm	430mm (5 COURSES)	
	600mm	

wall tie spacings around openings 300cts ew

polymer wall ties rated "light duty only" (w28n1)

RESIDENTIAL NSW: BPB 0255 VIC: EC 24609 ENGINEERING QLD: RPEQ 4109

T- 02 9896 5494 F- 02 9636 1064 1/19 Jonathan Street, Greystanes NSW 2145 3/256 Argyle Street, Moss Vale NSW 2577 T: 02 4869 5003 enquiries@residentialengineering.com.au www.residentialengineering.com.au

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J002558 DATE: 11-04-13 DRAWN: R.M.

SCALE:

CLIENT REF:

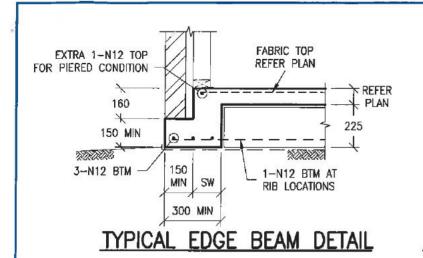
CLIENT: RAWSON

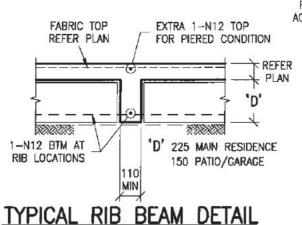
UNIT 34/11-21 UNDERWOOD ROAD HOMEBUSH MSW 2140 TELEPHONE 02 9764 6442 FAX 02 9764 6992 Builder's License No.334930

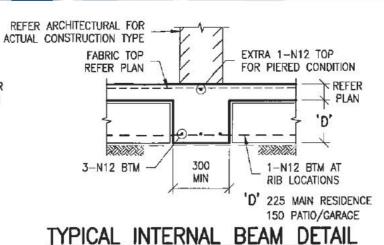
Sch 2 2.2(a)(ii)

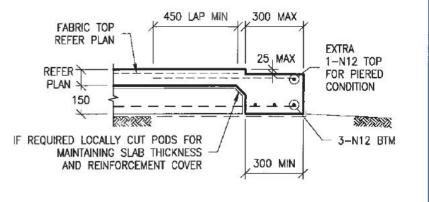
SITE ADDRESS: **BLOCK 2 SECTION 80** 13 TABBARA CRESCENT, CRACE

(vp = permissable stress method) **AMENDMENT** 02 of 08











TYPICAL GARAGE DOOR REBATE DETAIL

. GARAGE DOOR REBATE SHOWN IS DIAGRAMMATIC ONLY AND SHALL BE READ IN CONJUNCTION WITH THE ARCHITECTURAL FOR ACTUAL REBATE DEPTH x WIDTH.

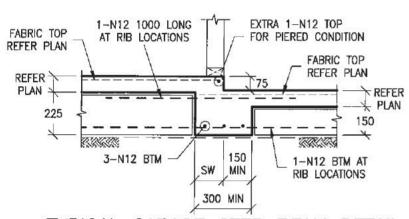
 IF REQUIRED PROVIDE 10mm FALL FROM BACK OF GARAGE TO GARAGE DOOR OPENING





TYPICAL GARAGE STEP BEAM DETAIL

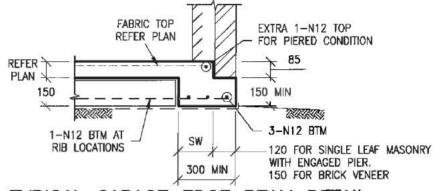

TYPICAL GARAGE EDGE BEAM DETAIL

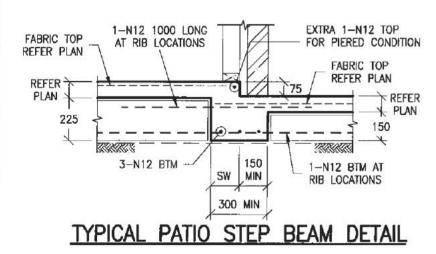

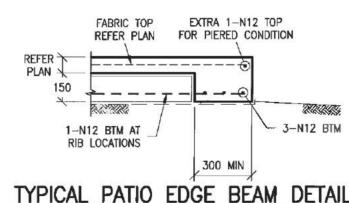

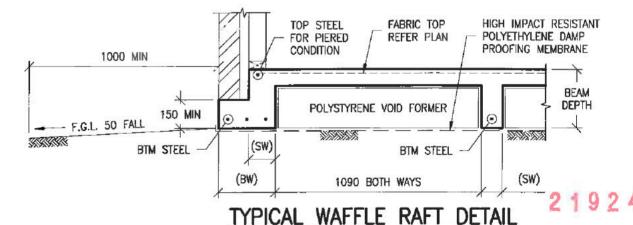

RW11(RIBBED WIRE GRADE 500RW) MAY BE USED IN LIEU OF N12'S

BEAM WIDTH (BW)	BTM STEEL
110 TO 150	1-N12
151 TO 220	2-N12
221 TO 330	3-N12
331 TO 440	4-N12

STEM WIDTH (SW)	ADDITIONAL TOP STEEL IN ADDITION TO SLAB FABRIC	
110 TO 150	NIL	
151 TO 220	1-N12	
221 TO 330	2-N12	
331 TO 440	3-N12	

IF IN DOUBT, CONTACT ENGINEER.



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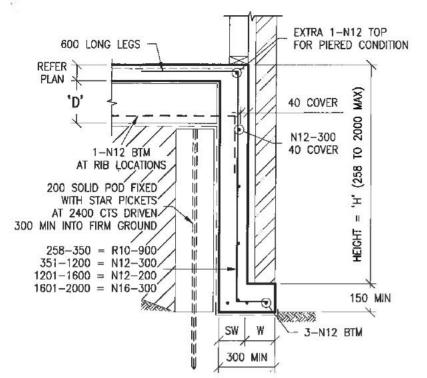
J002558 DATE: 11-04-13 DRAWN: R.M. SCALE:

CLIENT REF:

CLIENT: RAWSON

UNIT 34/11-21 UNDERWOOD ROAD HOMEBUSH NSW 2140 TELEPHONE 02 9784 8442 FAX 02 9764 6992

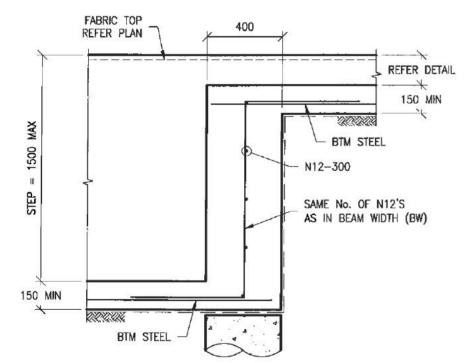
DRAWN DATE AMENDMENT ISSUE: Sch 2 2.2(a)(ii) SITE ADDRESS: SHEET No: **BLOCK 2 SECTION 80** 03 of 08 13 TABBARA CRESCENT, CRACE



TYPICAL DEEPENED EDGE BEAM DETAIL

'D' = 225 MAIN RESIDENCE 150 PATIO/GARAGE


'W' = 120 MIN FOR SINGLE LEAF MASONRY WITH ENGAGED PIER. 150 MIN FOR BRICK VENEER




TYPICAL DEEPENED EDGE BEAM TRANSITION DETAIL

DEEPENED BEAM STEM WIDTH TABLE


HEIGHT (H)	(SW) STEM WIDTH
UP TO 1200	150
1201 TO 1600	200
1601 TO 2000	250

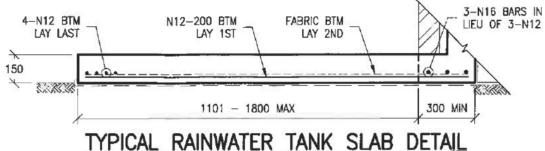

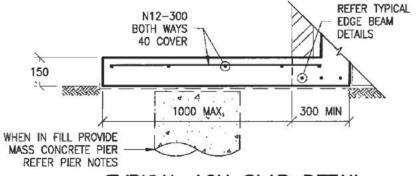THIS DETAIL IS APPLICABLE AT ALL TYPICAL EDGE BEAMS. CONSTRUCTION TYPE MAY VARY FROM SHOWN



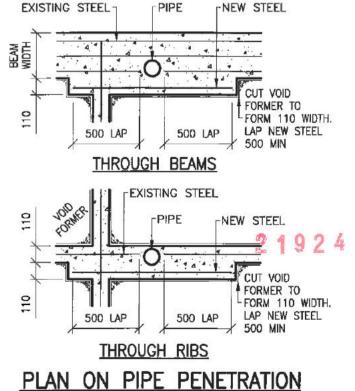TYPICAL ACU SLAB DETAIL THIS DETAIL IS APPLICABLE AT ALL TYPICAL EDGE BEAMS. CONSTRUCTION TYPE MAY VARY FROM SHOWN



IF IN DOUBT, CONTACT ENGINEER.



Sch 2 2.2(a)(ii) 350 BEARING EACH END 110 BEARIN EACH EN **TPO** 110 BE

STEELWORK DESIGN MARKING DRAWING

FLOOR JOIST DIRECTION OVER BY BUILDER

STEEL BEAM PROFILE NOTE:

THE BEAM(S) SPECIFIED ON THIS DRAWING DOES NOT REPRESENT THE ONLY POSSIBLE STRUCTURAL SOLUTION. PLEASE CONTACT RESIDENTIAL ENGINEERING IF AN ALTERNATIVE BEAM PROFILE WOULD BE PREFERRED FOR ARCHITECTURAL OR CONSTRUCTABILITY REASONS.

MEMBER SCHEDULE

21924

ITEM	DESCRIPTION	
B1	250 PFC	
B2	250 PFC	
В3	150 x 100 x 10 RSA	
B4	310UB32	
B5	300 PFC + 200 x 10 MS PL	
B6	230 PFC + 300 x 10 MS PL	
B7	180 PFC + 300 x 10 MS PL	
B8	180 PFC + 300 x 10 MS PL	
B9	150 x 100 x 10 RSA - BRICKWORK ONLY	
TP1	4 / 90 x 45 MGP10 STUDS	
TP0	TIMBER POST BY OTHERS	

IF IN DOUBT, CONTACT ENGINEER.



1/19 Jonathan Street, Greystanes NSW 2145 T: 02 9896 5494 F: 02 9636 1064 3/256 Argyle Street, Moss Vale NSW 2577 T: 02 4869 5003 F: 02 4869 5008 www.residentialengineering.com.au enquiries@residentialengineering.com.au

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APPROVED BY

B.Sc.(Eng), M.I.E.Aust, N.P.E.R., C.P.Eng.

CLIENT REF: J002558 DATE: 11-04-13

R.M.

1:100

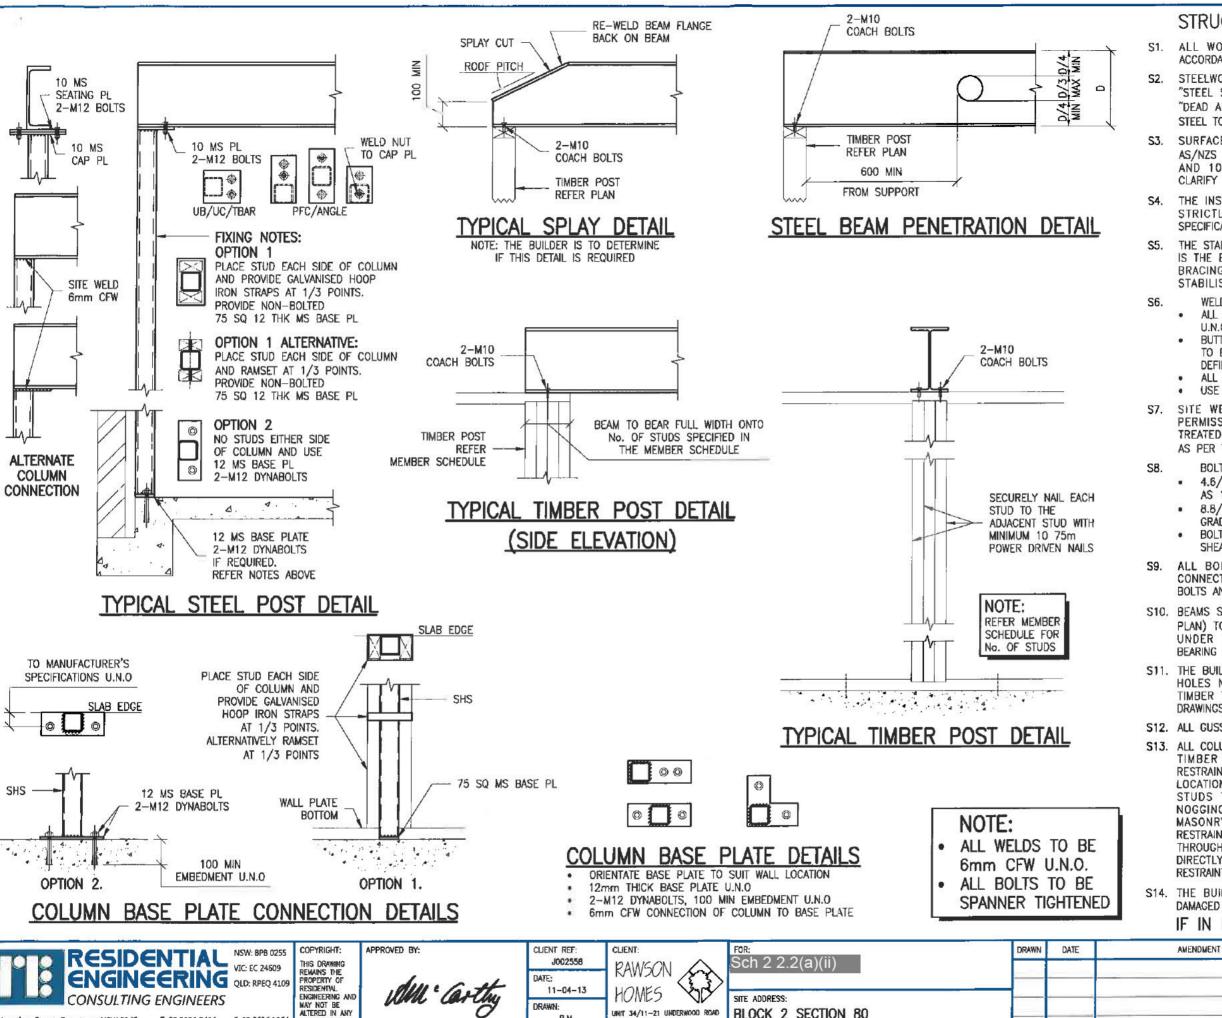
SCALE:

UNIT 34/11-21 UNDERWOOD ROAD HOMEBUSH NSW 2140 TELEPHONE 02 9764 6442 FAX 02 9764 6992 Builder's License No.334930

Sch 2 2.2(a)(ii) SITE ADDRESS

BLOCK 2 SECTION 80 13 TABBARA CRESCENT, CRACE


AMENDMENT DATE DRAWN RW1399 05 of 08




STRUCTURAL STEEL NOTES

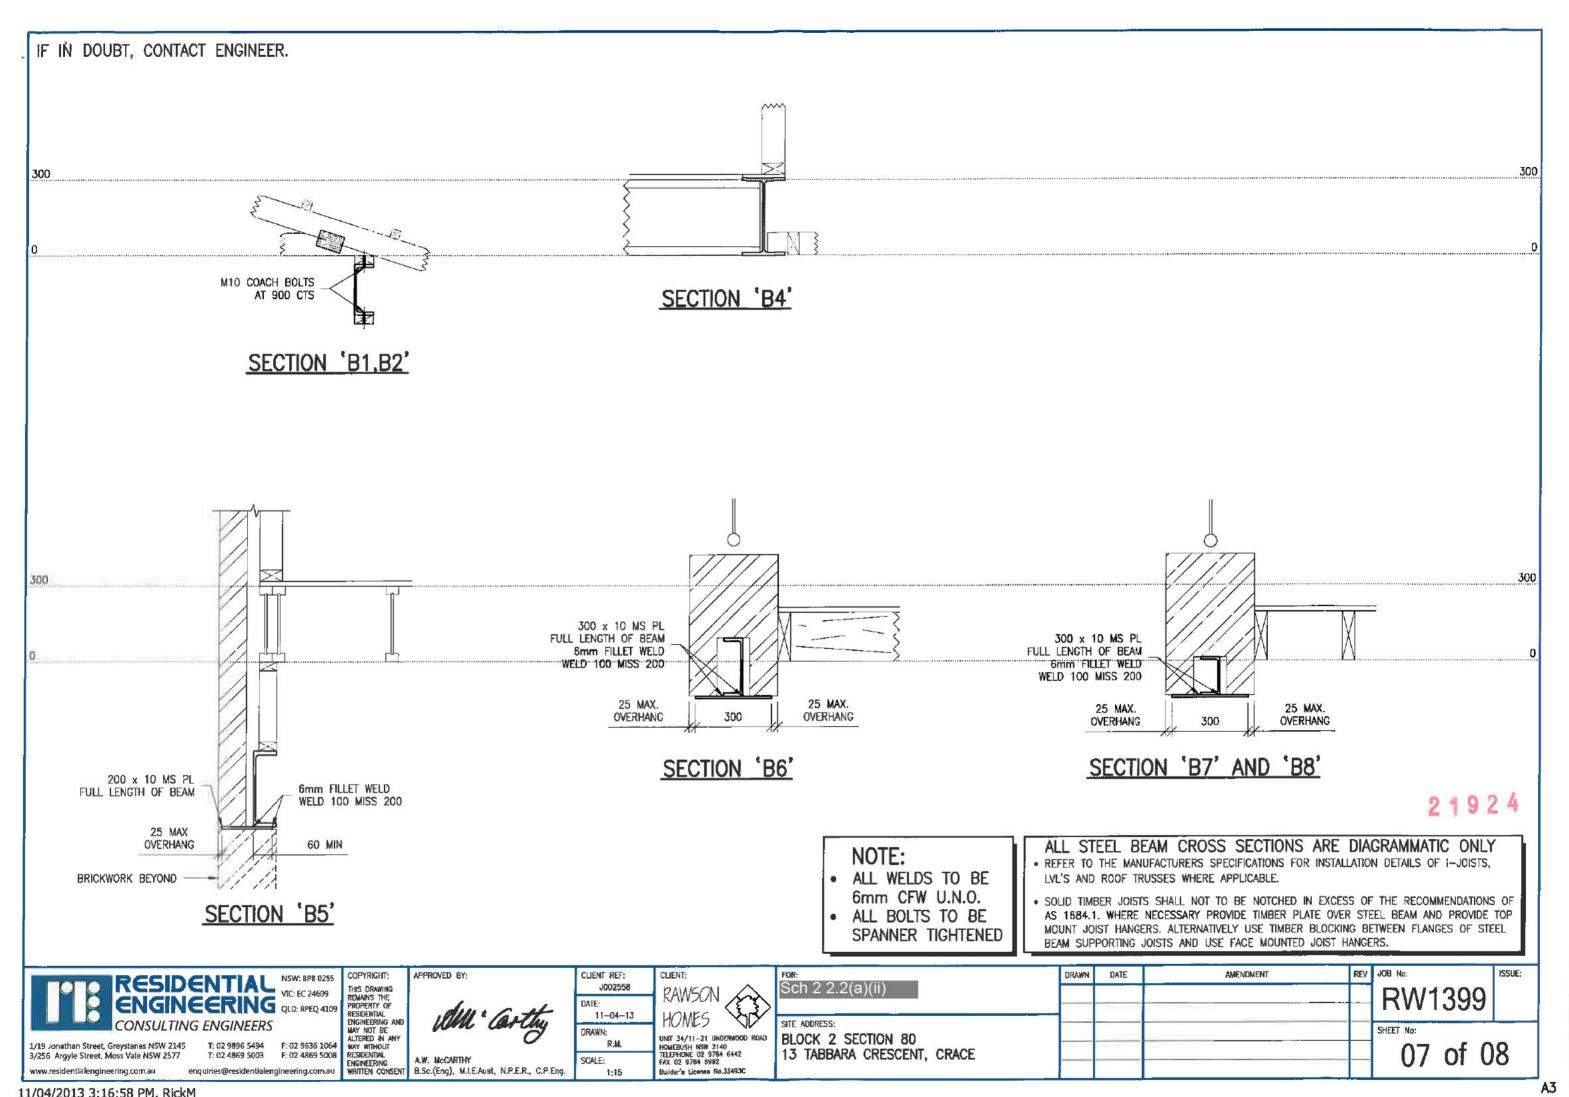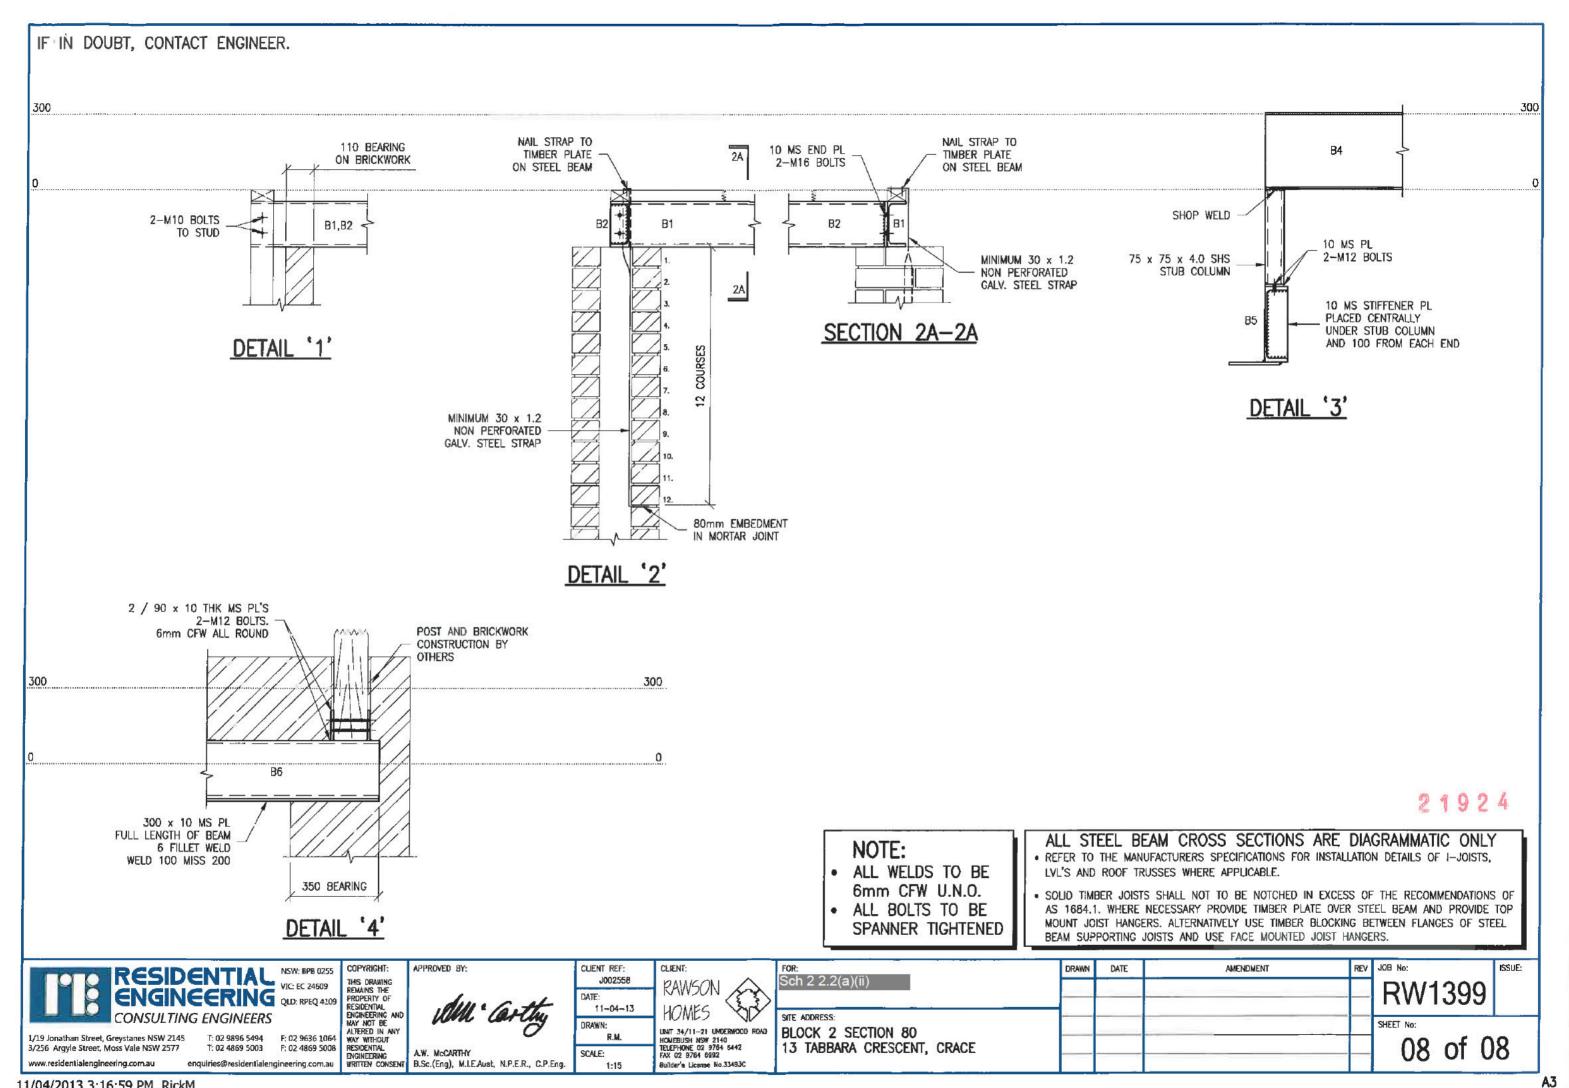- ALL WORKMANSHIP AND MATERIALS SHALL BE IN ACCORDANCE WITH AS 4100.
- STEELWORK DESIGNED IN ACCORDANCE WITH AS 4100 "STEEL STRUCTURES CODE" AND AS 1170.1/AS 1170.2 "DEAD AND LIVE LOADS AND WIND LOADS". STRUCTURAL STEEL TO BE GRADE (BHP 300 PLUS)
- SURFACE PREPARATION AND FINISH TO COMPLY WITH AS/NZS 2312 AND BUILDING CODE OF AUSTRALIA CLASS 1 AND 10 BUILDINGS VOLUME 2. THE BUILDER MUST CLARIFY HIS CONTRACTUAL OBLIGATIONS IN THIS REGARD.
- THE INSTALLATION OF GALINTELS AND 'T' BARS TO BE STRICTLY IN ACCORDANCE WITH MANUFACTURERS SPECIFICATIONS.
- THE STABILITY OF THE STRUCTURE DURING CONSTRUCTION IS THE BUILDERS RESPONSIBILITY. ADEQUATE TEMPORARY BRACING SHALL BE PROVIDED AS IS NECESSARY TO STABILISE THE STRUCTURE DURING CONSTRUCTION.
- ALL WELDS TO BE 6mm CONTINUOUS FILLET WELD IINO
- BUTT WELDS WHERE INDICATED IN THE DOCUMENTS TO BE COMPLETE PENETRATION BUTT WELDS AS DEFINED IN AS 1554.
- ALL SHOP WELDS TO BE FULLY WELDED U.N.O.
- USE E41XX ELECTRODES FOR ALL WELDING U.N.O.
- SITE WELDING OF HOT DIP GALVANISED STEEL IS PERMISSIBLE IF UPON COMPLETION THE WELDS ARE TREATED WITH THE APPROPRIATE COATING FOR SEVERE AS PER THE B.C.A AND AS/NZS 2312.
- **BOLT DESIGNATION:**
 - 4.6/S COMMERCIAL BOLT OF GRADE 4.6 TO AS 1111 SNUG TIGHTENED
- 8.8/S HIGH STRENGTH STRUCTURAL BOLTS OF GRADE 8.8 TO AS 1252 SNUG TIGHTENED
- BOLTS TO BE PROVIDED WITH THREADS CLEAR OF SHEAR PLANE.
- S9. ALL BOLTS TO BE COMMERCIAL GRADE U.N.O. NO CONNECTION SHALL HAVE LESS THAN TWO BOLTS, ALL BOLTS AND WASHERS TO BE GALVANISED.
- S10. BEAMS SUPPORTED ON BRICKWORK (BEARING NOTED ON PLAN) TO HAVE INCOMPRESSIBLE PACKING AS REQUIRED UNDER THE ENDS OF THE BEAM TO ENSURE EVEN BEARING ON THE BRICKWORK.
- S11. THE BUILDER SHALL PROVIDE ALL CLEATS AND DRILL ALL HOLES NECESSARY FOR FIXING STEEL TO STEEL AND TIMBER TO STEEL, WHETHER OR NOT DETAILED IN THE
- S12. ALL GUSSET PLATES TO BE 10mm THICK U.N.O.
- S13. ALL COLUMNS AND BEAMS SHOWN ON THE DRAWINGS FOR TIMBER FRAMED BUILDINGS SHALL BE LATERALLY RESTRAINED BY THE BUILDING FRAME AT EACH SUPPORT LOCATION THROUGH POSITIVE SCREW FIXING OF WALL STUDS TO THE COLUMNS AND EITHER JOISTS OR NOGGINGS TO THE BEAMS. FOR ARTICULATED FULL MASONRY BUILDINGS, COLUMNS WILL BE LATERALLY RESTRAINED BY BRICKWORK AT EACH SUPPORT LOCATION THROUGH POSITIVE FIXING OF WALL TIES. WHERE A BEAM DIRECTLY SUPPORTS A CONCRETE SLAB NO ADDITIONAL RESTRAINT IS REQUIRED.
- S14. THE BUILDER IS TO MAKE GOOD AND/OR REPAIR ALL DAMAGED SURFACES DURING PERFORMANCE OF THE WORK. IF IN DOUBT, CONTACT ENGINEER.







SEDIMENT CONTROL MEASURES:

THE DEVELOPMENT WILL COMPLY WITH BEST PRACTICE GUIDELINES - PREVENT POLILUTION FROM REGIDENTIAL BUILDING SITES, MARCH 2006.

WATER SENSITIVE URBAN DESIGN NOTE:

THIS DEVELOPMENT ACHIEVES 54% REDUCTION IN MAKING WATER CONSUMPTION COMPARED TO AN EQUIVALENT DEVELOPMENT CONSTRUCTED IN 2003, USING THE ACTPLA ONLINE ASSESSMENT TOOL.

PRIVATE OPEN SPACE NOTE:

THIS DEVELOPMENT WILL COMPLY WITH ROLE 850 OF THE SINGLE DWELLING. BUILDING CODE AND A MINIMUM OF BOYLOF THE PRIVATE OPEN SPACE WILL BE RETAINED AS PLANTING AREA.

Percentage	Reduction =	54%
The state of the s	A CONTRACTOR OF STATE	

Indoor Information	
Number of bedrooms in the house	4
What is the water rating of the shower head?	18.0
What is the water rating of the clothes washing machine?	15cu 🔻
What is the veilor rating of the distribusher?	49ar 💌
What is the water rating of the tallet?	45ar (*)

Site information	
Site area (m²)?	540
Roof area (including house and garage or carport) (nity)	242

Rain water tank information		
Is there going to be a water tank installed)	Yes (*)	
What is the size of the tank (L)?	4000	
What is the approx root area flowing into the week (m/s)	121	
What will be the use for the water in the tank?	Gastra Toda Andlarving 14	

NOTE

- * TITLE BOUNDARIES ARE FROM PLAN DIMENSIONS ONLY AND WERE NOT MARKED OR DETERMINED AS PART OF THIS SURVEY.
- ONLY SERVICES VISIBLE AT THE TIME OF THIS SURVEY ARE SHOWN ON THIS PLAN.
- * ALL TREES LESS THAN 12 METRES HIGH ARE SHOWN WITH NO HEIGHT.

RAWSON HOMES

Book.

UNIT G1, 169 NEWCASTLE STREET FYSHWICK ACT 2609 TELEPHONE 02 6280 0800 FAX 02 6280 0700

COMMS

SMH

The driveway over the verge is to

match the footpath material and finish as por the Crace Pattern

PATH

18.00

DWM

CRESCENT

ABARRA

GUTTER

KERB

93

Builder's Licence No. ACT - 19936252 Builder's Licence No. NSW - 33493C

Sch 2 2.2(a)(ii) SITE ADDRESS: BLOCK 2 SECTION 80 13 TABBARA CRES.

Lot Area: 540m² Peter J. Shaw Registered Surveyor Contour Interval: 0.25m HOUSETYPE:

SEC 80 DP 11014

Refer to the Hydraulic Service within the Standard Servicing Conditions of the Crace Pattern Book for the requirement to install a SW inspection riser or sump with trafficable cover within lease boundary to satisfy Crace WSUD regulrements.

Refer to Information sheet on Services and Verge Management within the Crace Pattern Book on verge protection measures during construction of your home.

The height of site cuts at the boundary is restricted to a max. 1 metre with boundary retaining walls also not exceeded to 1 metre.

Front rotaining wall to be stone, masonry or concrete blocks. Timber sleepers and coment look-a-like eleepors are not permitted beyond the building line.

> 28/03/2013 Roderick Tomkyna 61152

APPROVED

18.00

12

13

PRIVATE OPEN SPACE BLOCK AREA 540.00m² P.P.O.S. REQUIRED 54.00n:2 P.P.O.S. ACHIEVED 190.00m² P.O.S. REQUIRED 274.00m² P.O.S. ACHIEVED 362.40m²

PLEASE NOTE: DETAILS SHOWN ON THESE PLANS ARE INTENDED TO BE ACCURATE - HOWEVER INFORMATION WRITTEN INTO INDIVIDUAL CONTRACTS WILL TAKE PRECEDENCE OVER PLANS

- * ALL DIMENSIONS ARE IN MILLIMETRES
- * DO NOT SCALE USE WRITTEN OWNERSIONS

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CRACE ACT

MODEL: BEDARRA 31 FACADE: MAJESTIC SPECIFICATION: LUXE+ GOLD INCLUSIONS

DRAWING TITLE:

EULDING APPROVAL

Ivalied under section 28 of the Building Act 2004 Certified Building Solutions Pty Ltd

2 7 MAY 2013

Licence No

PC3

Gm x E.T

3

30,00

200°00'

FILL

30.000

LEGEND

SMH DENOTES SEWER MANHOLE WM DENOTES WATER METER

COMMS DENOTES COMMUNICATIONS

GARAGE

FR 507211

TLE COUNCIL AREA: **ACTPLA**

DRAWN BY:

CHECKED:

SCALE:

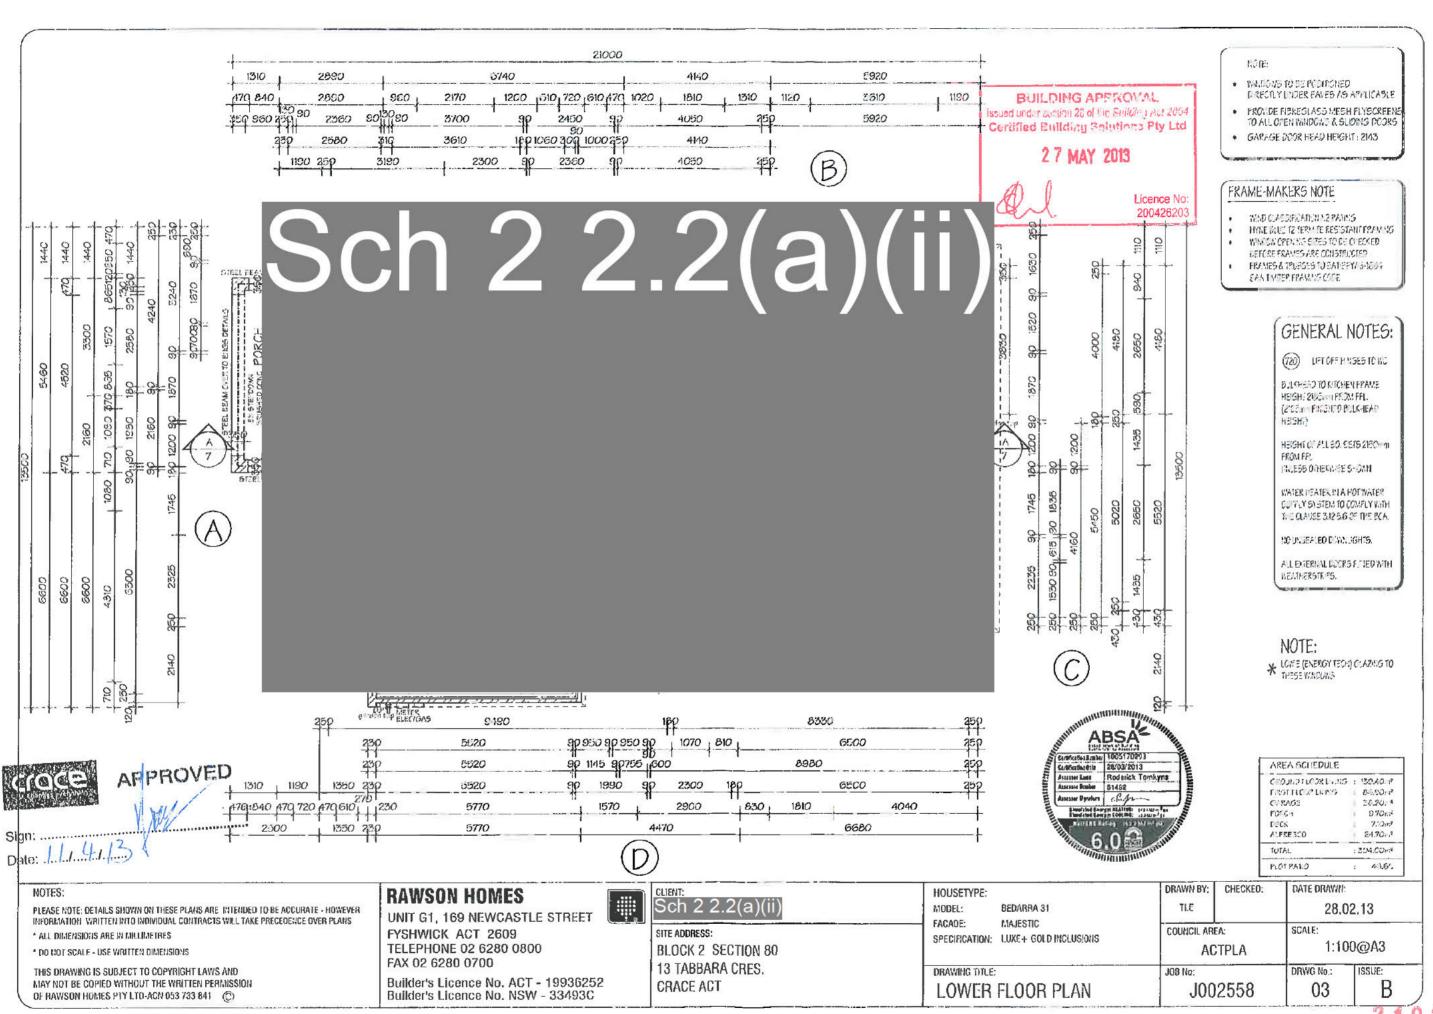
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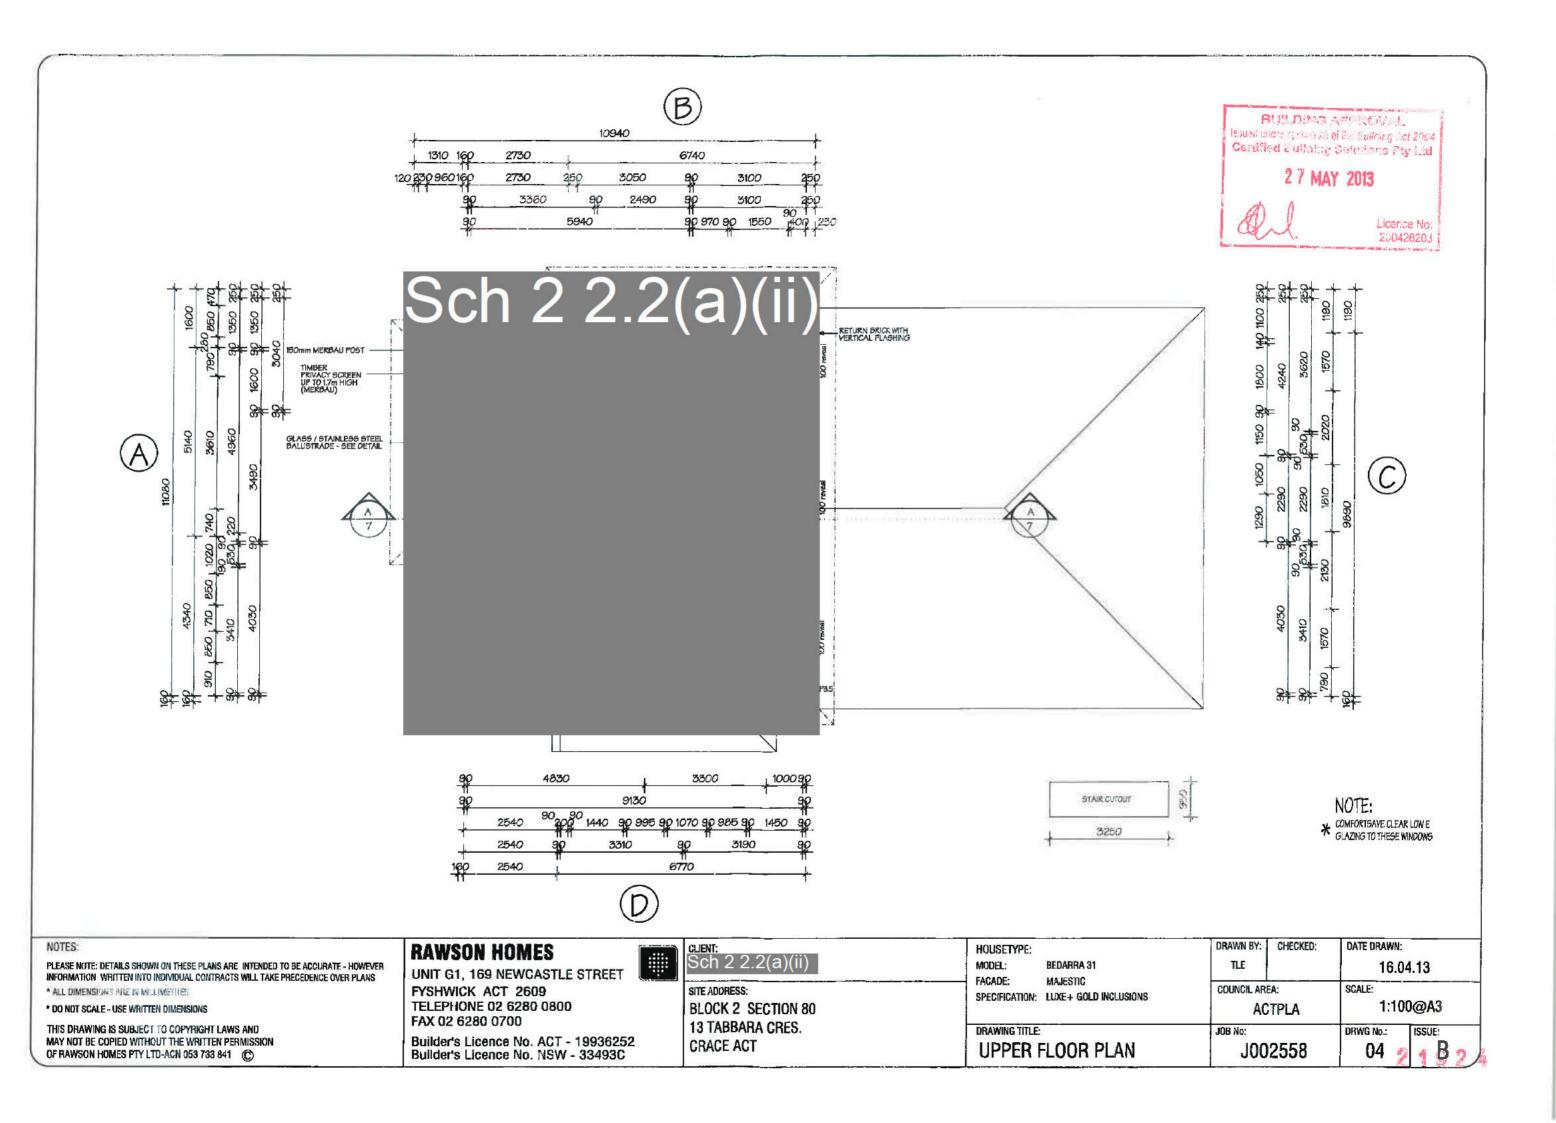
DATE DRAWN:

28.02.13

JOB No: SITE PLAN J002558

ISSUE:



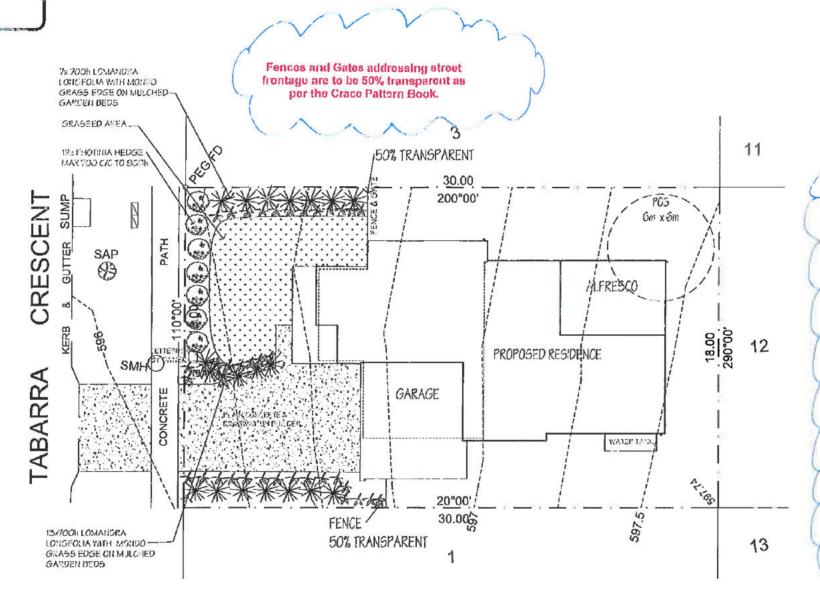


LANDSCAPING:

THE BUILDER IS NOT RESPONSIBLEFOR LANDSCAPING. THIS LANDSCAPE PLAN IS INDICATIVE ONLY, ALL LANDSCAPING & FENCING IS TO COMPLY WITH THE CRACE PATTERNBOOK.



SEC 80 DP 11014



LEGEND

COMMS DENOTES COMMUNICATIONS PIT SMH DENOTES SEWER MANHOLE WM DENOTES WATER METER

Driveway over the Verge and turting the Vorge with Legend Couch is the responsibility of the purchaser

The use of brightly coloured gravel in large proportions to the front landscaping, under the Front Vertical Edge, or directly to street frontage is not permitted. Natural earthy toned organic bark or woodchip mulch is to be used as per the Crace Pattern Book

A vertical edge which could incorporate a hedge, retaining wall or planter box between 600-900mm high must be provided along the front boundary.

Refer to the fact sheet Establishing Your Front Verge in the Crace Pattern Book for the establishment of your front verge turf.

Refer to Element 6 and the landscape design guidelines within the Crace Pattern Book for appropriate planting sizes, locations and species to front gardens.



APPROVED

PLEASE NOTE: DETAILS SHOWN ON THESE PLANS ARE INTENDED TO BE ACCURATE - HOWEVER INFORMATION WRITTEN INTO INDIVIDUAL CONTRACTS WILL TAKE PRECEDENCE OVER PLANS

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RAWSON HOMES

UNIT G1, 169 NEWCASTLE STREET FYSHWICK ACT 2609 TELEPHONE 02 6280 0800 FAX 02 6280 0700

Builder's Licence No. ACT - 19936252 Builder's Licence No. NSW - 33493C



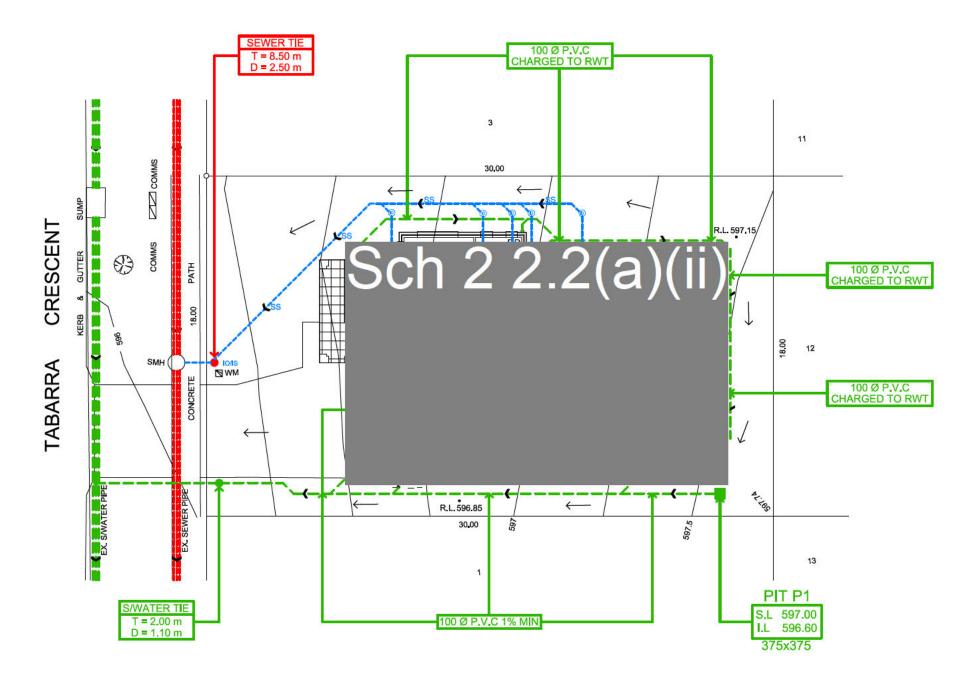
SITE ADDRESS: BLOCK 2 SECTION 80 13 TABBARA CRES. CRACE ACT

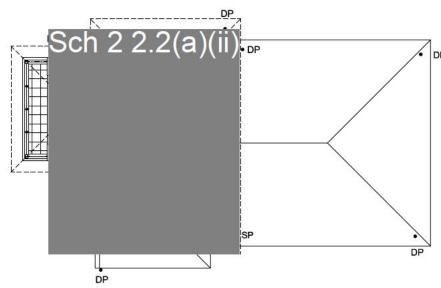
HOUSETYPE: BEDARRA 31

FACADE: MAJESTIC SPECIFICATION: LUXE+ GOLD INCLUSIONS

DRAWING TITLE: INDICATIVE LANDSCAPE

DATE DRAWN: DRAWN 8Y: CHECKED: 28.02.13 COUNCIL AREA: SCALE: 1:200@A3 **ACTPLA** JOB No: DRWG No.: ISSUE: 02






ROOF & FIRST FLOOR LAYOUT SCALE 1:200/A3

SEWERAGE LAYOUT NOTES

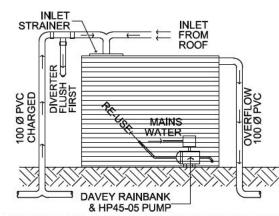- 1. EXISTING SEWER LINES & TIES TO BE LOCATED ON SITE PRIOR TO CONSTRUCTION.
- 2. ALL WORKS TO BE COMPLETED IN ACCORDANCE WITH AS3500.2.3 (2003)
- 3, ALL WORKS ARE TO BE CONDUCTED IN ACCORDANCE WITH THE CANBERRA SEWERAGE REGULATIONS.
- 4, THE INSPECTION SHAFT AT THE PROPERTY BOUNDARY TO BE IN ACCORDANCE WITH PLUMBING NOTE No.3,



RAINWATER TANK CONFIGURATION

SANITARY FIXTURES

- (1) TOILETS 3 (2) BATHS 1 (3) BASINS 3
- (4) SHOWERS 2 (5) KITCHEN SINKS 1
- (5) KITCHEN SINKS (6) LAUNDRY TROUGH

RAINWATER TANK AS SHOWN

ON PLAN

PROVIDE A RAINWATER TANK
4000L IN CAPACITY TO SUIT
ALL WSUD REQUIREMENTS.
TANK TO BE CONNECTED TO
TOILETS, LAUNDRY
& IRRIGATION FOR RE-USE.

ENSURE ALL CONNECTIONS WITHIN CHARGED SYSTEM ARE SOLVENT WELDED

ALL DOWNPIPES ARE TO BE ENTIRELY PVC. PIPES ARE TO BE SEALED UPTO U/S OF ROOF GUTTERS

ROOF GUTTERS I.L. 599,71 TANK INLET I.L. 598.80 HEAD PRESSURE - 910mm

STORMWATER & SEWERAGE LAYOUT - INTERIM PLAN SCALE 1:200/A3

STORMWATER LAYOUT NOTES

- PITS DEEPER THAN 600mm TO BE 600 X 900 W, ELSE 375 SQ U.N.O.
- 2) ALL PIPES TO HAVE 1% MIN, GRADE U.N.O.
- 3) ALL DOWNPIPES TO BE 100 X 50 BOX or 90 Ø.
- 4) PIPES TO BE U.P.V.C. OR STORMWATER PIPE TO A.S.1254.
 5) PITS TO BE STANDARD PRECAST CONCRETE PITS OR BRICK
- RENDERED WITH CONCRETE HEAVY DUTY GRATES SIZED

 AS PITS PER PLAN.
- 6) NO SEWER VENTS, GULLY PITS OR SIMILAR TO BE LOCATED— BELOW THE MAXIMUM WATER SURFACE LEVEL IN DETENTION— BASINS.—
- PERSONS UTILISING THIS PLAN FOR ANY PURPOSES SHALL VERIFY THE DATUM & RESPECTIVE LEVELS PRIOR TO

- COMMENCING ANY WORKS & NOTIFY THE ENGINEER OF ANY DISCREPANCIES.
- 8) DRIVEWAY LEVELS PROVIDED FOR DRAINAGE DESIGN PURPOSES ONLY, LEVELS MAY BE ADJUSTED TO SUIT FINAL HOUSE CUT/FILL CONDITIONS BUT NEED TO MAINTAIN INTENT OF DRAINAGE SYSTEM. ENGINEER TO BE CONSULTED PRIOR TO CONSTRUCTION TO ENSURE INTENT MAINTAINED.
- END OF EXISTING DRAINAGE LINE TO BE EXPOSED & LEVELS CONFIRMED BY BUILDER PRIOR TO COMMENCEMENT OF WORKS.
- BUILDERS TO ENSURE SERVICES CONNECTIONS TO HOUSE DO NOT CONFLICT WITH DRAINAGE DESIGN REQUIREMENTS.

 11) ALL WORKS TO BE CONSTRUCTED TO GOOD BUILDING PRACTICE & MATERIALS TO MEET ACCEPTED SPECIFICATIONS.

	LEGEND		
P1	PIT LABEL	G.F.L.	GARAGE FLOOR LEVEL
	SUMP PIT	● 0.00	EXISTING REDUCED LEVEL
輕	300x300 FLOOR GULLY	• R.L 157.00	PROPOSED REDUCED LEVEL
	100/150 Ø GARDEN GULLY	■ DP	DOWNPIPE
→	STORMWATER PIPE	⇒ SP	SPITTER/SPREADER
	AERIAL PIPE	©	CLEANING EYE
S.L.	SURFACE LEVEL	+++++++++++	SEDIMENT FENCE
I.L.	INVERT LEVEL	— 40 — 40 —	AG LINE
F.F.L.	FINISHED FLOOR LEVEL	SS	SEWERAGE PIPLINE 100 Ø PVC LAID AT 1.65% MIN


alwdesign


CIVIL ENGINEERING CONSULTANTS I

P: 02 8819 2565 F: 02 8819 2597 E: admln@alwdeslgn.com.au M: 0413 763 432 69A COWELLS LANE, ERMINGTON NSW 2115

PROJECT: PROPOSED RESIDENTIAL DWELLING AT BLOCK 2 / SECTION 80; 13 TABBARA CRESCENT, CRACE ACT DRAWING: STORMWATER & SEWERAGE LAYOUT - INTERIM PLAN

DESIGNED	DRAWN	CHECKED:	ANDREW L WAHBE - BE (CIVIL) MIE	ALIET DEMC
A.W	M ₋ W	DRAWINGS NOT TO	BE USED FOR CONSTRUCTION UNLESS SIGNED BY DESIGN	
Α	ISSUE	D FOR REGIST	RATION	20/03/13
ISSUE	REVISION	ON DESCRIPTION		APPR. DATE

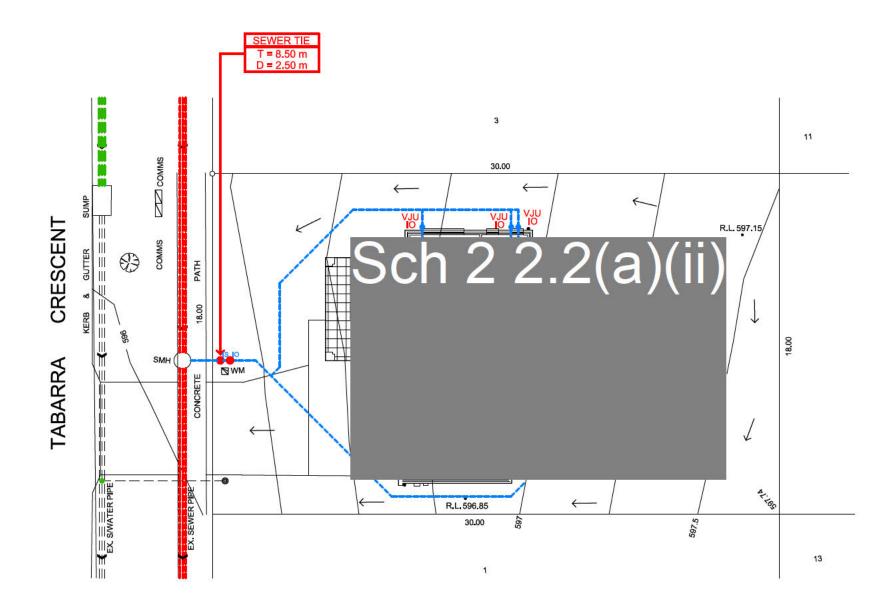

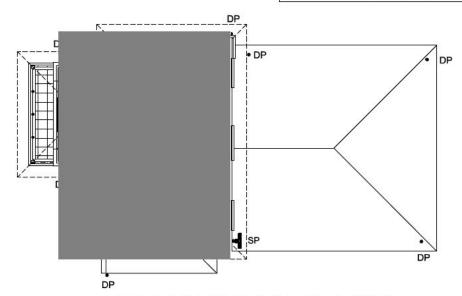

ROOF & FIRST FLOOR LAYOUT

SEWERAGE LAYOUT NOTES

BE IN ACCORDANCE WITH PLUMBING NOTE No.3.

- 1. EXISTING SEWER LINES & TIES TO BE LOCATED ON SITE PRIOR TO CONSTRUCTION.
- 2. ALL WORKS TO BE COMPLETED IN ACCORDANCE WITH AS3500.2.3 (2003)
- 3. ALL WORKS ARE TO BE CONDUCTED IN ACCORDANCE WITH THE CANBERRA SEWERAGE REGULATIONS.

 4. THE INSPECTION SHAFT AT THE PROPERTY BOUNDARY TO

SANITARY FIXTURES

(1) TOILETS 3 (2) BATHS (3) BASINS (4) SHOWERS (5) KITCHEN SINKS (6) LAUNDRY TROUGH



ORG - OVERFLOW RELIEF GULLY VJU - VERTICAL JUMP UP

VP - VENT PIPE

SVP - SOIL VENT PIPE

IO - INSPECTION OPENING

SEWERAGE LAYOUT - WORK AS EXECUTED SCALE 1:200/A3

STORMWATER LAYOUT NOTES 1) PITS DEEPER THAN 600mm TO BE 600 X 900 W, ELSE

- 375 SQ U.N.O.
- 2) ALL PIPES TO HAVE 1% MIN. GRADE U.N.O.
- 3) ALL DOWNPIPES TO BE 100 X 50 BOX or 90 Ø. 4) PIPES TO BE U.P.V.C. OR STORMWATER PIPE TO A.S.1254.
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- 6) NO SEWER VENTS, GULLY PITS OR SIMILAR TO BE LOCATED BELOW THE MAXIMUM WATER SURFACE LEVEL IN DETENTION
- 7) PERSONS UTILISING THIS PLAN FOR ANY PURPOSES SHALL VERIFY THE DATUM & RESPECTIVE LEVELS PRIOR TO

- COMMENCING ANY WORKS & NOTIFY THE ENGINEER OF ANY DISCREPANCIES.
- 8) DRIVEWAY LEVELS PROVIDED FOR DRAINAGE DESIGN PURPOSES ONLY, LEVELS MAY BE ADJUSTED TO SUIT FINAL HOUSE CUT/FILL CONDITIONS BUT NEED TO MAINTAIN INTENT OF DRAINAGE SYSTEM, ENGINEER TO BE CONSULTED PRIOR TO CONSTRUCTION TO ENSURE INTENT MAINTAINED.
- 9) END OF EXISTING DRAINAGE LINE TO BE EXPOSED & LEVELS CONFIRMED BY BUILDER PRIOR TO COMMENCEMENT
- 10) BUILDERS TO ENSURE SERVICES CONNECTIONS TO HOUSE DO NOT CONFLICT WITH DRAINAGE DESIGN REQUIREMENTS. 11) ALL WORKS TO BE CONSTRUCTED TO GOOD BUILDING PRACTICE & MATERIALS TO MEET ACCEPTED SPECIFICATIONS.

	LEGEND		
P1	PIT LABEL	G.F.L.	GARAGE FLOOR LEVEL
	SUMP PIT	* 0.00	EXISTING REDUCED LEVEL
輕	300x300 FLOOR GULLY	• R.L 157.00	PROPOSED REDUCED LEVEL
•	100/150 Ø GARDEN GULLY	■ DP	DOWNPIPE
-> -	STORMWATER PIPE	⇒SP	SPITTER/SPREADER
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S.L.	SURFACE LEVEL	+++++++++++++++++++++++++++++++++++++++	SEDIMENT FENCE
I.L.	INVERT LEVEL	— AG — AG —	AG LINE
F.F.L.	FINISHED FLOOR LEVEL	SS	SEWERAGE PIPLINE 100 Ø PVC LAID AT 1.65% MIN

<u>alwdesign</u>


CIVIL ENGINEERING CONSULTANTS |

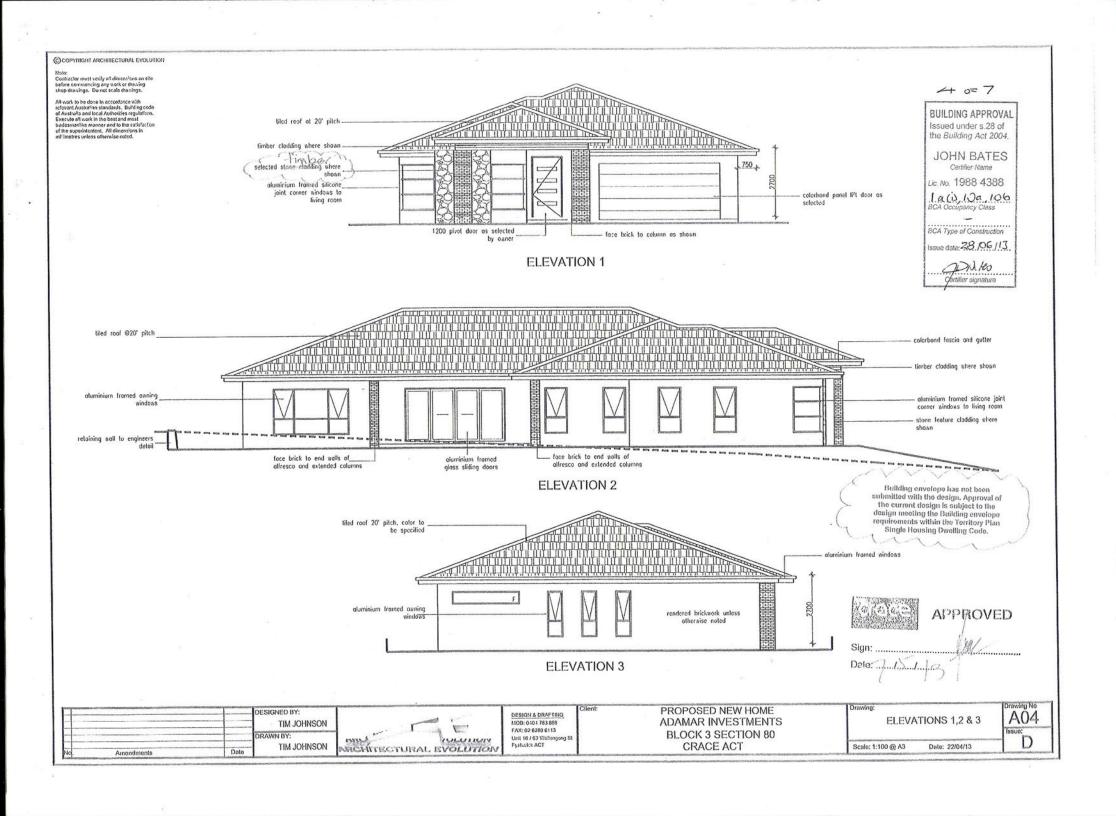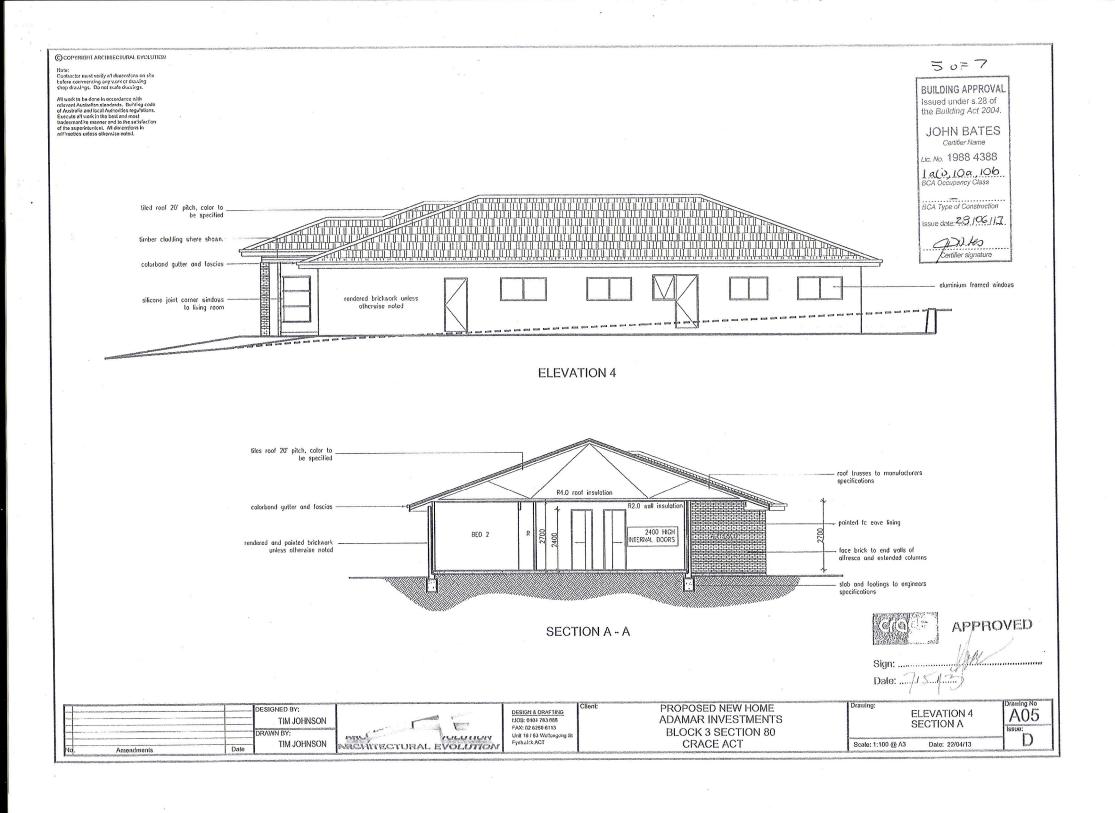
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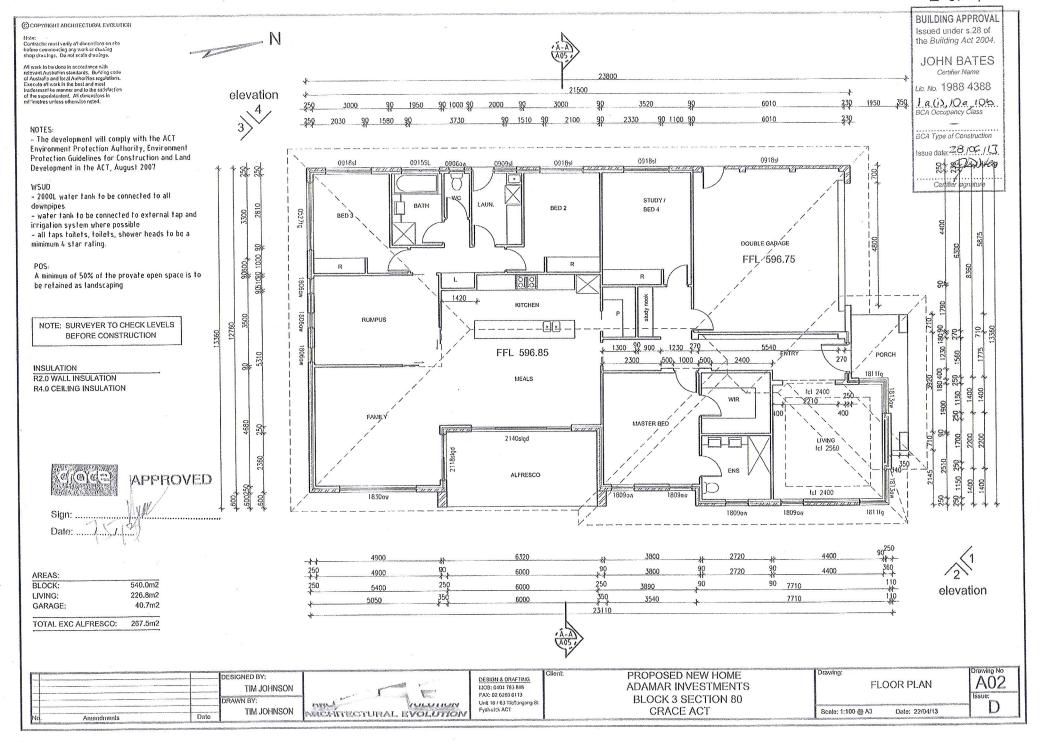
P: 02 8819 2565 F: 02 8819 2597 E: admln@alwdeslgn.com.au 69A COWELLS LANE, ERMINGTON NSW 2115


PROJECT: PROPOSED RESIDENTIAL DWELLING AT BLOCK 2 / SECTION 80: 13 TABBARA CRESCENT, CRACE ACT DRAWING: WORK AS EXECUTED

DESIGNED	DRAWN	CHECKED:	ANDREW L WAHBE - BE (CIVIL) MIEAUST PENG
A.W	M ₋ W	DRAWINGS NOT TO	BE USED FOR CONSTRUCTION UNLESS SIGNED BY DESIGNING ENGINEER
В	ISSUE	D FOR WORK	AS EXECUTED 22/07/13
Α	ISSUE	D FOR REGIST	RATION 20/03/13
ISSUE	REVISIO	ON DESCRIPTION	APPR. DATE







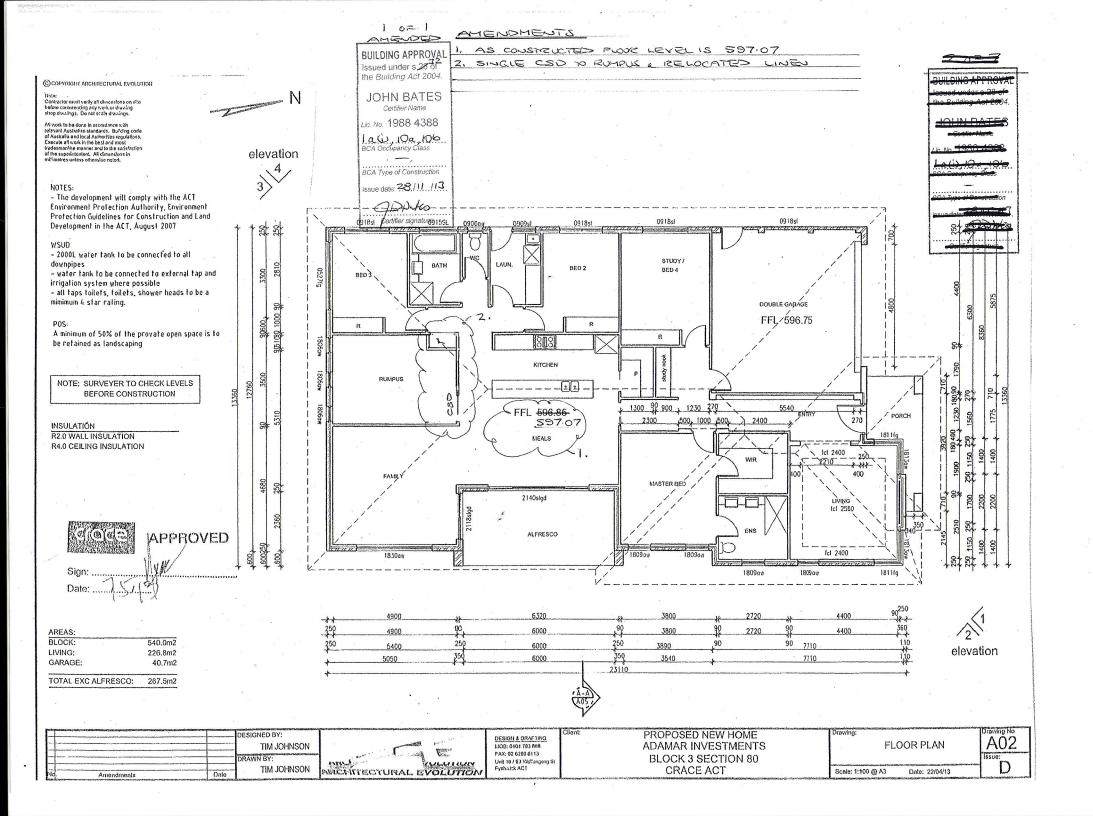


Jan van der Veen c.Eng M.I. Struct.E. M.I.E. (Aust) CONSULTING STRUCTURAL ENGINEER

Unit 11, Birubi Chambers, Hawker Place, Hawker

P.O. Box 4038, Hawker, Canberra, A.C.T. 2614

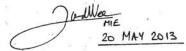Telephone: (02) 6255 1188 Facsimile: (02) 6255 1212 Mobile: 0428 626 212 Email: jan@jvengineer.com.au



ENGINEER'S DESIGN

Client: ADA MAR INVESTMENTS

Project: House

Block No: 3
Section No: 80

Suburb: CRACE. ACT.

BUILDING APPROVAL Issued under s.28 of the Building Act 2004. JOHN BATES Certifier Name Lic. No. 1988 4388 I. ALD JOA, JOB, BCA Occupency Class BCA Type of Construction Issue date: 28 JOF, J3


FOOTING & SLAB PLAN


Scale 1:100

See arch plan for setting out dimensions

TYPE M. SITE CLASSIFICATION - FILL SITE. Site classification provided by OTHERS.

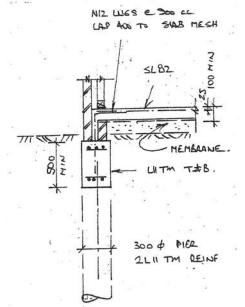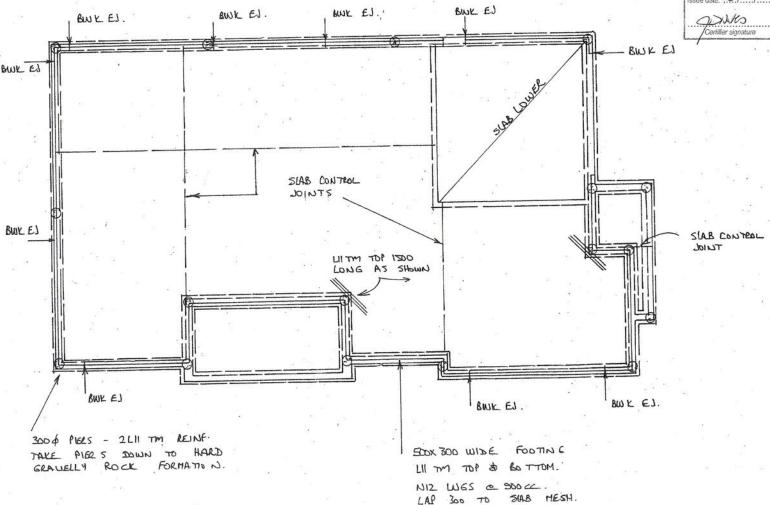- · All footings 20MPA concrete strength.
- · Piers to firm gravelly soil formation.
- Slabs 100 thick on PVC membrane on machine compacted granular fill. SL82 mesh. Use 25 MPa concrete.
- Where fill over 450mm, 125mm slab. SL72
 Top and Bottom 300 dia piers at + 1500cc.





Jan van der Veen C.Eng M.I.Struct.E. M.I.E. (Aust) CONSULTING STRUCTURAL ENGINEER

Unit 11, Birubi Chambers, Hawker Place, Hawker

P.O. Box 4038, Hawker, Canberra, A.C.T. 2614

Telephone: (02) 6255 1188 Facsimile: (02) 6255 1212 Mobile: 0428 626 212 Email: jan@jvengineer.com.au 21 MAY 2013.

ENGINEER'S DESIGN

Client: ADAMAR INVESTMENTS

Project: HOUSE.

Block No: 3
Section No: 80

Suburb: CRACE. ACT.

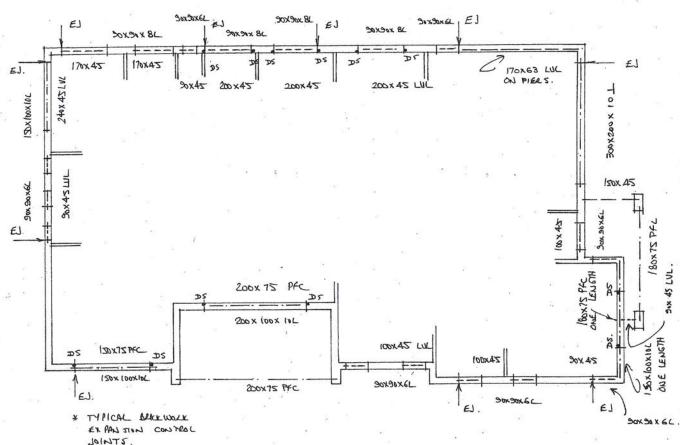
BUILDING APPROVAL
Issued under s.28 of
the Building Act 2004.

JOHN BATES
Certifier Name.
Lic. No. 1988 4388
I. A.C. JOB.
BCA Occupancy Class
BCA Type of Construction
Issue date: 28./X6.//3.

DAMAS
Pertifier signsture

NOTA TON.

- . BUGEL SCIEW FIX BATTENS TO TRUSSES.
- TRIPL. GRIP FIX TRUSSES.
- BOLT PLATES TO STEEL BEAMS
- · WELD STEEL WALK CONNECTIONS
- . DS: DOUBLE STUDS.
- · ALL WOLK TO COMPLY WITH BCA



ROOF PLAN.


Scale 1:100

See arch plan for setting out dimensions

OCOPYRIGHT ARCHITECTURAL EVOLUTION

Roser Contractor must verify all dimensions on site before commencing any work or drawing shop drawings. On not scale drawings.

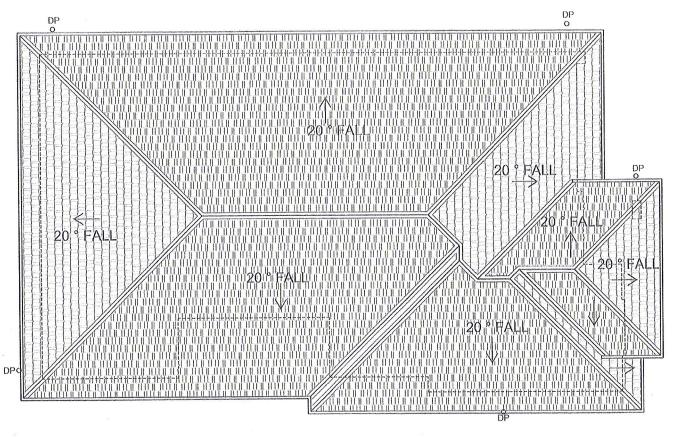All work to be done in accordance with relevant Austratan standards. Burding code of Austrata and local Authorities regulations. Execute all work in the best and most tradesmanike manner and to the satisfaction of the superintentent. All dimensions in millimetres unless otherwise notice.



3 of 7

BUILDING APPROVAL

Issued under s.28 of the Building Act 2004.

JOHN BATES

Certifier Name

Lic. No. 1988 4388

Law, 10a, 10b BCA Occupancy Class

BCA Type of Construction

Issue date: 28 PC //3

200 des

Gertifier signature

750MM EAVES



APPROVED

Sign:,

Date: 7/5/1/2

.

DESIGN & DRAFTING

Unit 16 / 63 Wollengong S

MOB: 0404 783 888

FAX: 02 6280 6113

Fyshalck ACT

PROPOSED NEW HOME ADAMAR INVESTMENTS BLOCK 3 SECTION 80 CRACE ACT

ROOF PLAN

A03
||ssue:

Scale: 1:100 @ A3

Date: 22/04/13

Nd. Amendments

TIM JOHNSON

DRAWN BY:

TIM JOHNSON

DESIGNED BY:

ARCHITECTURAL EVOLUTION



Contractor must verify all dimensions on site before commencing any work or drawing shop drawings. Do not scale drawings.

All work to be done in accordance with relevant Australian standards. Building code of Australia and local Authorities regulations. Execute all work in the best and most tradesmanks manner and to the satisfaction. of the superintentent. All dimensions in millimetres unless otherwise noted.

Percentage Reduction =	58%
Indoor information	
Number of bedrooms in the house	1 4
What is the water rating of the shower head?	45tp [¥]
What is the water rating of the clothes washing machine?	45tar ▼
What is the water rating of the dishwasher?	[45th [v],
What is the water rating of the to-let?	45tN 🕶
Site Information Site area (m²)?	540
Roof area (including house and garage or carport) (m²)?	310
Rain water tank informat	ion
Is there going to be a water tank installed?	res 🔻
What is the size of the tank (L)?	2000 40
What is the approx, roof area flowing into the tank (m²)?	155
the state of the s	Janea Tolerandianic 13

A minimum of 50% of the provate open space is to be retained as landscaping

NOTE: SURVEYER TO CHECK LEVELS BEFORE CONSTRUCTION

INSULATION

R2.0 WALL INSULATION **R4.0 CEILING INSULATION**

ADEAS

BLOCK:	540,0m2
LIVING:	226,8m2
GARAGE:	40.7m2

TOTAL EXC ALFRESCO: 267.5m2 PLOT RATTO - 49.53

DESIGNED BY:

DRAWN BY:

GATE

DESIGN & DRAFTING TIM JOHNSON MOR: 0404 783 688 FAX: 02 6280 6113 Unit 16 / 63 Wolfengong St VELLE LACITY TIM JOHNSON ARCHITECTURAL EVOLUTION

clothes line

TABBARA CR

596.5

GARAGE

FFL 596.75

FFL 596.85

GATE

0718

OFLE

-2000t, tank

PROPOSED NEW HOME ADAMAR INVESTMENTS BLOCK 3 SECTION 80 CRACE ACT

4000 LINCE TANK RED D

1 0= 7

BUILDING APPROVAL Issued under s.28 of the Building Act 2004.

JOHN BATES Certifier Name

Lic. No. 1988 4388

I a () 10a 10b BCA Occupancy Class

BCA Type of Construction

Issue date: 28, p6 /13

a Dutes Certifier signature Refer to the Hydraulic Service within the Standard Servicing Conditions of the Crace Pattern Book for the requirement to install a SW inspection riser or sump with trafficable cover within lease boundary to satisfy Crace WSUD requirements.

Refer to information sheet on Services and Verge Management within the Crace Pattern Book on verge protection measures during construction of your home.

The height of site cuts at the boundary is restricted to a max, 1 metre with boundary retaining walls also not exceeded to 1 metre.

Paling/Colorbond side fencing and treated pine retaining walls must not extend boyond fin bobind the front building line. Where there is a Zero subtack garage the fencing must terminate at the back of the garage, fencing is not permitted adjacent to Zero setback garages.

Fences and Gates addressing street frontage are to be 50% transparent as per the Crace Pattern Book.

Front retaining wall to be stone, masonry or concrete blocks. Timber sleepers and cement look-a-like sleepers are not permitted beyond the building line.



APPROVED

SITE PLAN

A01

Scale: 1:200 @ A3 Date: 22/04/13 D

What will be the use for the water in the tank? NOTES: - The development will comply with the ACT Environment Protection Authority, Environment Protection Guidelines for Construction and Land Development in the ACT, August 2007 - 2000L water tank to be connected to all downpipes - water tank to be connected to external tap and irrigation system where possible - all taps toilets, toilets, shower heads to be a mimimum 4 star rating.

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APPROVED

Skgm: 4/2

BUILDING APPROVAL
Issued under 5.28 of
the Building Act 2004.

JOHN BATES
Comme
Lie No. 1988 4388
I. a. (1) 10a, 10b,
BCA Oca parcy Class

BCA Type of Construction
Issue date: Int. DHII3.

ADUM
Certifier signature

VERGE HANAGEMENT NOTES

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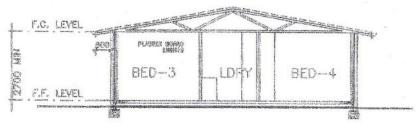
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SLAB AND FOOTINGS TO ENGINEERS SPECIFICATION AND AS 2870.1

SECTION

NOTES:

*1800 POWER HIGH TIMBER PALING FENCING TO HALF SIDE AND REAR BOUNDARIES

*ALL LEVELS, SITE CUTS, GROUND LEMELS, FPL'S TO BE CONFIRMED ON SITE PRIOR TO THE COMMENCEMENT OF ANY WORKS. (IRCL. DRIVEWAY LEVELS)

*ANY DISOREPANCIES TO BE DIRECTED TO BUILDER IMMEDIATELY.

*INDICATIVE CLOTHES DITTING AREA
TO BE CONFIRMED BY CLEENT.

*STORMWATER DETAILS TO BE CONFIDMED WHEN THE INFORMATION AVAIL.

*INCLUSIONS LIST TO TAKE PRECEDENCE OVER DRAWINGS.

GENERAL NOTES

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A) ACT COMMINDER

B) BLUCKE CLOSE OF AUCUVALA AND THE ACT
APPENDIX

C) ACT ELECTRICITY AND WHITE B) ASSESS THINKER FRANKING CODE AND AS FUNDHER SPECTED,

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SURVEYOR TO CONTINUE EASEMENT LOCATIONS PRICE TO CONSISTINGUISH OF ANY WORKS.

DESIGN ILLUSTRATED SUBJECT TO COPYRIGHT, ALL RIGHTS RESERVED

AZIS BESPON & EMAFTING ACCEPTS NO RESPONSENTLY OR LINEALTY FOR ANY STRUCTUREAL COMPONENTS. NOTATION OF ACCURACY OF BOCKEPTATION HEREIG. CLERT / BURLERS ACCEPTS PLANS & RESPONSIBILITIES GAGE PLANS ARE SUBMITTED FOR APPROVALS.



Axis Design and Drafting

PROPOSED NEW WORK

ELOCK: 4 SECTION: 80 DMSKON: CRACE

Sch 2 2.2(a)(ii)

DESTRUCTIONS

WORKING DRAWINGS

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ZELJKO	
B/80	9942
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BUILDING APPROVAL Issued under s.28 of the Building Act 2004.

JUHN BATES (... Lic. No 19884388

1.a.(1),100,106

BCA Type of Construction

Issue date: 14 P4/13

apples

Certifier signature

Meter box to be installed to Actew AGL Service and Installation Rules

Driveway to abut footpath. Footpath to take precedence over driveway.

BUSHFIRE MITIGATION MEASURES - IF REQUIRED BUSHFIR ATTACK LEVEL 12.5 (BAL-12.5) IN ACCORDANCE WITH AUSTRALIAN STANDARD 3959-2009

> Stabilised access point in accordance with the ACT Environment Protection Authority, Environment Protection Guidelines for Conctruction and Land Development in the ACT, August 2007

WSUD needs to comply with the following -Blocks 300m2-500m2

- 2000 litre water tank

- connected to 50% or 75m2 of roof area

- tank connected to at least toilet, laundary and garden tap Blocks 500m2-800m2

- 4000 litre water tank

- connected to 50% of 100m2 of roof area

- tank connected to at least toilet, laundary and garden tap

Blocks greater than 800m2

- 10000 litre water tank - connected to 50% of 125m2 of roof area

- tank connected to at least toilet, laundary and garden tap

In accordance with attached Water Reduction Calculation Spreadsheet.

Driveway Requirements Driveway Requirements

1.2m horizontally clear of stormwater sumps and services

1.5m horizontally clear of transformers, bus stops, light poles

1.5m horizontally clear of transformers, bus stops, light poles

1.5m horizontally clear of transformers, bus stops, light poles

2.5m up thill grade of less that 17%, downhill grade of less than 12%,

2.5m at a right angle to the kerb line with a maximum 10% deviation

2.5m and a maximum of 5.5m which, and minimum of 5 m which at the

2.5m at a right angle to the kerb line who the protection of a maximum

2.5m at a right angle to the whole line of mature traces and a minimum of 2.5m

3.5m at a right angle to the line of mature traces and a minimum of 2.5m

3.5m at a right angle to the line of mature traces and a minimum of 2.5m

3.5m at a right angle to the line of mature traces and a minimum of 2.5m

3.5m at a right angle to the line of mature traces and a minimum of 2.5m

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f) outside of the drip line of mature trees, and a minimum of 3m clear of small and new street trees

g) compliant with AS28901

BCA Requirement 3.12.5.5 - Artificial lighting must not exceed 5W/m2

CONSTRUCTION FOR BUSHFIRE ATTACK LEVEL 12.5 (BAL-12.5) A building assessed in section 2 as being BAL-12.5 shall comply with Australia Standards Section 3 and Clauses 5.2 to 5.8 Note: there are a number od Standards that specify regulrements for construction; however, where this Standard does not provide construction regulrements for a particular element, the other Standards apply

R87 - A minimum of 50% of the Private Open Space is to be retained as planting area

Erosion and Sediment Control Plan/Site Plan

- Maintain as many grassed areas as possible particularly on the verges to trap soll before it reaches the roadway and srormwater system, Fence off undisturbed areas.

- Use only one exit/entry to the site, Build a stabilised access point by using road base, 50mm aggregate, recycled concrete or similar.

Assign a designated parking area

- Linit access to the site during and immdelately after wet weather

- Keep stockpiles withing the site area and away from the stormwater system

- Install onsite waste collection

- Regularly remove any sediment from roads adjacent to you site. Do not wash into the stormwater system

- Install a sediment control barrier of geotextile fabric on the low side/s of the block

- Designate a brick cutting and washing area away from stormwater drains. Ensure the area is large enough to contain all excess water, redidues and

- Regularly check and maintain pollution controls throughout contruction

GENERAL NOTES

CARRY OUT ALL WORK IN COMPLIANCE WITH THE RELEVANT SAA CODES OF PRACTICE IN THE BEST TRADESMAN-LIKE MANNER TO THE APPROVAL OF THE SUPERINTENDENT AND AUTHORITIES HAVING JURISDIC-TION OVER THE WORKS INCLUDING BUT NOT RES-TRICTED TO:

A) ACT GOVERNMENT B) BUILDING CODE OF BUILDING CODE OF AUSTRALIA AND THE ACT APPENDIX

ACT ELECTRICITY AND WATER

AS1684 TIMBER FRAMING CODE AND AS FURTHER SPECIFIED.

ALL DIMENSIONS MUST BE VERIFIED ON SITE BEFORE COMMENCING ANY WORK OR MAKING ANY SHOP DRAWINGS

USE FIGURED DIMENSIONS ONLY, DO NOT SCALE OFF THE DRAWING

SURVEYOR TO CONFIRM EASEMENT LOCATIONS PRIOR TO COMMENCEMENT OF ANY WORKS.

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Axis Design and Drafting PH. 62429550 FAX 62429661 UNIT 1/38 ESSINGTON ST MITCHELL ACT

PROJECT

PROPOSED NEW WORK

BLOCK: SECTION: 80

DIVISION: CRACE

FOR

Sch 2 2.2(a)(ii)

WORKING DRAWINGS


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DRAWING No.

ISSUE

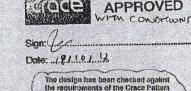SHEET OF

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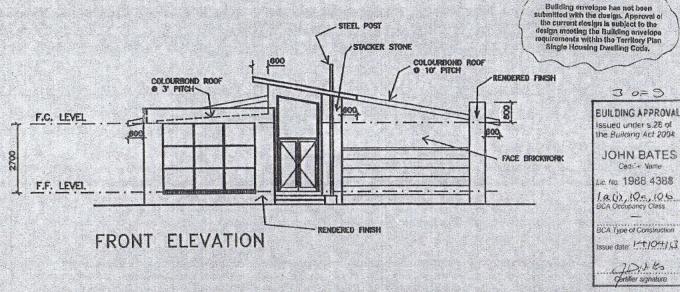


The design has been checked against the requirements of the Crace Pattern Book. It is the builder's responsibility to ensure that all regulæments and conditions are met in relation to the Territory Plan Single Housing Dwelling Code. The developer's approval is not an endorsoment of the design meeting all applicable and relevant Yerritory Plas

BACK ELEVATION

F.C. LEVEL

F.F. LEVEL



GENERAL NOTES

CARRY OUT AIL WORK IN COMPLIANCE WITH THE RELEWANT SAA CODES OF PRACTICE IN THE BEST TRUBESTAIN-LIKE MANNER TO THE APPROVAL OF THE SUPERINDENDENT AND AUTHORITIES HAVING JURISDIC-TION OVER THE BOOKS INCLUDING BUT NOT RES-TRICTED TO:

BUILDING CODE OF AUSTRALIA AND THE ACT

C) ACT ELECTRICITY AND WATER D) AS 1684 TRUBER FRANKING CODE AND AS FURTHER SPECIFIED.

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Axis Design and Drafting
PH. 62429550 FAX 62429661
UNIT 1/36 ESSINGION ST METCHELL ACT

PROPOSED NEW WORK

BLOCK: SECTION: DIVISION: 80 CRACE

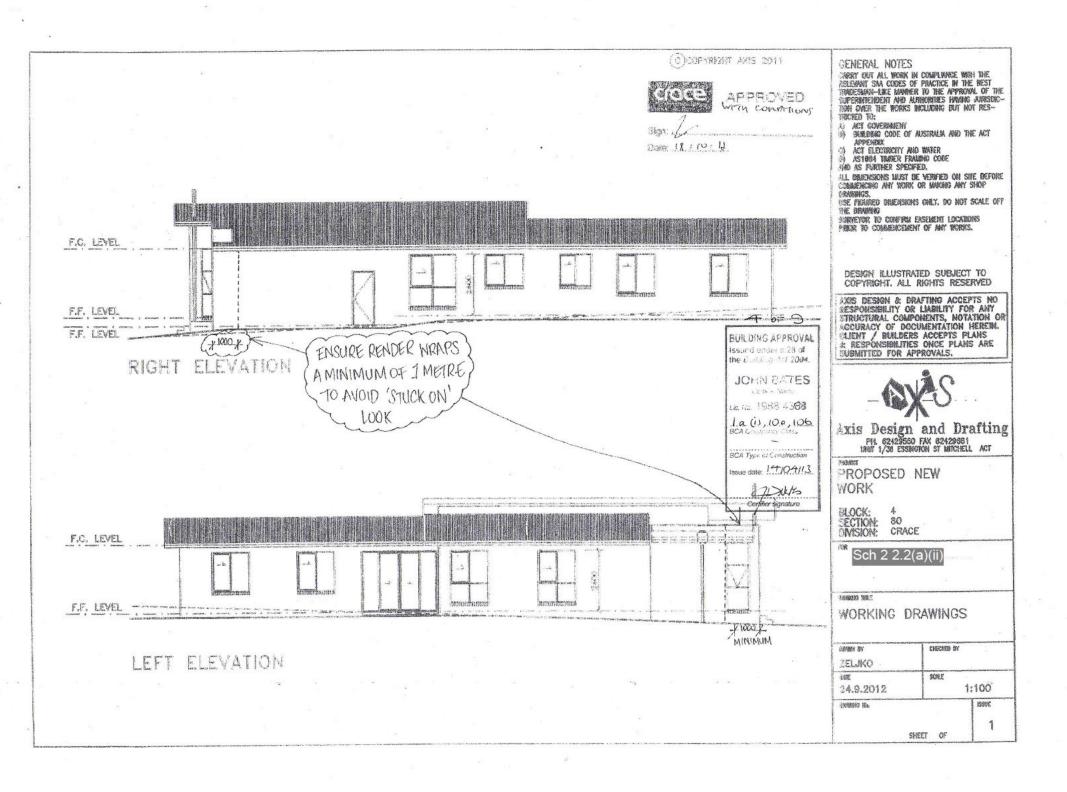
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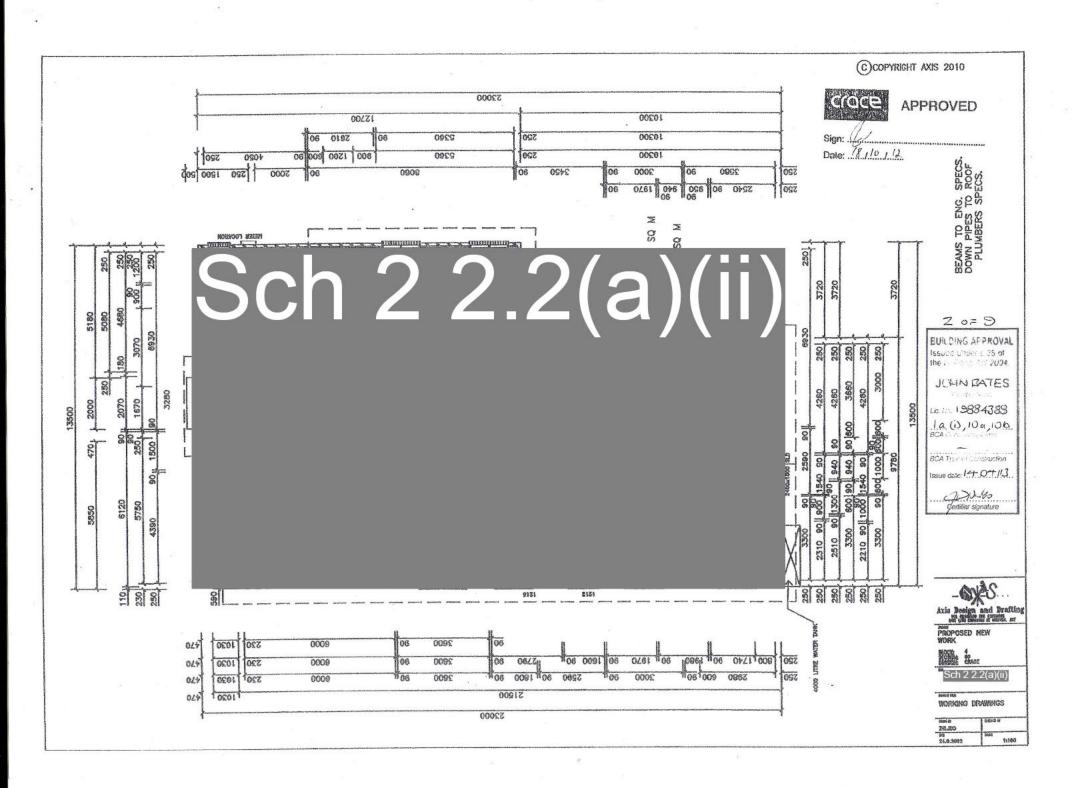
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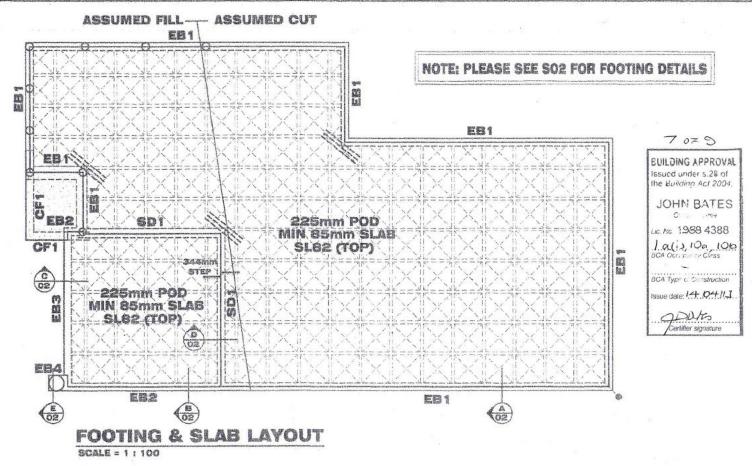
WORKING DRAWINGS

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WAFFLE SLAB PLAN

"M" CLASS

LEGEND

N

1 STANDARD 1090X1090 POD

3N12 OR 3L11TM, 2000mm LONG, TIED TO UNDERSIDE OF SLAB MESH

0

300mm DIA CONCRETE PIERS TO MIN SOOmm INTO NATURAL GROUND

0

500mm DIA CONCRETE PIERS TO MIN 600mm INTO NATURAL GROUND

DENOTES STARTING POINT FOR POD LAYOUT. NOTE

ALL WORK CARRIED OUT, AND MATERIALS USED IN RELATION TO THIS WAFFLE SLAB DESIGN IS TO BE IN ACCORDANCE WITH CURRENT AUSTRALIAN STANDARDS.

MITHE BUILDING ENVELOPE, BEARING STRATE TO BE UNIFORM THROUGHOUT BUILDING PLATFORM AND IS TO BE ROLLED AND PREPARED IN ACCORDANCE WITH A.S 3790.

ALL FOOTINGS ARE TO BE FOUNDED ON NATURAL GROUND AND ALL BRICK WORK & DRAINAGE IS TO BE ARTICULATED TO COMPLY WITH THE CURRENT B.C.A.

BURLDER IS TO ISSUE CSIRO REPORT TO HORE OWNER GUIDE TO HOMEOWNERS ON FOUNDATION MAINTENANCE AND FOOTING PERFORMANCE. NOTE: THE LONG TERM SITE MANAGEMENT & MAINTENANCE OF THIS PROPERTY MUST BE IN ACCORDENCE WITH APPENDIX B OF AS2670-2011. THIS MAINTENANCE IS THE RESPONSIBILITY OF THE HOME OWNER (REFER TO CSRID BROCHURE • FOUNDATION MAINTENANCE & FOOTING PERFORMANCE: A HOMEOWNER'S GUIDE)

NOTE: BUILDER TO CONFIRM SEWER DOES NOT AFFECT DWELLING BEFORE COMMENCING WORK ONSITE, CONTACT THIS OFFICE IF OTHERWISE

NOTE: BUILDER TO CONFIRM EASEMENT DOES NOT AFFECT DWELLING BEFORE COMMENCING WORK ONSITE. CONTACT THIS OFFICE IF OTHERWISE

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CONSULTING ENGINEERS

email: pdragh@gmail.com PO BOX 336 HALL ACT 26 LB Ph: 0438 625 440

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Sch 2 2.2(a)(ii


PROJECT

PROPOSED NEW WORK BLOCK 4 SECTION 80 CRACE

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FOOTING & SLAB LAYOUT

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BEARING ONTO NATURAL STRATA OR PIERS(SEE NOTES) STANDARD EDGE BEAM EB2

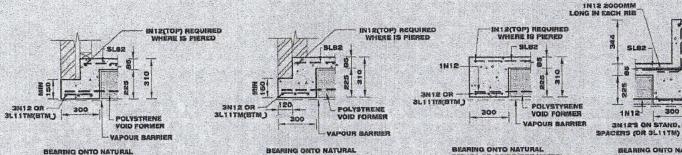SECTION B SCALE = 1:20

STRATA OR PIERS(SEE NOTES) STANDARD EDGE **BEAM EB3** SECTION ©

SCALE = 1:20

REARING ONTO NATURAL STRATA OR PIERS(SEE NOTES) 344mm STEPDOWN **BEAM SD1**

300

SLOZ

SECTION O SCALE = 1:20

IN 12(TOP) REQUIRED WHERE IS PIERED 1 000mm MIN 2N12 BARS @ 400cts max. (300mm LONG LEGS)

STRATA OR PIERS(SEE NOTES)

STANDARD EDGE

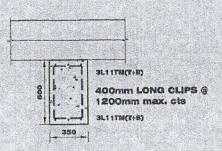
BEAM EB1

SCALE = 1:20


SECTION

BEARING ONTO NATURAL STRATA OR PIERS(SEE NOTES)

TYPICAL CANTILEVED FOOTING CF1 SCALE = 1120



SECTION F SCALE = 1:20

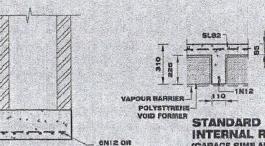

BEAM EB4 SLITTM(STM_) SECTIO SCALE = 1:20

INTERNAL RIB (GARAGE SIMILAR) SCALE : 1:20 8 0= 5

IN 12(TOP) REQUIRED WHERE IS PIERED

POLYSTRENE

VAPOUR BARRIER

T BAR :

YOLD FORMER

N12 @ 600mm

WITH SOOmm LEGS

BUILDING APPROVAL issued under s.28 of the Building Act 2004. JOHN BATES C . TE Le No. 1999 4388 La(i) 10 a 106 BCA Occionacy Class BCA Type of Construction Issue date 14 104113 apple

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PIERRE DRAGH CONSULTING ENGINEERS

emall: pdragh@gmail.com PO BOX 338 HALL ACT 2618 Phi 0438 825 440

Sch 2 2.2(a)(ii

PROPOSED NEW WORK **BLOCK 4 SECTION 80** CRACE


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FOOTING DETAILS


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S02 OF 03

AS SHOWN @ A3



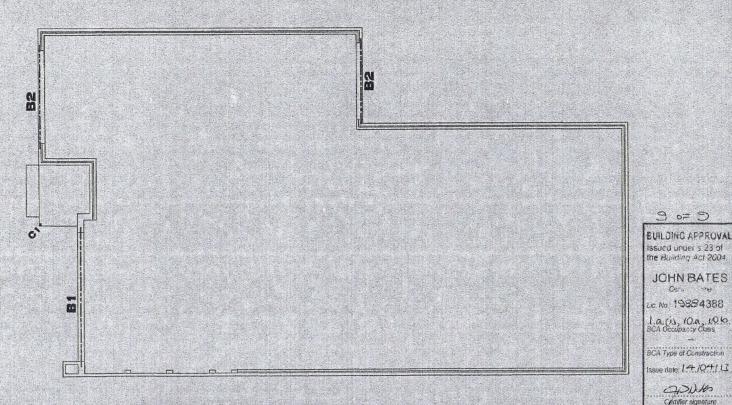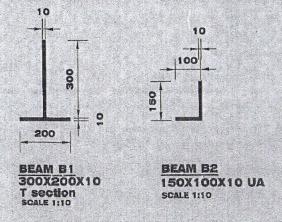ROOF BEAM LAYOUT SCALE = 1 : 100




MEMBER SCHEDULE		
MARK	SIZE	REMARKS
B1	300X200X10	T - SECTION
B2	150X100X10 UA	
C1	89X89X6 SHS	-

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MENDED AS COUSTRUCTED FLOOR LEVEL IS 597.22 BUILDING APPROVAL CONDUCTOR AND DOIS GENERAL NOTES Issued under s.28 of CARRY OUT ALL WORK IN COMPLIANCE WITH THE RELEMANT SAA CODES OF PRACTICE IN THE BEST the Building Act 2004. TABBARA CRES TRADESIAN-LIKE MANNER TO THE APPROAM OF THE SUPERINTENDENT AND AUTHORITIES FROM JURISDIC-TION OVER THE WORKS INCLUDING BUT NOT RES-JOHN BATES Certifier Name PROPERCY OF STREET PROPERTY OF STREET OF STREET, AND STREET, AND STREET, A LICENSE OF STREET, A LICENSE OF STREET, A THICKED NO: APPROVED ACT SCHERNMENT BANKBING CODE OF AUSTRALIA AND THE ACT Lic. No. 1988 4388 When connerious PEDENCIA lacis 10a, 10b. BCA Occupancy Class (1) ACT ELECTRICITY AND WATER (2) ASTRON TRIBLER FRANCING CODE (440) AS PARKHER SPECIFIED. 5000 CHRESTORS Dage: 18:10 111 ALL DIMENSIONS MUST BE VERWIED ON SHE BEFORE BCA Type of Construction COMMENCING AMY WORK OR MAKING ANY SHOP issue date: 19/03/14 HISE FIGURED PRIEMSKINS CHEY, DO NOT SCALE OFF Refer to information sheet on ODITES Services and Verge Management SURVEYOR TO CONFIRM EASEMENT LOCATIONS PRIOR TO COMMERCEMENT OF ARY WORKS. Certifier signature 7年的 within the Crace Pattern Book on 18.00 verge protection measures during construction of your home. 000 5000 0.80 Front retaining wall to be stone, DESIGN ILLUSTRATED SUBJECT TO masonry or concrete blocks. Timber COPYRIGHT. ALL RIGHTS RESERVED 10 sleepers and cement look-a-like AXIS DESIGN & BRAFFING ACCEPTS HO RESPONSIBILITY OR LIABRIETY FOR ARY STRUCTURAL COMPONENTS, NOTATION OR ACCURACY OF DOCUMENTATION HEREIN. sloopers are not permitted beyond 598.5 the bulkling line. The driveway over the verge is to CLIENT / BUILDERS ACCEPTS PLANS & RESPONSIBILITIES ONCE PLANS ARE match the footpath material and . finish as per the Crace Pattern SUBMITTED FOR APPROVALS. Book. 30.00 30.00 Axis Design and Drafting 300 3000 PH. 52429550 FAX 62429661 LINE 1/36 ESSINGTON ST INTCHELL ACT 6720 67% PROPOSED NEW WORK 597.0 -BLOCK: SECTION: DIVISION: 80.0.s. 80 CRACE a n BLOCK BEER - 540 mc GFA - 258.7 m2 Sch 2 2.2(a)(ii) PLOT RATIO - 47.9 % PHISHED FLOOR LEVELS 04RADE - FFL 598.972 36.972 97:144 LAME - FEL 597.144 2.WF (NUMBER) 1500 1500 MARKET MARKET WORKING DRAWINGS COMMENDEL SHE CAN DESCRIBE EMANCE MY CHECKED BY BUTTERED AT 4/504 北西,66 ZELJKO 18.00 HIT SCALE The height of saib cuts at the 24.9.2012 1:200 boundary is restricted to a max. f metre with boundary retaining walls BRANGER Dio. ISSME also not excessed to 1 metro. SHEET OF
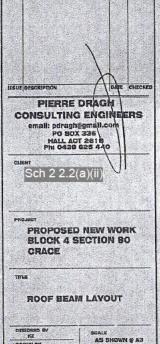
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