

Application Number: 2102030
 Sheet 7 of 6

BOUNDARY DIMENSIONS / BEARINGS & CONTOURS BASED ON DEVELOPER'S / ACT/MAPI DATA

CONDITIONALLY COMPLIES

This document has been assessed against legislation protecting Evoenergy's infrastructure and access to it.

The information contained in this application complies with Evoenergy's electricity network protection and access requirements subject to the conditions as listed on the Statement of Conditional Compliance.

Please note: Construction of unapproved works may result in action being taken to require the property owner to remove non-compliant structures and/or the property owner to fund rectification works on Evoenergy's electricity network.

Signed: [Redacted] Date: 03 May 2022
 Contact number: 6293 5770

PROPOSED RESIDENCE
 Sch 2.2(a)(ii)

WATER T: 0.5 (1m CLEARANCE ZONE AROUND WATER METER)

RETAINING WALL (MAX CUT/RW HT: 1.5m WITH IN 1.5m OF BOUNDARIES) AND STEPS TO SITE CONDITION

* MIN 4000L RAINWATER TANK, 50% OR 100m² OF ROOF AREA, WHICHEVER IS THE LESSER, IS CONNECTED TO THE TANK.

* TANK IS CONNECTED TO AT LEAST A TOILET, LAUNDRY COLD WATER AND ALL EXTERNAL TAPS, AS PER ACT TERRITORY PLAN.

* THE CONNECTION WILL REQUIRE A PUMP WHERE IT CANNOT BE ELEVATED SUFFICIENTLY TO GIVE ADEQUATE PRESSURE.

* DRIVEWAY TO COMPLY WITH GW/SD/DC.02 & FINISH TO COMPLY WITH ALL LEASE & DEVELOPMENT CONDITIONS AND RELEVANT LOCAL CODES

* IF LEVELS & CONTOURS ARE DIFFERENT ON SITE FROM THE DRAWING BUILDER TO PROVIDE CONTOUR PLAN & REPORT BACK TO THE DESIGNER TO ADJUST LEVELS ACCORDINGLY.



* NO PART OF CUT SHOULD ENCRACH OUT OF THE BOUNDARY OR EASEMENT

COURTYARD WALL TO BE CONSTRUCTED IN ACCORDANCE WITH TERRITORY PLAN AND LEASE AND DEVELOPMENT CONDITIONS

ALL CONCRETE FOOTINGS & SLABS TO BE IN ACCORDANCE WITH S.A.A CODE 2870.1

PROPOSED PLANTS TO CLIENTS SPEC

NOISE AFFECTED BLOCK - TO COMPLY WITH:
 * AS/NZS 2107:2000 - Acoustics - Recommended design sound levels and reverberation times for building interiors (the relevant satisfactory recommended interior design sound level)
 * AS/NZS 3671 - Acoustics - Road Traffic Noise Intrusion Building Siting and Design and Ginninderry Noise Management Plan

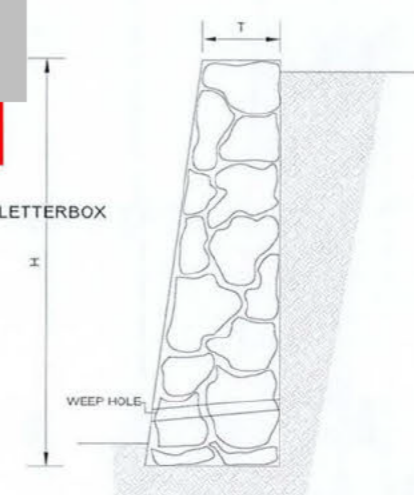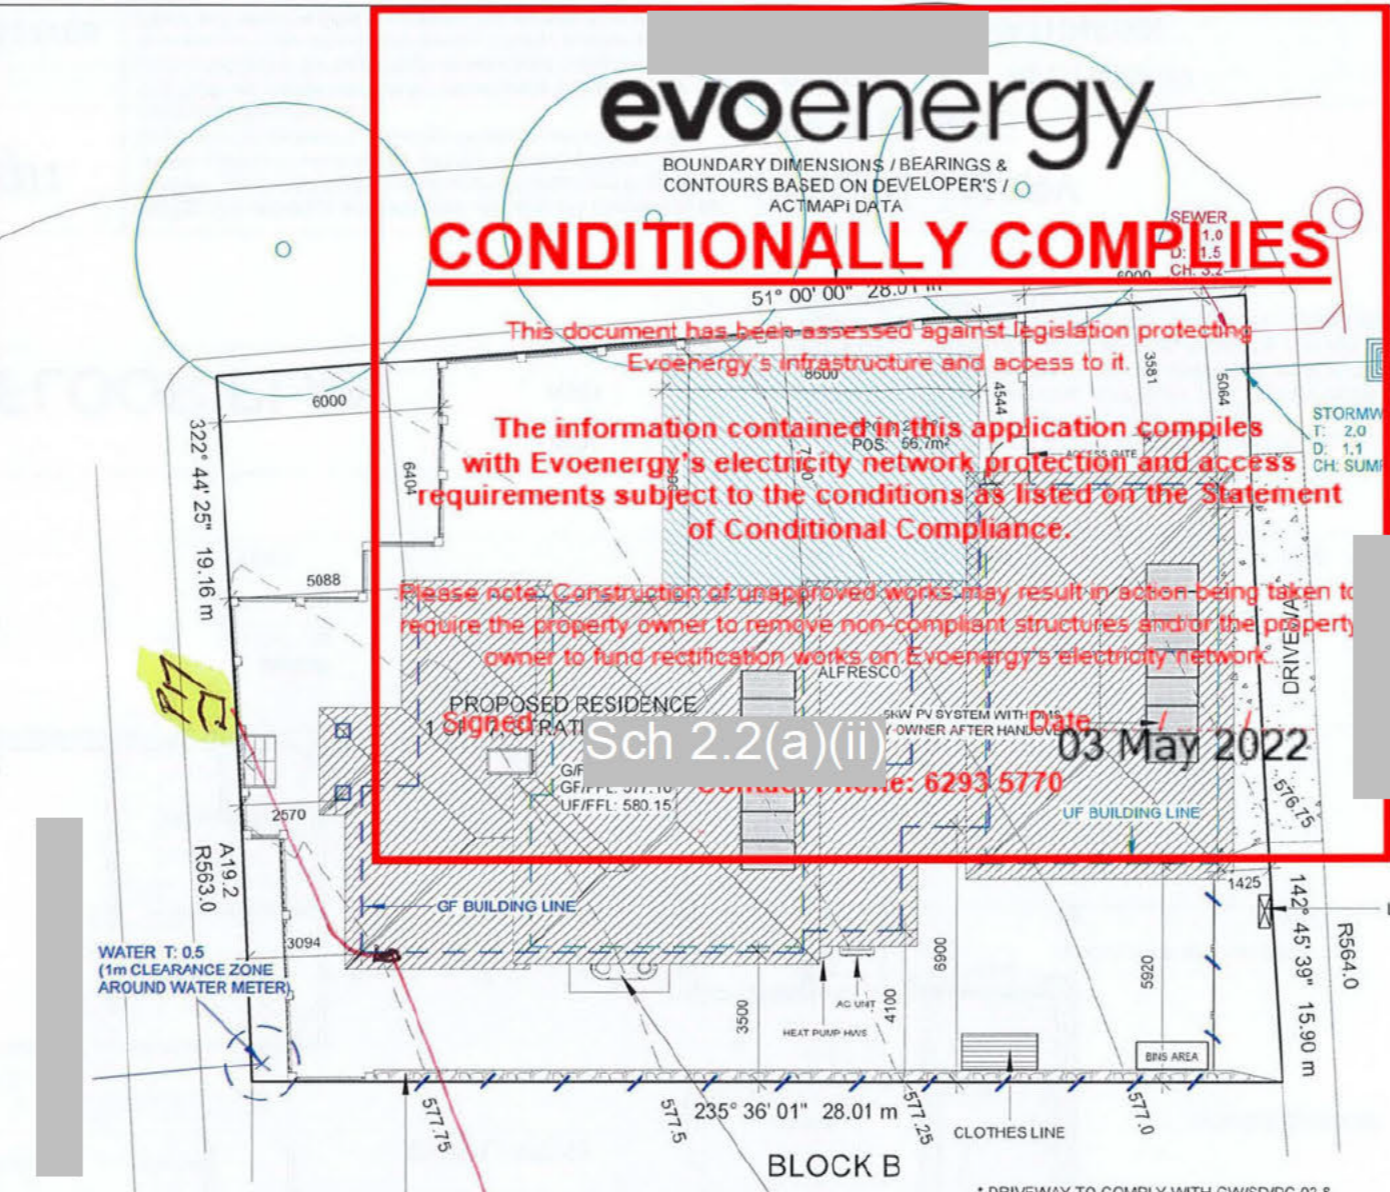

Ww	H	Wf	T
300	900	350	300
500	1500	600	350
600 MAX	1800	700	350
700	2100	800	400

* TIMBER SLEEPER / STONE RETAINING WALL (RW) AND STEPS TO SITE CONDITION, RELEVANT CODES AND DEVELOPERS GUIDELINES
 * SUBSOIL DRAINAGE SYSTEMS: AG PIPE / WATERPROOFING, COMPLIANCE TO RELEVANT CODES/AS/BCA
 * AGRI DRAIN TO PREVENT SURFACE WATER ENTRY AS PER BCA V2, Part 3.1.2/AS 4654.2-2012

IMPORTANT BLOCK INFORMATION
 BLOCK SIZE: 567 m² (RZ3)
 OPEN SPACE MIN: 290.2 m² (60% - 50.0m²)
 MAX GFA (50%): 283.5 m²
 PPOS: 24 m²
 POS: 56.7m² (6m FOR AN AREA NOT LESS THAN 10% OF THE BLOCK AREA AND TOTAL AREA OF HARD LANDSCAPE NOT TO EXCEED 50% AREA OF P.O.S.)

SITE AREA	
OPEN SPACE	404.38 m ²
Footprint	133.25 m ²
Total	537.63 m ²

Construction Area		
Number	Name	Area
1	Sch 2.2(a)(ii)	132.87 m ²
2		61.79 m ²
3		58.42 m ²
4		29.74 m ²
5		36.01 m ²
6		13.38 m ²
7		4.05 m ²
8		2.80 m ²
9		4.40 m ²
10		6.12 m ²
Grand total		349.58 m ²

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1. SITE PLAN
 1 : 200


Virk Building Design Services
 Email: virk.bds@gmail.com Mob: 0425677755

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Sch 2.2(a)(ii)
RESIDENCE
 SUBURB: STRATHNAIRN

SITE PLAN		FOR APPROVAL	
Project number	211201	A100	
Date	6/3/22		
Drawn by	B.Virk		
Checked by	Client		
Scale	1 : 200	on A3	

6/03/2022 4:49:25 PM

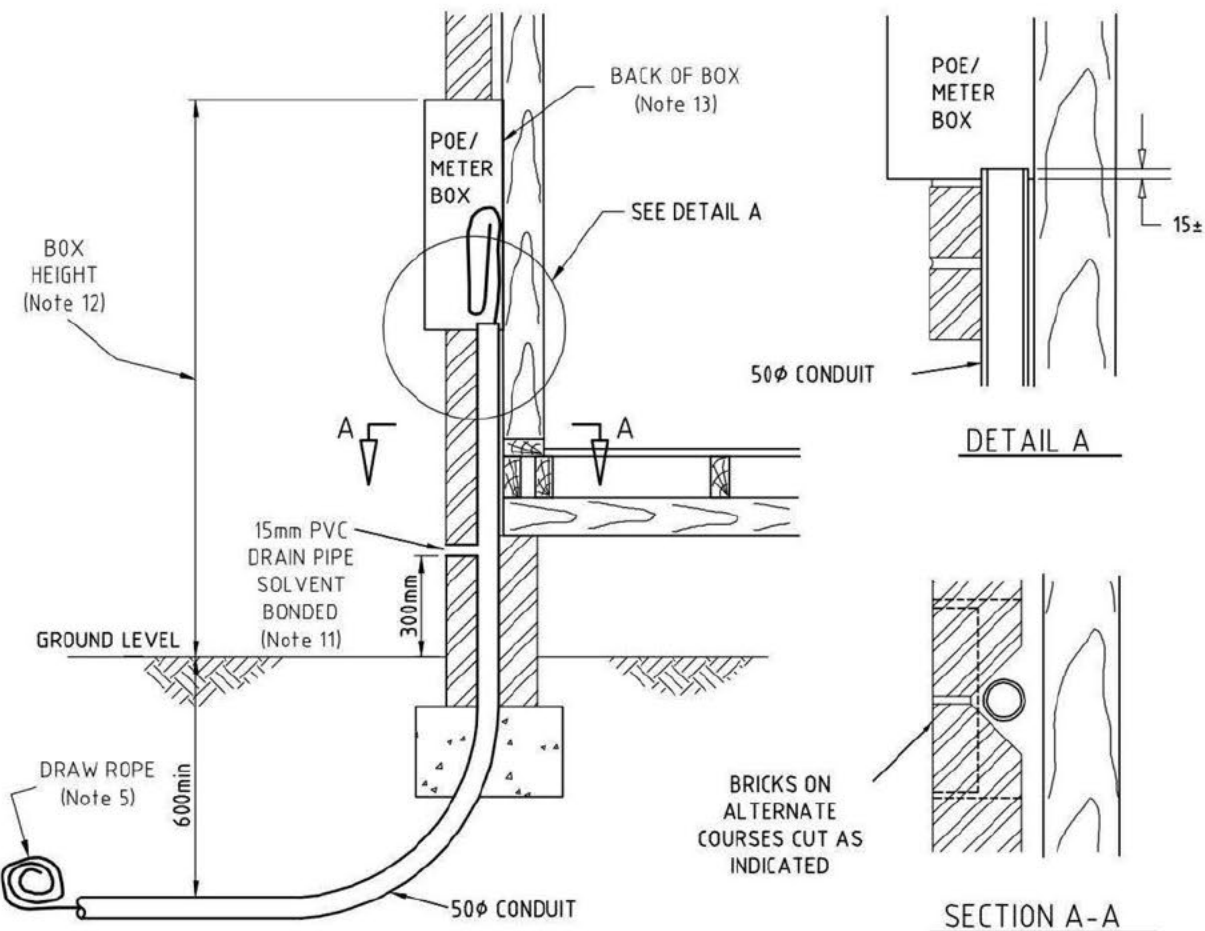

NOTES:

1. ALL POINTS OF ENTRY & CONDUITS ROUTES SHALL BE DETERMINED BY THE SERVICE MARKER OR BE AS SHOWN ON THE APPROVED BUILDING PLAN OR APPROVED CONDUIT REQUEST DRAWING
2. A MARKER PEG SHALL BE PROVIDED TO INDICATE THE END OF THE CONDUIT.
3. CONDUIT ENDS SHALL BE PLUGGED OR CAPPED TO PREVENT THE ENTRY OF FOREIGN MATERIAL
4. THE CONDUIT SHALL ENTER THE POE/METER BOX AS INDICATED ON THIS DRAWING.
5. A CONTINUOUS DRAW ROPE OF MINIMUM 6mm DIAMETER WITH 600mm SPARE AT EACH END SHALL BE PROVIDED IN EACH CONDUIT.
6. THE CONDUIT SHALL NOT CONTAIN ELBOWS AND BENDS SHALL HAVE A MINIMUM BENDING RADIUS OF 450mm.
7. THE SUM OF CONDUIT BEND ANGLES SHALL NOT EXCEED 90° IN A SINGLE RUN.
8. THE POE/METER BOX SHALL HAVE SUFFICIENT SPACE FOR THREE SERVICES FUSES AND A SERVICE NEUTRAL LINK
9. THE CONDUIT AND POE/METER BOX SHALL BE ISOLATED FROM THE TIMBER FRAME WITH DAMP-PROOF MATERIAL.
10. THE CONDUIT SHALL BE 50mmφ AND SHALL BE CATEGORY "A" HEAVY DUTY RIGID ORANGE CONDUIT TO AS2053.
11. SEE DRAWING 8912-03 AND THE SERVICE AND INSTALLATION RULES FOR DRAINAGE DETAILS WHERE REQUIRED.
12. INSTALLATION HEIGHT FOR:
POE BOX (DOMESTIC INSTALLATION) 2300mm - 2800mm TO TOP OF BOX
METER BOX (DOMESTIC INSTALLATION) 1500mm - 2000mm TO TOP OF BOX
13. HOLES CREATED IN THE BACK OF THE BOX (TO ACCOMMODATE OUT-GOING CABLES) SHALL BE SEALED WITH SILICON SEALANT OR A SIMILAR SEALANT.

ADDITIONAL REFERENCES:

EVOENERGY SERVICE AND INSTALLATION RULES
EVOENERGY CONDUIT TECHNICAL STANDARDS (SM11106)

M	UPDATED FOR POWER OF CHOKE REFORMS	2/11/2017	Sch 2.2(a)(ii)		Drawn:	Designed: A-NNR
L	NOTE 13 ADDED	23/10/2013	RS	BS	Checked:	
K	DRAIN PIPE DETAILS AMENDED	10/14/2013	EA	BS	Approved:	A-NNR
N	LOGO AND REFERENCES UPDATED TO EVOENERGY	8/01/2018	Sch 2.2(a)(ii)		Project No:	
No	Revision	Date	Checked	Approved		

evoenergy

**UNDERGROUND SERVICE
CONDUIT REQUIREMENTS**

Scale:	Date: 16/03/1999	Sheet No:
Work Pack No:	File:	
Status:	Current	
A3	8912-02	Rev N



Gas Networks

STATEMENT OF

CONDITIONAL COMPLIANCE

For Residential except High Rise

Application No: 200963

Drawings in set: 1

Block: [REDACTED]

Section: [REDACTED]

Suburb: Strathnairn

This application has been assessed against legislation protecting Evoenergy's gas infrastructure and access to it.

This application is approved subject to compliance with the following conditions:

- The location and area allocated for gas regulating and metering equipment is to comply with Evoenergy Gas Service and Installation Rules.
- Development is to comply with minimum separation requirements to underground assets
 - 300mm minimum clearance from major plastic and steel gas mains and steel gas services
 - 150mm minimum clearance from other plastic gas mains and services
- A metering equipment upgrade may be required. A licensed gas fitter should verify loads and metering equipment capacities.
- If a meter relocation or service pipe relocation is required in order to comply with Evoenergy standards, please contact your gas retailer and book a meter relocation. Only people accredited by Evoenergy can carry out this work.

Other:

Please note:

- WARNING:** Evoenergy underground gas pipes may be in or adjacent to this block. Evoenergy Asset Location Advice may be required. Call 1100.
- Development and Building Applications will need to include any proposed Evoenergy works
- If Evoenergy approval conditions are not met, a breach of the law may result.
- Separate applications are required for water & sewerage, electricity and communication network services.
- Construction of unapproved works may result in action being taken to require the property owner to remove non-compliant structures and/or the property owner to fund rectification works on Evoenergy's gas network
- Any attached reticulation or servicing plan is preliminary only. Contact Evoenergy for final plans prior to the commencement of any construction activity

For further information please phone **Sch 2.2(a)(ii)**


Application Number: 2101010
 Sheet 1 of 10

IMPORTANT NOTES:
 THE PRECEDENCE OF REGULATIONS TAKE PRECEDENCE OVER THE DRAWINGS. DETAIL DRAWINGS TAKE PRECEDENCE OVER GENERAL DRAWINGS.
 *DO NOT SCALE DRAWINGS - ALL DIMENSIONS IN "mm".
 *BUILDER TO CHECK ALL DIMENSIONS ON SITE PRIOR TO COMMENCEMENT OF CONSTRUCTION WORKS, PRODUCING SHOP DRAWINGS OR FABRICATING COMPONENTS.
 *BUILDER TO CHECK ALL WINDOW DIMENSIONS BEFORE ORDERING ON FLOOR PLAN AND ELEVATIONS.
 *ALUMINIUM FRAMED DOORS/WINDOWS WITH OPENING STYLES IN ACCORDANCE WITH ELEVATIONS AND FROM APPROVED MANUFACTURER UNO.

ENTRALS TO CROSS MANUFACTURERS TABLES, ROOF TRUSSES TO MANUFACTURER'S SPECIFICATION.
 *ALL CONSTRUCTION WORK TO BE DONE IN ACCORDANCE WITH BCA AND RELEVANT AUSTRALIAN STANDARDS AND DEVELOPMENT CODES.
 *TERMITE PROTECTION TO COMPLY WITH AS1694 'PHYSICAL BARRIERS' & AS3660 'APPENDIX D' AND TO ACT BUILDING CONTROL BUILDING NOTE NO3, FRAMING TO AS1684 'NATIONAL TIMBER FRAMING CODE' AND SUPPLIMENTS, HARDWOOD TO AS.2796, ELECTRICAL TO AS.3000, PLUMBING TO AS3500, CONCRETE TO AS.3600, BRICKWORK TO AS.3700, 'SAA MASONRY CODE' AND AS.1640 'SAA BRICKWORK CODE', STRUCTURAL STEEL TO AS.1170 & AS.4100, WET SEAL TO AS.3740 AND .
 *SMOKE ALARMS CONNECTED TO MAINS POWER SUPPLY, WITH BATTERY BACKUP, ARE TO BE INSTALLED IN ACCORDANCE WITH AS3786.
 *BLOCK BOUNDARIES, CONTOURS, SERVICES AND EASEMENTS TO BE VERIFIED ON SITE PRIOR TO CONSTRUCTION.
 *CONFIRM ALL LEVELS AND CONTOURS ON SITE PRIOR TO COMMENCEMENT OF CONSTRUCTION. BUILDER IS RESPONSIBLE TO ENSURE ALL INFORMATION SHOWN HERE REGARDING LEVELS ARE ACCURATE AND REPRESENTS EXISTING ON SITE LEVELS.
 *THE FFLs ARE SUBJECT TO CHANGE AND ARE UP TO BUILDERS DISCRETION TO BE VERIFIED ON SITE, MAXIMUM CHANGE UNDER 340 mm, TO BE CONFIRMED BY CERTIFIER.
 *LOCATION OF CUTS ARE INDICATIVE ONLY AND TO BE VERIFIED ON SITE. THEREFORE, ALL CUTS & FFL TO BE VERIFIED ON SITE BY A REGISTERED SURVEYOR.
 *0.3 M CUT APPROX AT LINE OF HOUSE - SITE TO BE LEVELED / GRADED TO ALLOW FOR SURFACE DRAINAGE AS PER BCA.
 *RETAINING WALL TO BE BUILT ENSURING DRAINAGE AS PER RELEVANT CODES/BCA V2. HEIGHTS AND ALL LEVELS TO SUIT SITE CONDITIONS. FINAL HEIGHTS TO BE CONFIRMED BY BUILDER ON SITE.
 *SEDIMENT & EROSION CONTROL TO COMPLY WITHIN THE BEST PRACTICE GUIDELINES - PREVENT SOULTION FOR RESIDENTIAL BUILDING SITES MARCH 2006 AND ENVIRONMENT PROTECTION GUIDELINES FOR CONSTRUCTION AND LAND DEVELOPMENT IN THE ACT, MARCH 2011.
 *BUILDER TO PROVIDE CRUSHED GRANITE OR AGGREGATES AT ACCESS POINT TO SITE DURING CONSTRUCTION

1. SITE PLAN

1 : 200

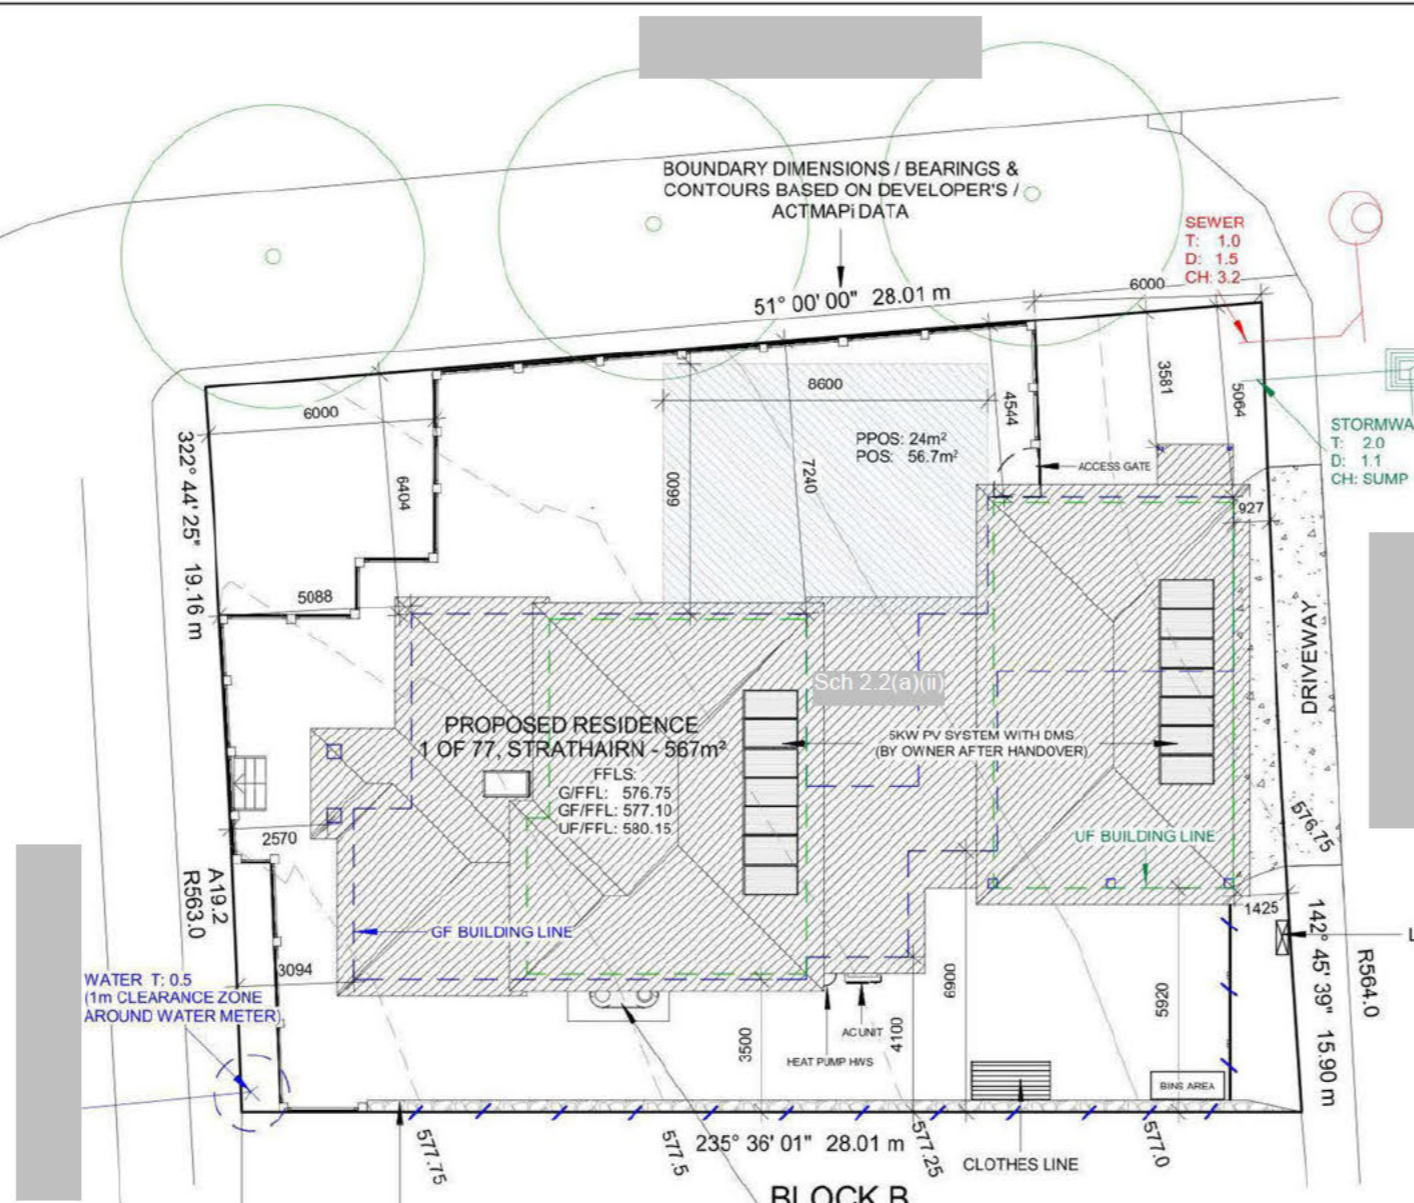

BOUNDARY DIMENSIONS / BEARINGS & CONTOURS BASED ON DEVELOPER'S / ACT/MAPI/DATA

SEWER T: 1.0 D: 1.5 CH: 3.2

STORMWATER T: 2.0 D: 1.1 CH: SUMP

WATER T: 0.5 (1m CLEARANCE ZONE AROUND WATER METER)

RETAINING WALL (MAX CUT / RW HT: 1.5m WITH IN 1.5m OF BOUNDARIES) AND STEPS TO SITE CONDITION

* MIN 4000L RAINWATER TANK, 50% OR 100m² OF ROOF AREA, WHICHEVER IS THE LESSER, IS CONNECTED TO THE TANK.
 * TANK IS CONNECTED TO ATLEAST A TOILET, LAUNDRY COLD WATER AND ALL EXTERNAL TAPS, AS PER ACT TERRITORY PLAN.
 *THE CONNECTION WILL REQUIRE A PUMP WHERE IT CANNOT BE ELEVATED SUFFICIENTLY TO GIVE ADEQUATE PRESSURE

* DRIVEWAY TO COMPLY WITH GW/SD/DC.02 & FINISH TO COMPLY WITH ALL LEASE & DEVELOPMENT CONDITIONS AND RELEVANT LOCAL CODES
 * IF LEVELS & CONTOURS ARE DIFFERENT ON SITE FROM THE DRAWING BUILDER TO PROVIDE CONTOUR PLAN & REPORT BACK TO THE DESIGNER TO ADJUST LEVELS ACCORDINGLY.
 * NO PART OF CUT SHOULD ENCR OACH OUT OF THE BOUNDARY OR EASEMENT


AC UNITS MUST BE INSTALLED AS PER PART 5 OF THE HOUSING DEVELOPMENT REQUIREMENTS. AC UNITS MUST BE ONE (OR MORE) OF THE FOLLOWING:
 * Reverse cycle air conditioning that achieves a minimum
 o Energy Efficiency Ratio (EER) of 3.5 for the cooling cycle
 o Coefficient of Performance (COP) of 3.5 for the heating cycle
 * Air conditioning with a cooling cycle only that achieves a minimum Energy Efficiency Ratio (EER) of 3.5
 o ducted evaporative cooling with a self-closing damper
 o ground source heat pump

710 x 230 BRICK PIERS TO BE PAINTED RESIDENCE COLOUR OR BRICKWORK TO MATCH RESIDENCE

COURTYARD WALL TO BE CONSTRUCTED IN ACCORDANCE WITH TERRITORY PLAN AND LEASE AND DEVELOPMENT CONDITIONS

ALL CONCRETE FOOTINGS & SLABS TO BE IN ACCORDANCE WITH S.A.A CODE 2870.1

PROPOSED PLANTS TO CLIENTS SPEC

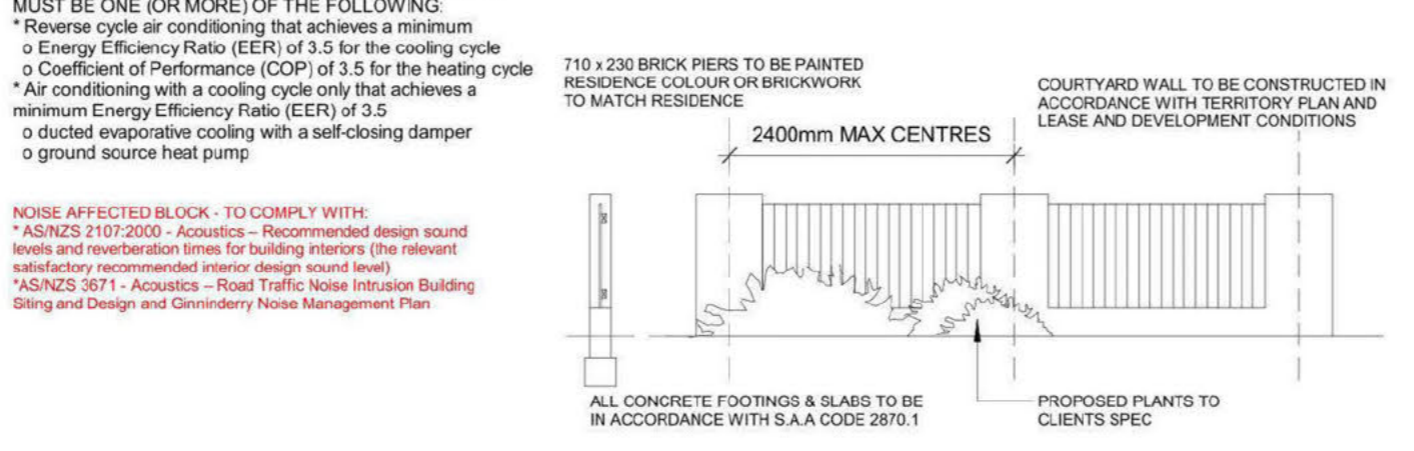

IMPORTANT BLOCK INFORMATION

BLOCK SIZE: 567 m² (R73)
 OPEN SPACE MIN: 290.2 m²
 PPOS: 24 m²
 POS: 56.7 m²
 GAS NETWORKS FOR AN AREA NOT LESS THAN 10% OF THE BLOCK AREA AND TOTAL AREA COVERED LANDSCAPE NOT TO EXCEED 50% AREA OF P.O.S.)

CONDITIONALLY COMPLIES

This document has been assessed against legislation protecting Evoenergy's infrastructure and access to it

The information contained in this application complies with Evoenergy's gas network protection and access requirements subject to the conditions as listed on the Statement of Conditional Compliance.

Please note: Construction of unapproved works may result in action being taken to require the property owner to remove non-compliant construction. As the property owner to fund rectification works on Evoenergy's gas network.

Number	Name	Area
1	Sch 2.2(a)(ii)	132.87 m²
2	Sch 2.2	61.79 m²
3		58.42 m²
4		29.74 m²
5		36.01 m²
6		13.38 m²
7		4.05 m²
8		2.80 m²
9		4.40 m²
10		6.12 m²
Grand total		349.58 m²

ROCK RETAINING WALL

* TIMBER SLEEPER / STONE RETAINING WALL (RW) AND STEPS TO SITE CONDITION, RELEVANT CODES AND DEVELOPERS GUIDELINES
 * SUBSOIL DRAINAGE SYSTEMS: AG PIPE / WATERPROOFING, COMPLIANCE TO RELEVANT CODES/AS/ BCA
 * AGRI DRAIN TO PRVENT SURFACE WATER ENTRY AS PER BCA V2, Part 3.1.2/AS 4654.2-2012

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CONDITIONALLY COMPLIES

SITE AREA	
Open Space	104.38 m ²
Footprint	133.25 m ²
Total	537.63 m ²

Information contained in this application complies with Evoenergy's gas network protection and access requirements subject to the conditions as listed on the Statement of Conditional Compliance.

Number	Name	Area
1	GF Living	132.87 m ²
2	UF Living	61.79 m ²
3	Surv Unit	58.42 m ²
4	Garage	29.74 m ²
Grand total		282.83 m ²

Note: Construction of unapproved works may result in action being taken to the property owner to remove non-compliant structures and/or the property owner to fund rectification works on Evoenergy gas network.


Sch 2.2(a)(ii) Date: 13 April 2022

Contact Phone: Sch 2.2(a)(ii)

Sch 2.2(a)(ii)

Construction Area		
Number	Name	Area
1	Sch 2.2(a)(ii)	132.87 m ²
2		61.79 m ²
3		58.42 m ²
4		29.74 m ²
5		36.01 m ²
6		13.38 m ²
7		4.05 m ²
8		2.80 m ²
9		4.40 m ²
10		6.12 m ²
Grand total		349.58 m ²

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2. GROUND FLOOR PLAN

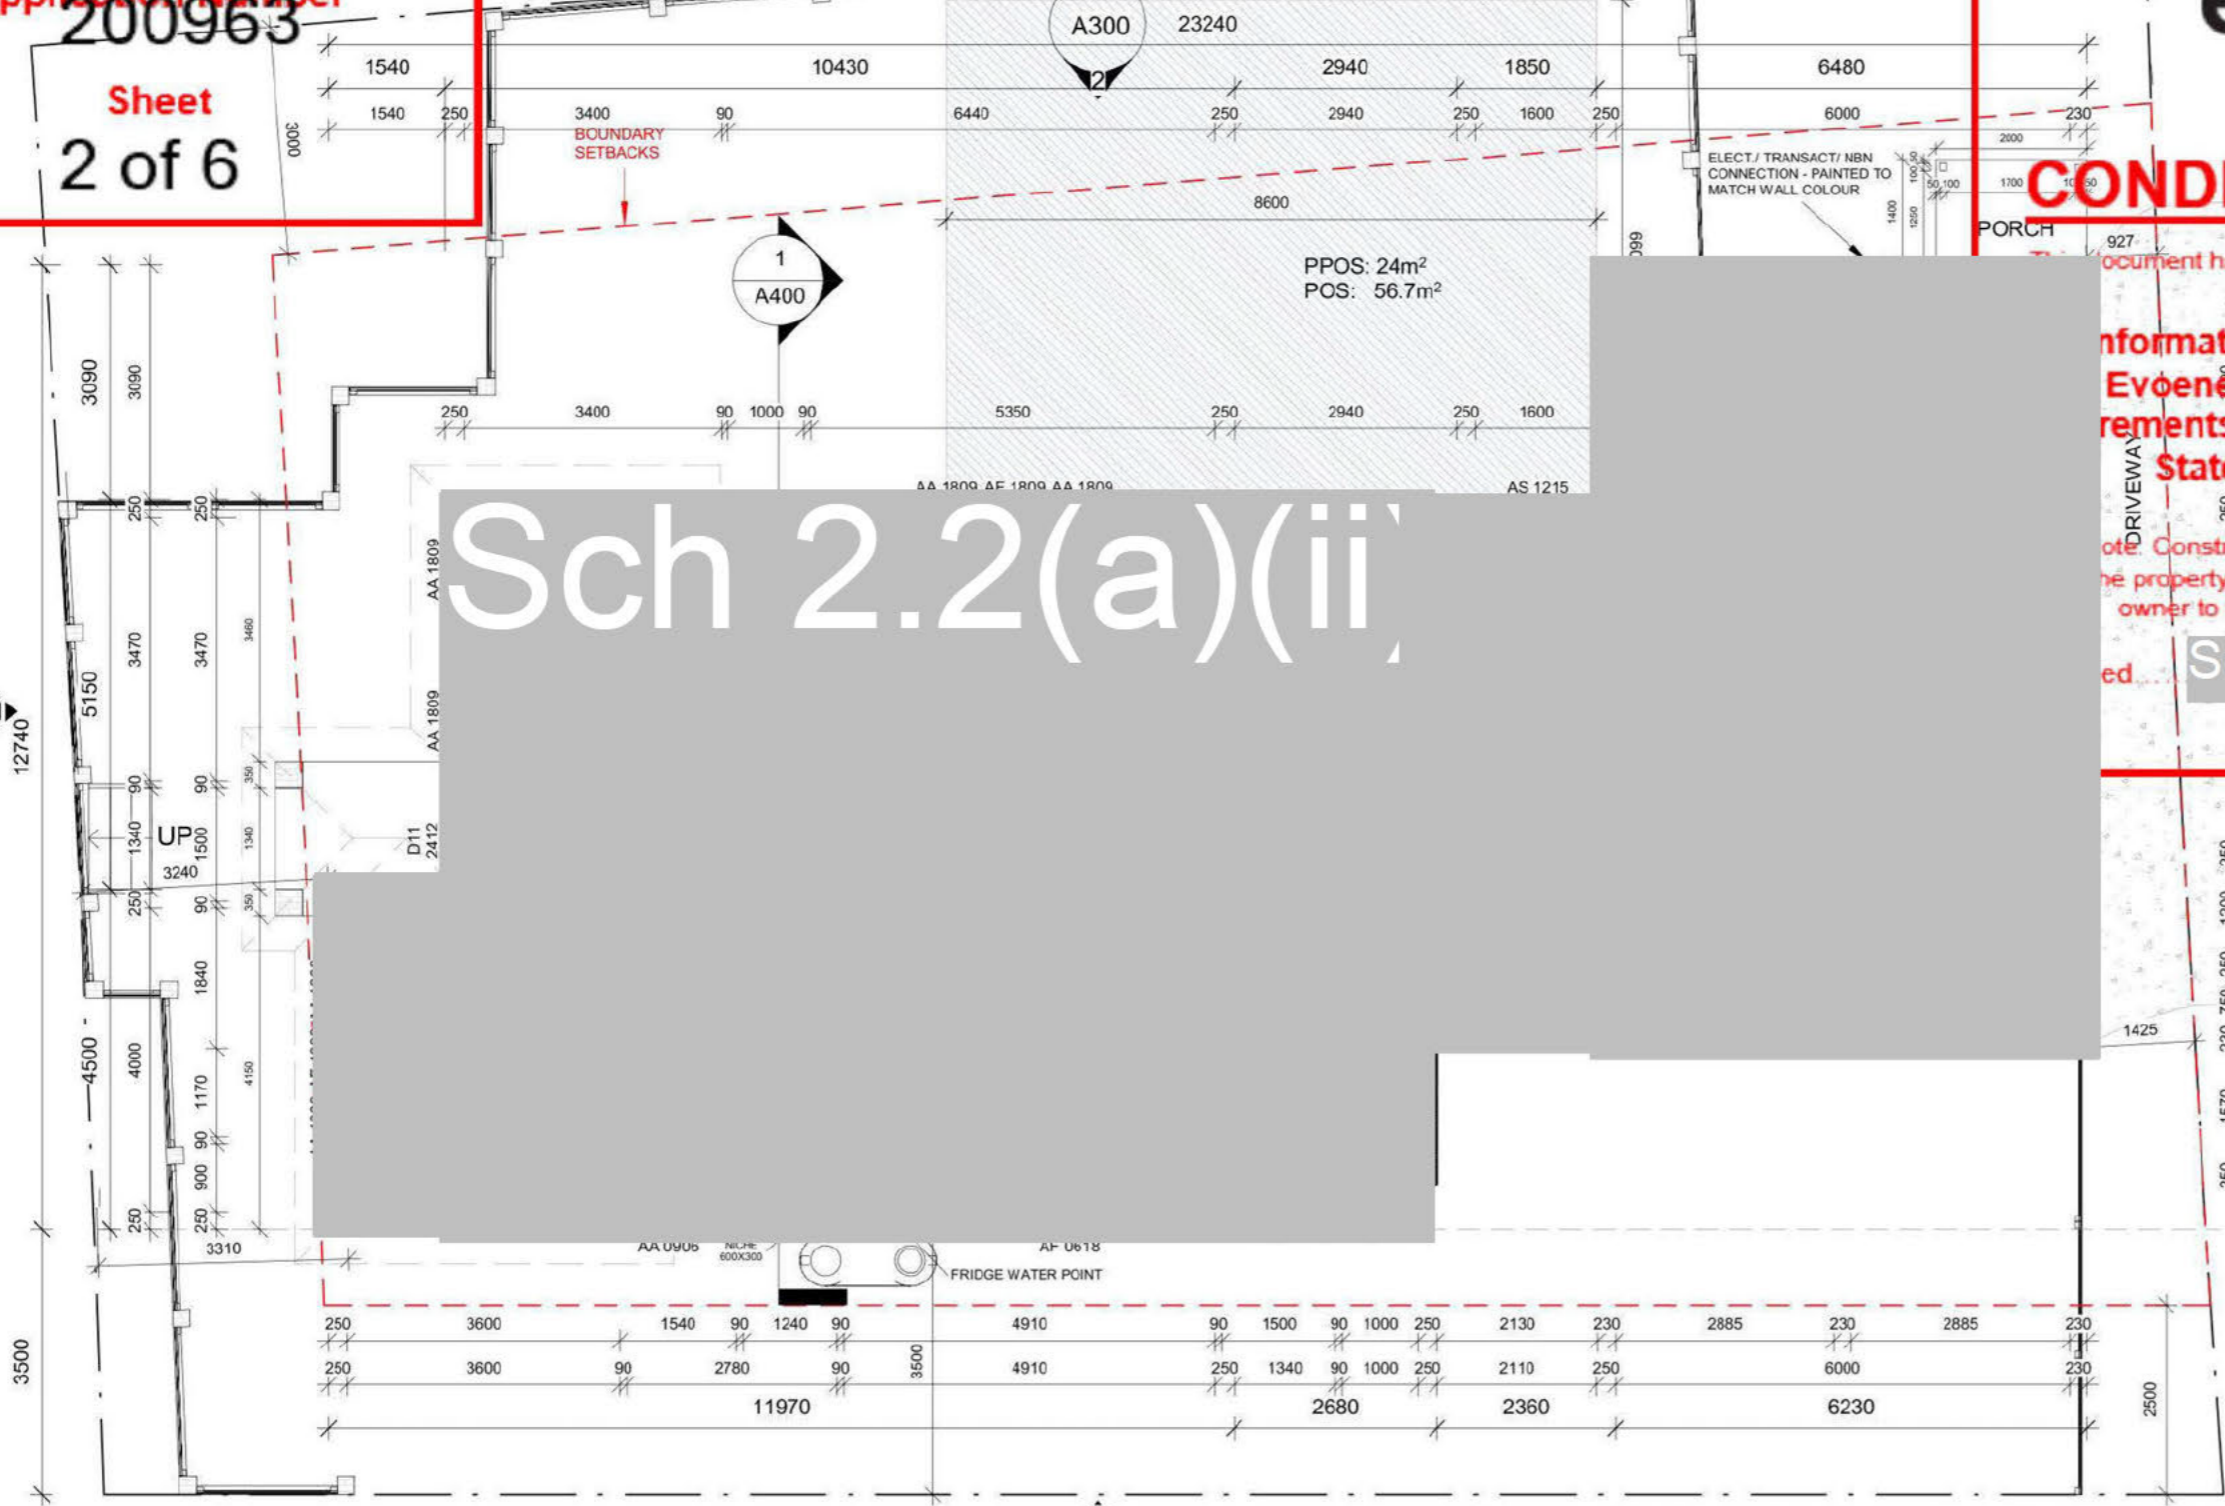1 : 100

- ALL MECHANICAL VENTILATION TO BE DUCTED DIRECTLY TO OUTSIDE ROOF SPACE IN ACCORDANCE WITH BCA V2 PART 3.8.7.4
- FLOW RATE OF MECHANICAL SYSTEMS TO COMPLY WITH BCA V2 3.8.7.3
- UPPER FLOOR WINDOWS TO BE RESTRICTED IN ACCORDANCE WITH BCA V2 3.9.2.6
- ALL WINDOWS AND SLIDERS AS PER AS2047 & AS1288 AND DOUBLE GLAZED
- FLOOR DRAINS IN ALL WET AREAS / BALCONY / OUTDOOR AS REQUIRED
- ALL INTERNAL DOORS HEIGHT: 2040mm

Virk Building Design Services

Email: virk.bds@gmail.com Mob: 0425677755

NOTE: The drawings are indicative only and are required to be verified / confirmed by the owner and/or builder and engineer and/or certifier in accordance with the relevant Building Legislation/Regulations, Housing Development Codes, NCC, Australian Standards, etc.
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Sch 2.2(a)(ii)
 RESIDENCE
 SUBURB: STRATHNAIRN

GROUND FLOOR PLAN FOR APPROVAL

Project number	211201	A200
Date	6/3/22	
Drawn by	B.Virk	
Checked by	Client	
Scale		1 : 100 on A3


CONDITIONALLY COMPLIES

Sch 2.2(a)(ii) assessed against legislation protecting Evoenergy's infrastructure and access to it
 contained in this application complies with gas network protection and access to the conditions as listed on the Schedule of Conditional Compliance.

If unapproved works may result in action being taken to remove non-compliant structures and/or the property information works on Evoenergy's gas network.

Sch 2.2(a)(ii) Date: 13 Apr 2022

Contact Phone: Sch 2.2(a)(ii) A301

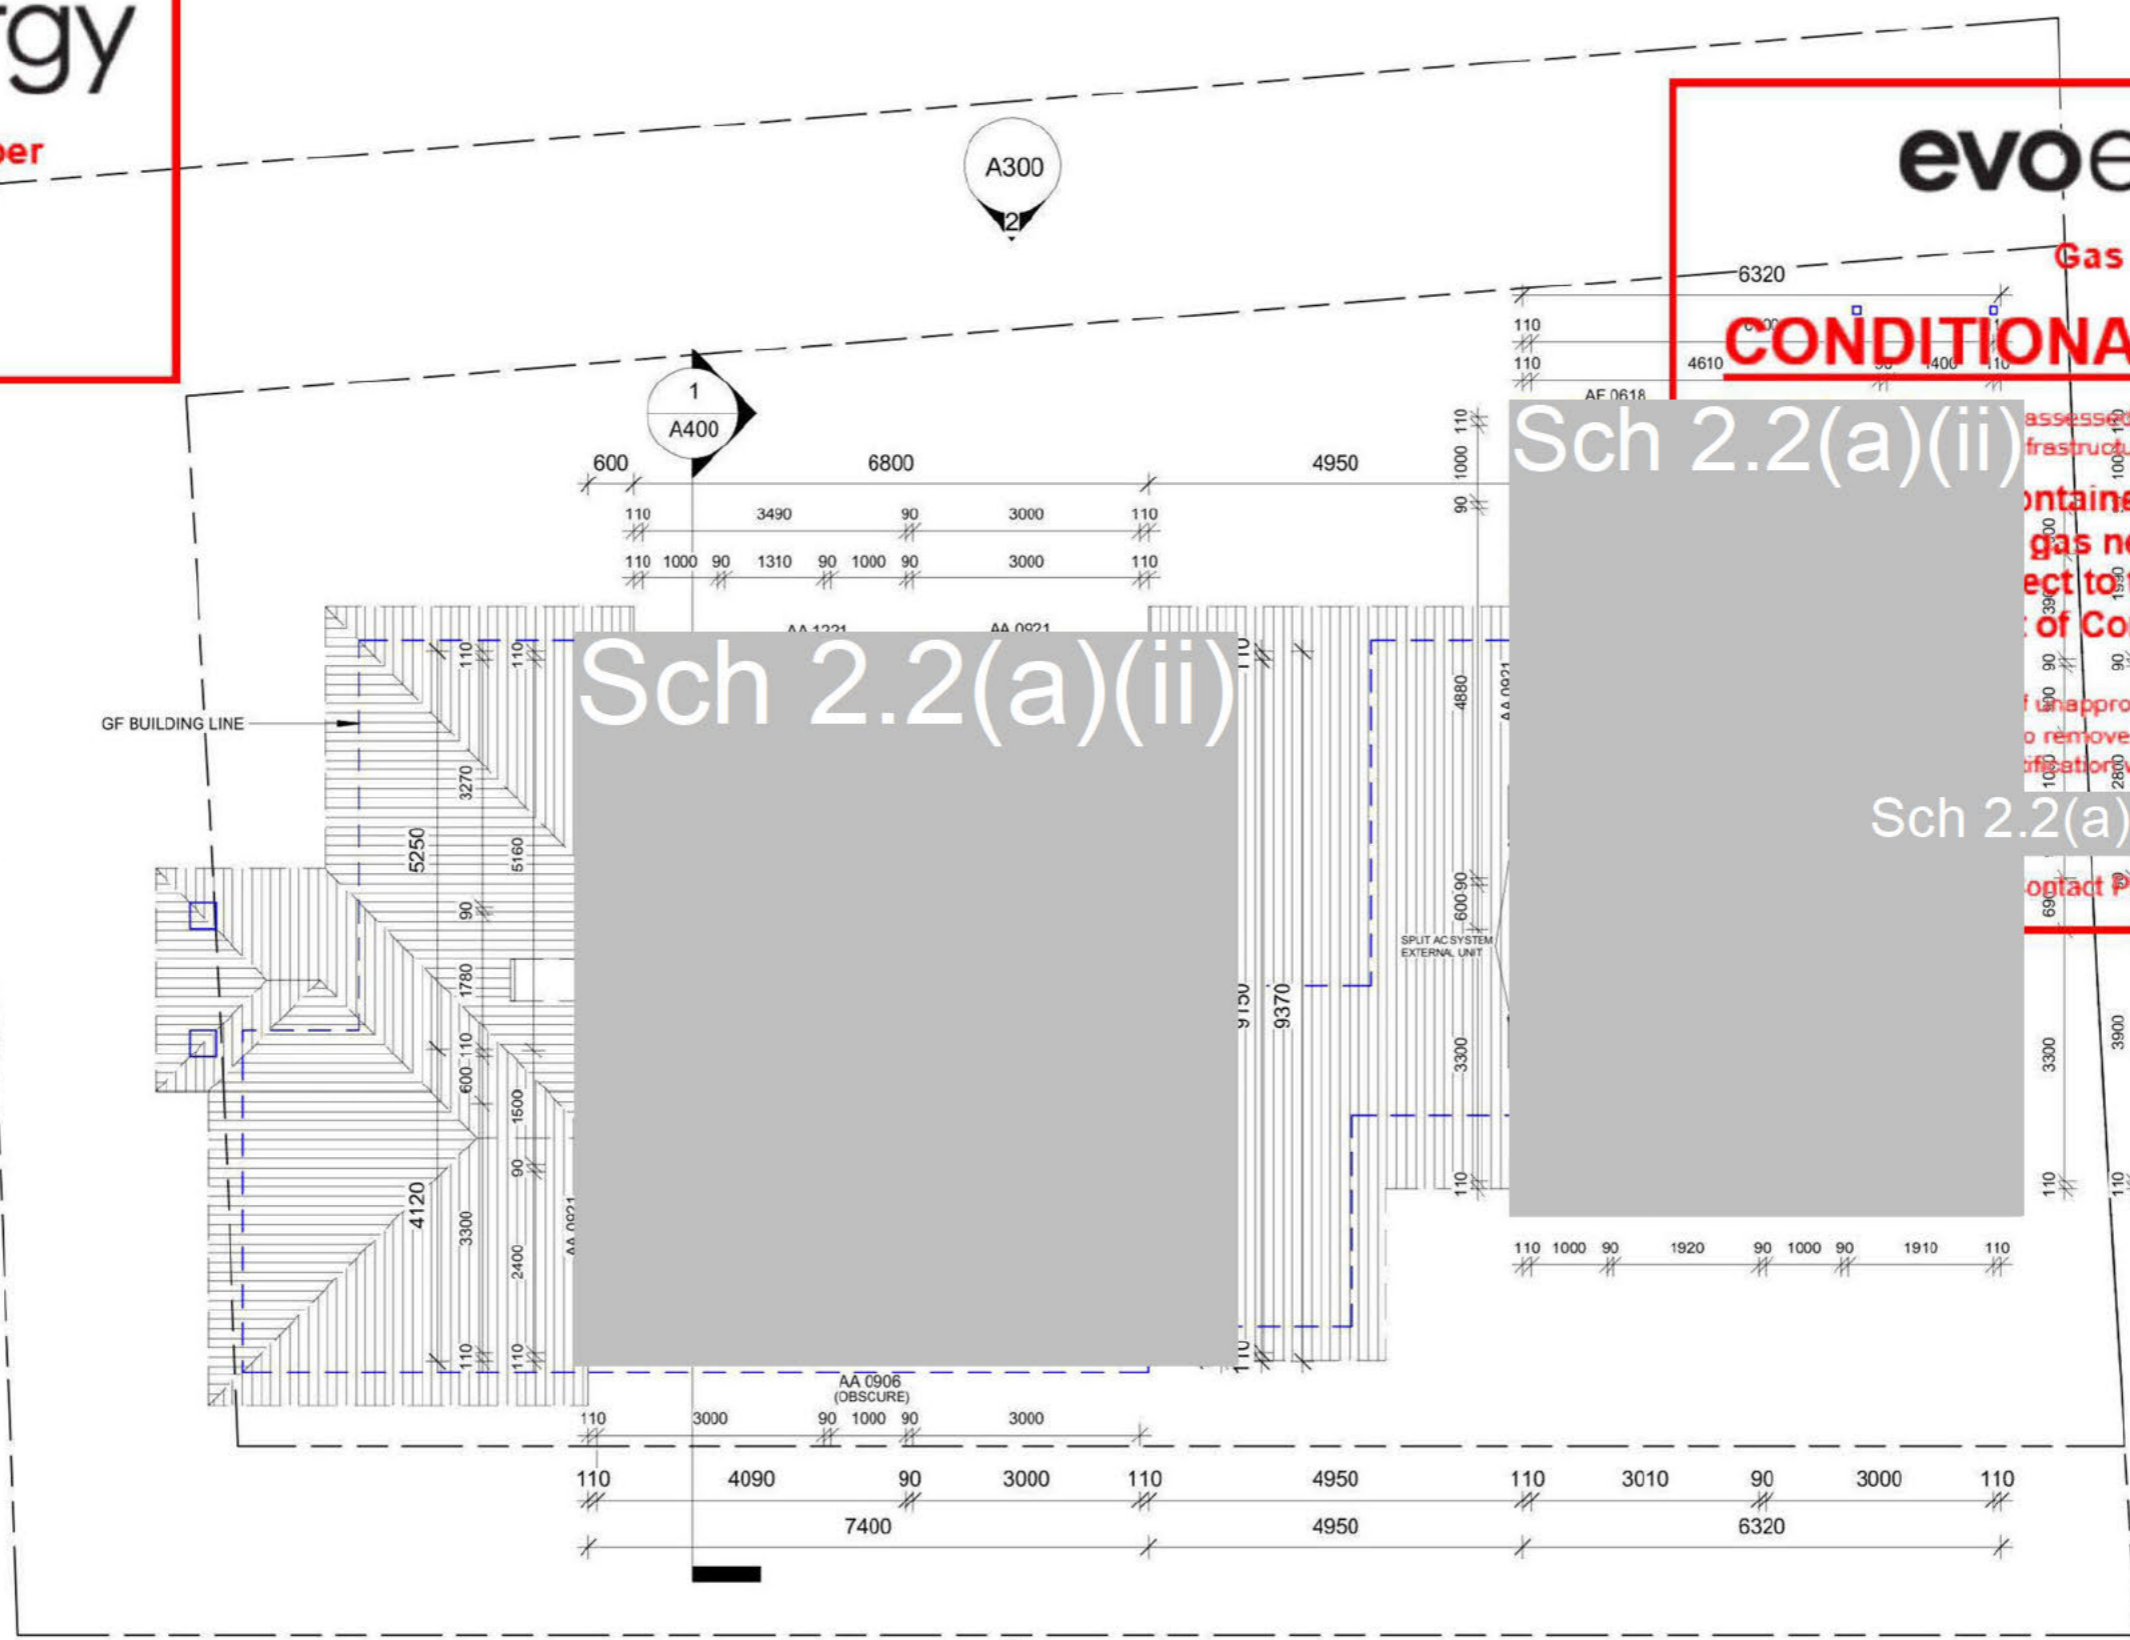

3. UPPER FLOOR PLAN

1 : 100

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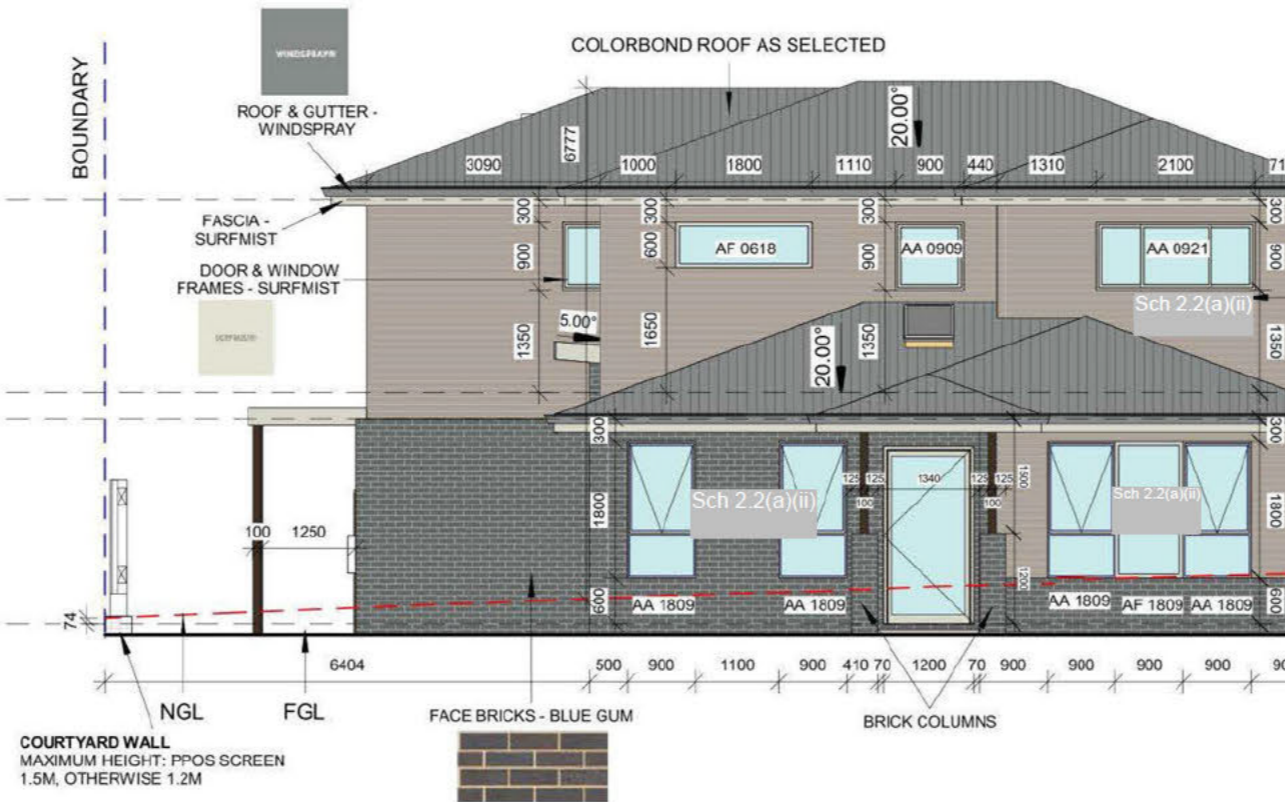
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Sch 2.2(a)(ii)
 RESIDENCE
 SUBURB: STRATHNAIRN

UPPER FLOOR PLAN FOR APPROVAL

Project number	211201	A201
Date	6/3/22	
Drawn by	B.Virk	
Checked by	Client	Scale 1 : 100 on A3

BUILDING ENVELOPE / SOLAR ACCESS



Elevation 1

1 : 100

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Gas Networks

CONDITIONALLY COMPLIES

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Signed: Sch 2.2(a)(ii) Date: **13 Apr 2022**

Contact Phone: Sch 2.2(a)(ii)

BUILDING ENVELOPE / SOLAR ACCESS



Elevation 2

1 : 100

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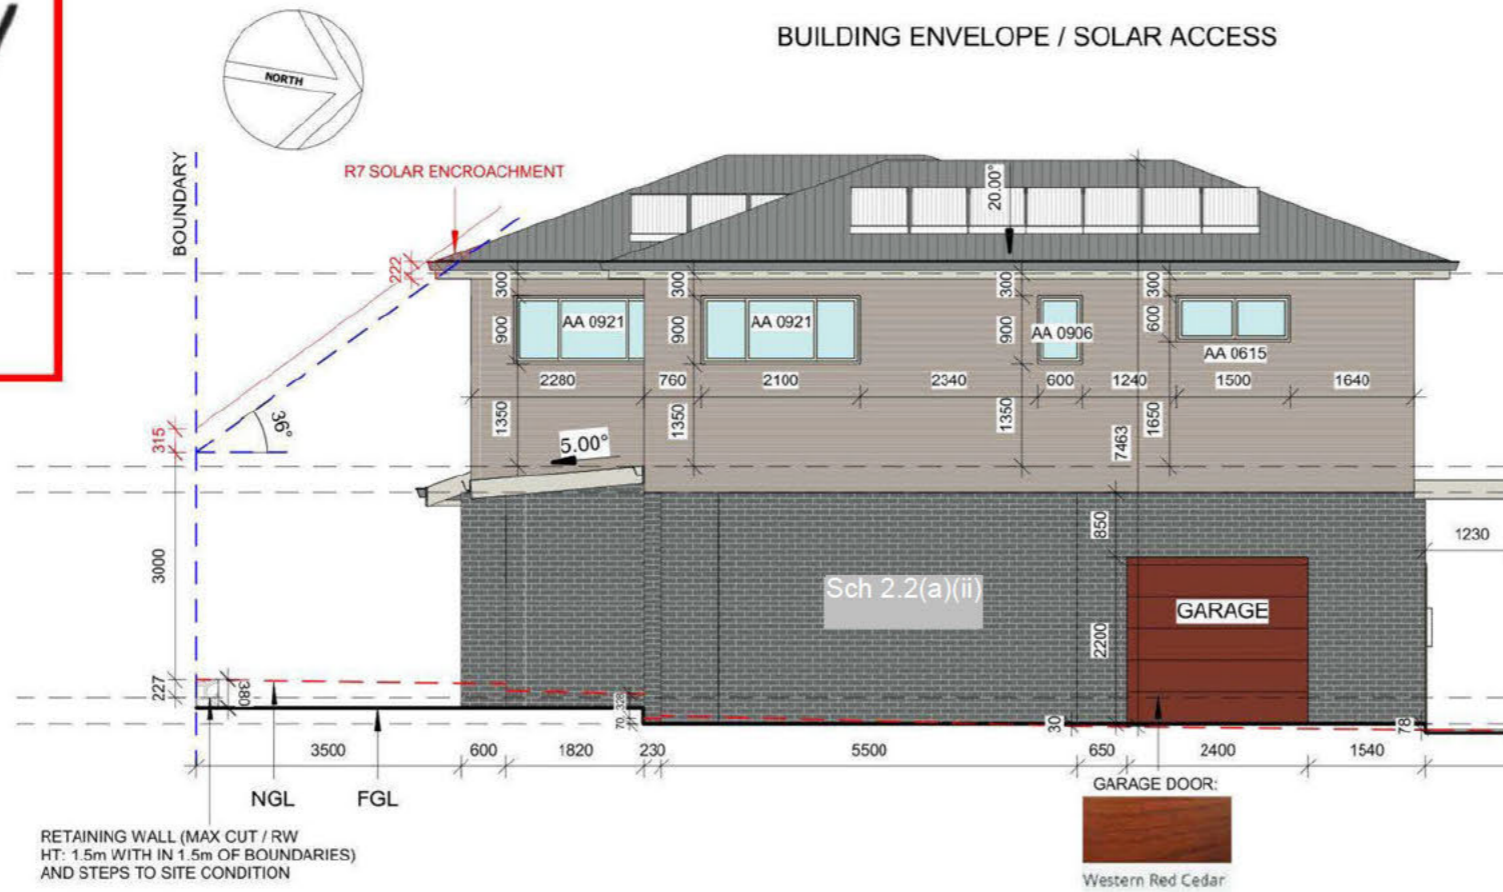
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Sch 2.2(a)(ii)
RESIDENCE
 SUBURB: STRATHNAIRN

ELEVATION 1&2		FOR APPROVAL	
Project number	211201	A300	
Date	6/3/22		
Drawn by	B.Virk		
Checked by	Client	Scale	1 : 100 on A3

6/03/2022 4:49:27 PM

BUILDING ENVELOPE / SOLAR ACCESS



Elevation 3

1 : 100

RETAINING WALL (MAX CUT / RW
HT: 1.5m WITH IN 1.5m OF BOUNDARIES)
AND STEPS TO SITE CONDITION

evoenergy
Gas Networks

CONDITIONALLY COMPLIES

This document has been assessed against legislation protecting Evoenergy's infrastructure and access to it


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Sch 2.2(a)(ii) Date: 13 Apr 2022

Contact Phone: Sch 2.2(a)(ii)

BUILDING ENVELOPE / SOLAR ACCESS



Elevation 4

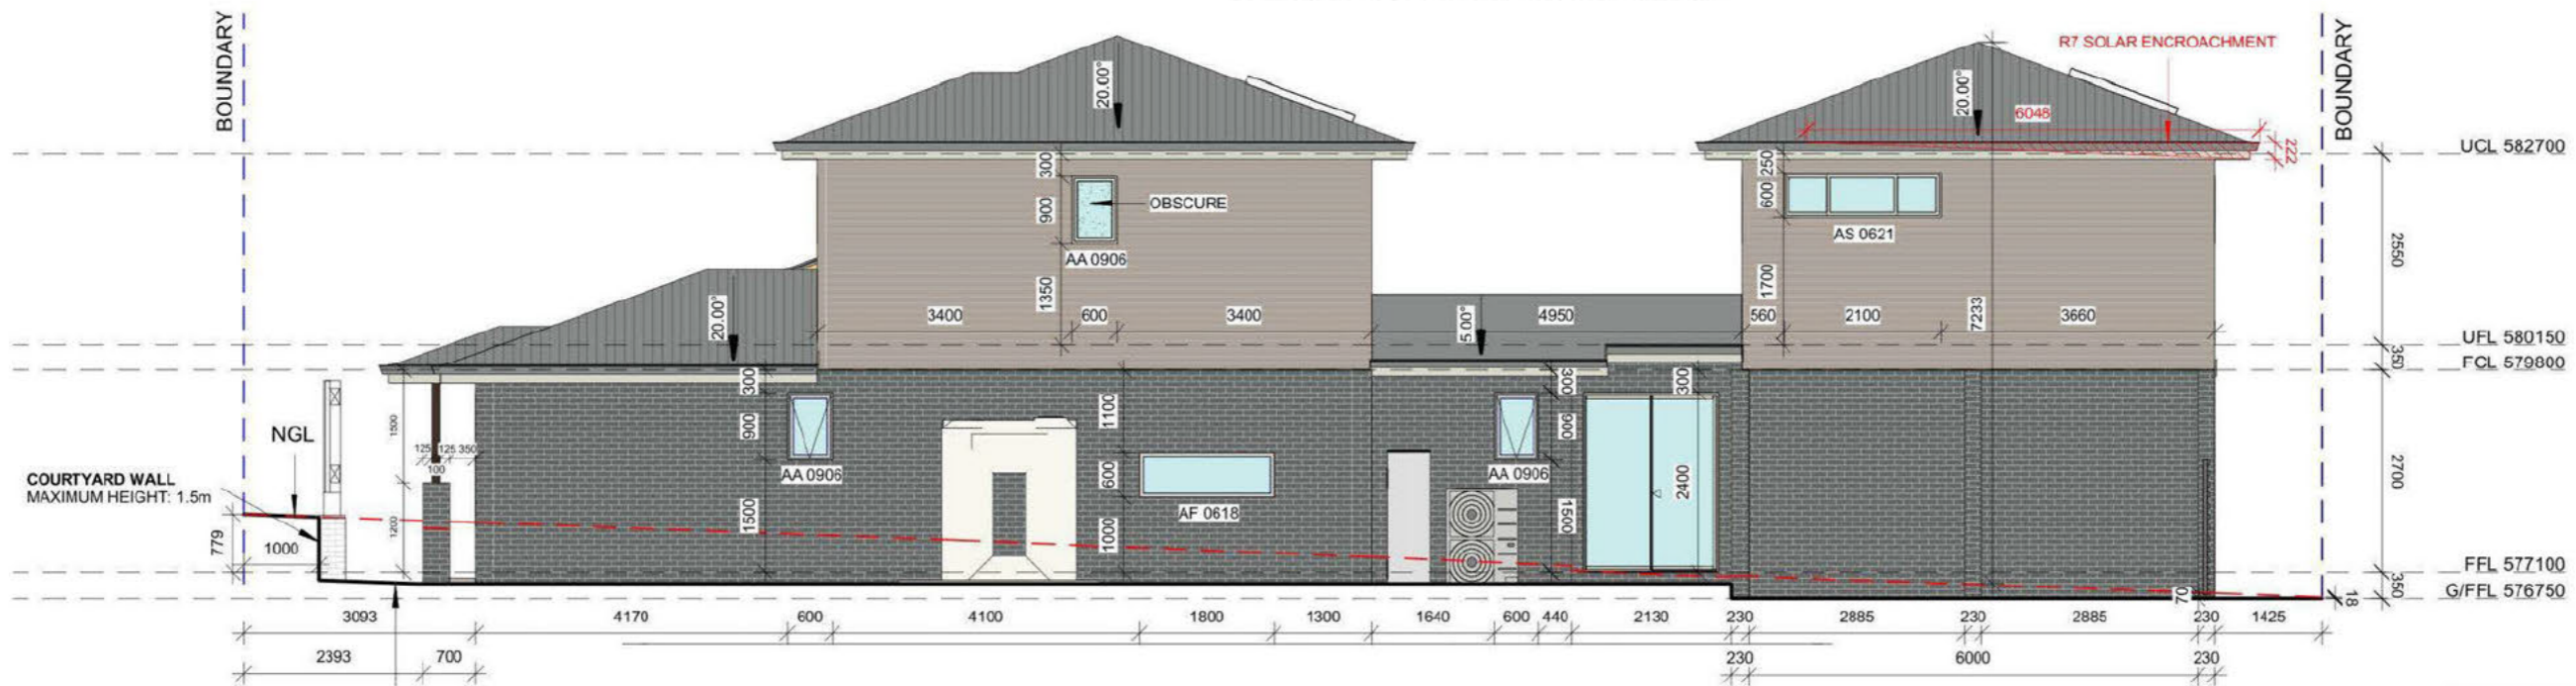1 : 100

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Sch 2.2(a)(ii)
RESIDENCE
SUBURB: STRATHNAIRN

ELEVATION 3&4		FOR APPROVAL	
Project number	211201	A301	
Date	6/3/22		
Drawn by	B.Virk		
Checked by	Client		
		Scale	1 : 100 on A3

6/03/2022 4:49:27 PM

WINDOWS / DOORS:
 * ALL METAL FRAMING, GLAZING, AND SCREENS, ETC TO CONFORM TO AS/NZS 4200.1 & ENGINEER'S DESIGN / SPECIFICATIONS.
 * ALL ALUMINIUM DOORS AND WINDOWS TO BE ALUMINIUM IMPROVED.
ELECTRICAL:
 * ALL ELECTRICAL WORK TO BE IN ACCORDANCE WITH AUTHORITY REQUIREMENTS, RELEVANT CODES, REGULATIONS AND AS DIRECTED BY THE BUILDER.
 * LIGHTING TO COMPLY WITH CLAUSE 3.12.5.5 OF BCA.
 * DOWNLIGHTS INSTALLED WITH APPROVED NON-VENTILATED COVER OR SHIELD ALLOWING INSTALLATION OF INSULATION TO SIDES AND TOP.
 * SMOKE ALARMS TO BE INSTALLED IN ACCORDANCE WITH BCA, BUILDING NOTE 19 & TO COMPLY WITH AS3786. SMOKE ALARMS TO BE CONNECTED MAIN POWER WITH BATTERY BACKUP AND WIRED, IN ACCORDANCE WITH S3000.
WATER HEATER: HOT WATER SUPPLY SYSTEM TO COMPLY WITH CLAUSE 3.12.5.6 OF BCA V2.

Application Number
 200963
 Sheet
 6 of 6

FOOTINGS:
 * ALL CONCRETE FOOTINGS AND SLABS TO BE IN ACCORDANCE WITH S.A.A. CODE 2870.1 & ENGINEER'S DESIGN / SPECIFICATIONS.
 * CONTINUOUS DAMPPROOF MEMBRANE UNDER SLAB.
 * DAMPROOF COURSE AT BEARER SEATING LEVELS, STEPPED CAVITY FLASHING WITH WEEP HOLES AT 1200MM CENTERS TO THE EXTERNAL BRICK SKIN AT GROUND FLOOR LEVEL, UNDER WINDOW SILLS AND BRICKWORK ABOVE WINDOWS.
BRICKWORK:
 * MASONRY STONE / BRICKWORK AS SELECTED, GENERALLY 230 X 110 X76 MM BRICKS BONDED IN STRETCHER BOND.
 * MORTAR TO COMPLY WITH THE REQUIREMENTS OF RELEVANT CODES & AUSTRALIAN STANDARDS. COLOUR TO NOT BE WHITE OR OFF WHITE.
 * MASONRY ARTICULATION REQUIRED (VERTICAL ARTICULATION JOINTS) IN ACCORDANCE WITH BCA V2 3.3.5.13
LINTELS FOR BRICKWORK: ALL BEAMS & LINTELS AS PER ENGINEER'S DESIGN / SPECIFICATION & MANUFACTURER'S TABLE.
MATERIAL & FINISHES TO BE CONFIRMED BY THE CLIENT

TIMBER STUD WORK:
 * ALL TIMBER WORK TO COMPLY WITH AS 1684.2 "RESIDENTIAL TIMBER FRAMED CONSTRUCTION"
 * 90X35MM PINE STUDS AT 450 MM CENTERS TO ALL LOAD - BEARING WALLS & AT 600 MM CENTERS TO NON LOAD-BEARING WALLS
 * 90X35MM PINE PLATE & NOGGING AND PROVIDE SECOND 90X45 MM TOP PLATE TO ALL LOAD-BEARING WALLS
 * PROVIDE 90X45 F8 STUDS TO BOTH SIDES OF OPENING CARRYING LINTELS
 * 50X38 MM CEILING BATTENS AT 450 MM CENTERS.
 * 10 MM PLASTER BOARD INTERNAL WALL & CEILING * LINING FIBROUS CEMENT SHEET LINING TO EAVES.

INSULATION SCHEDULE (NCC-2016 PART3.12):
 * R 4.0 CEILING INSULATION + R1.3 BLANKET/SARKING
 * R 2.0 WALL INSULATION + BUILDING WRAPS
 * R 2.0 INSULATION TO INTERNAL WET AREA WALLS
 * R 2.0 FLOOR INSULATION
 * ALL WINDOWS / SLIDERS TO BE DOUBLE GLAZED
 * HEAVY DRAPES WITH PELMETS, WEATHER STRIPS TO EXTERNAL DOORS & SEAL EXHAUST FANS

ROOFING:
 * TRUSSES AT 600mm CENTERS, FIXED TO MANUFACTURERS SPECIFICATIONS.
 * LINTEL SIZE TO TRUSS MANUFACTURERS CHART.
 * METAL FASCIA & GUTTER AS SELECTED.
 * PLASTER INTERNAL WINDOW WALL FRAMING TO ALL ROOMS TO BE COVERED
 * JOINTS BEING BACKED WITH EITHER NOGGINGS OR STUDS AS REQUIRED BY MANUFACTURER
 * ALL ELEMENTS TO BE PROPERLY FINISHED
 * PLASTER BOARD (9.5MM) TO ALL WALLS & CEILING LINES.
 * FIBROUS CEMENT SHEET LINING TO WET AREAS
 * PROVIDE FINISH AS SELECTED. ALL BE FINISHED AT INTERSECTION OF ALL BEAMS AND WALL JUNCTIONS WITH CEILING.
 * PROVIDE ROOF LIGHTS & VENTILATION TO COMPLY WITH THE NCC.
 * ROOF PLUMBING, FLASHING, ETC AS NECESSARY, TO COMPLY WITH RELEVANT AUSTRALIAN STANDARDS.


WATERPROOFING:
 * ALL WET AREAS TO BE WATERPROOFED TO COMPLY WITH THE NCC.
 * EXTERNAL BALCONIES WATERPROOFING AS PER AS 4654 - 2013 AND BCA V2 3.8.4.3

CONDITIONALLY COMPLIES

This document has been assessed against legislation protecting Evoenergy's infrastructure and access to it

The information contained in this application complies with Evoenergy's gas network protection and access requirements subject to the conditions as listed on the Statement of Conditional Compliance.

Note: Construction of unapproved works may result in action being taken to the property owner to remove non-compliant structures and/or the property owner to fund rectification works on Evoenergy's gas network.

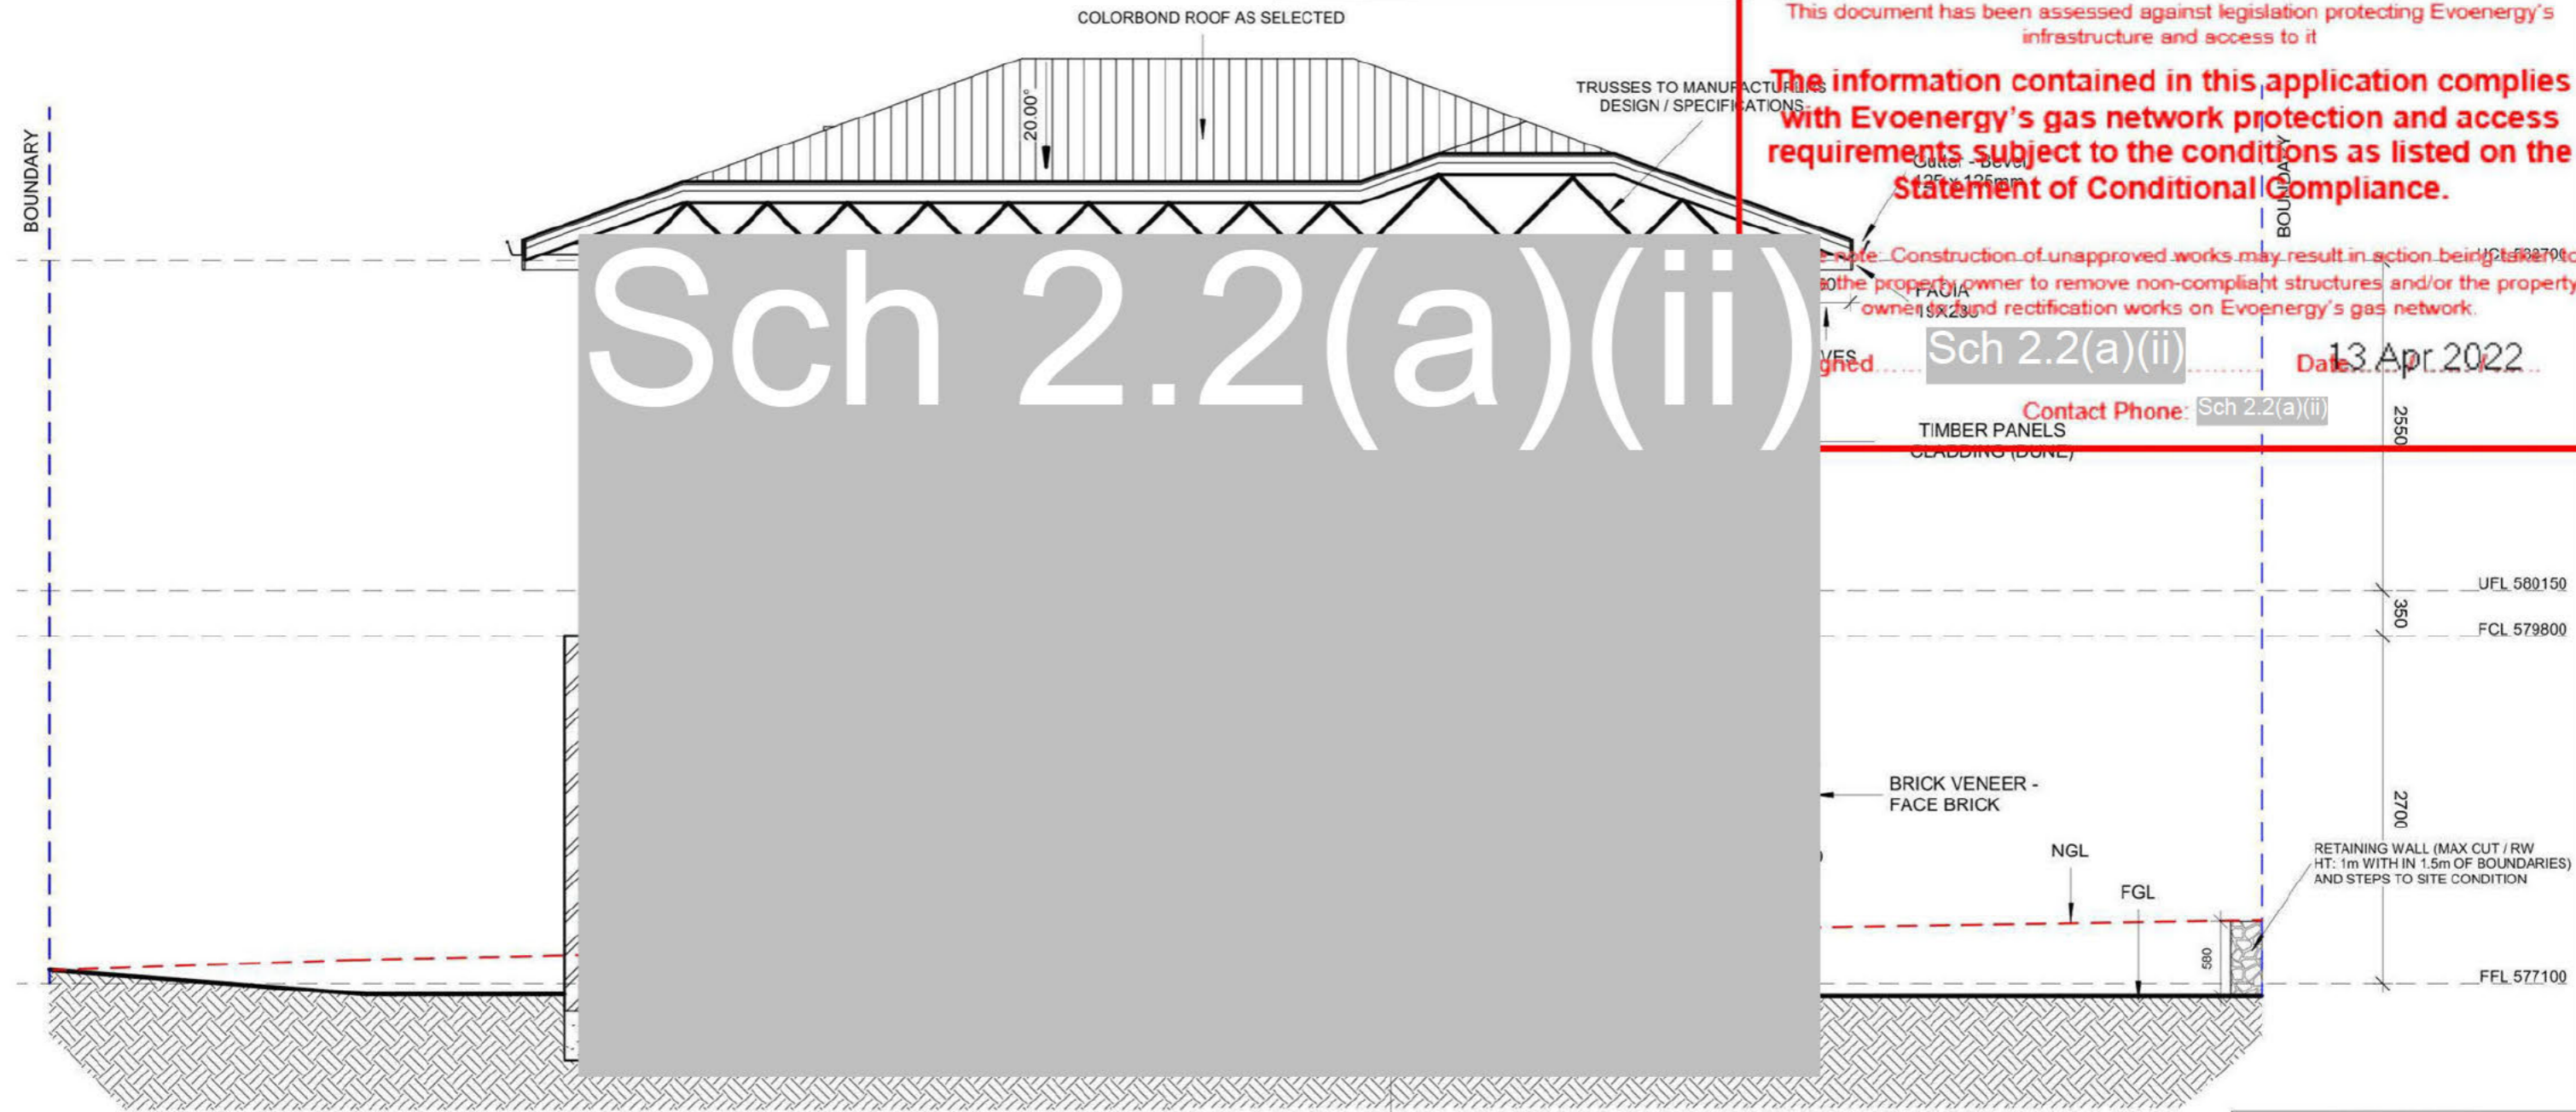

1 Section A
 1 : 50

NOISE AFFECTED BLOCK - TO COMPLY WITH:
 * AS/NZS 2107:2000 - Acoustics - Recommended design sound levels and reverberation times for building interiors (the relevant satisfactory recommended interior design sound level)
 * AS/NZS 3671 - Acoustics - Road Traffic Noise Intrusion Building Siting and Design and Ginninderry Noise Management Plan

WAFFLE POD SLAB TO ENGINEER'S DESIGN


© COPYRIGHT
 Virk Building Design Services
 This plan remains the property of Virk Building Design Services. Should not be COPIED in whole or in part without written permission. Failure of which may result in legal action.

NOTE: The drawings are indicative only and are required to be verified / confirmed by the owner and/or builder and engineer and/or certifier in accordance with the relevant Building Legislation/Regulations, Housing Development Codes, NCC, Australian Standards, etc. Virk BDS will not be held liable / responsible in any form by any party whatsoever for any design or structural component, notation or accuracy of documentation herein. Client / Builder accepts Plans and responsibility once plans are accepted for approvals.


Sch 2.2(a)(ii)
 RESIDENCE
 SUBURB: STRATHNAIRN

SECTION A		FOR APPROVAL	
Project number	211201	A400	
Date	6/3/22		
Drawn by	B.Virk		
Checked by	Client		
Scale		1 : 50 on A3	


DOMESTIC GAS METER LOCATION REFERENCE DRAWINGS

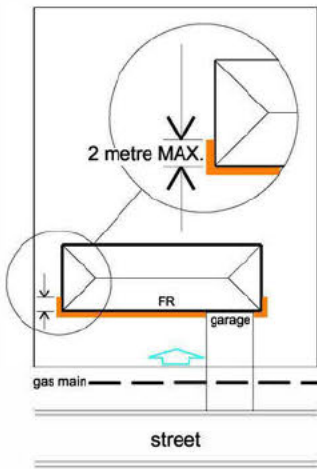


1. TYPICAL SITUATION

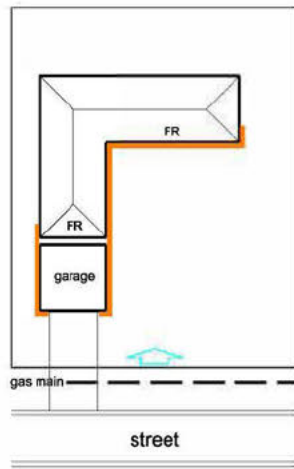


2. DETACHED GARAGE AT FRONT

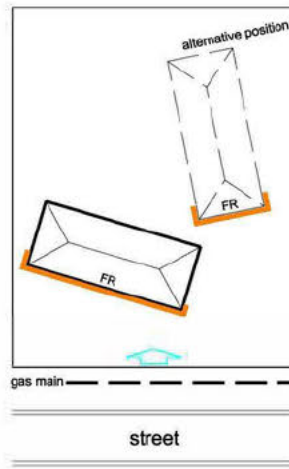


3. ANGLED HOUSE

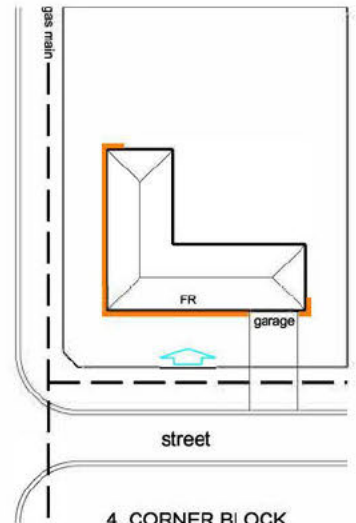


4. CORNER BLOCK
GAS ON TWO SIDES

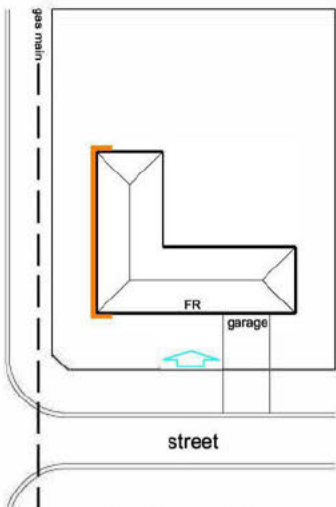


5. CORNER BLOCK
GAS ON ONE SIDE

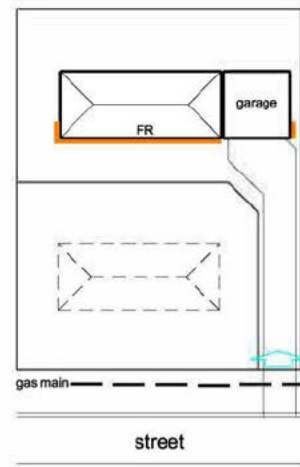


6. BATTLE-AXE BLOCK
GAS AT FRONT

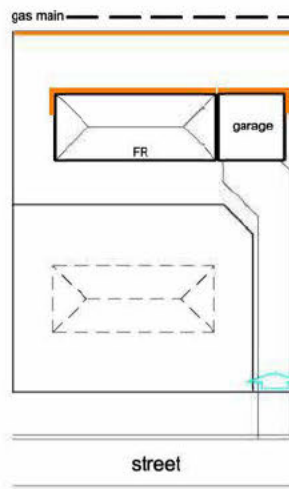


7. BATTLE-AXE BLOCK
GAS AT REAR

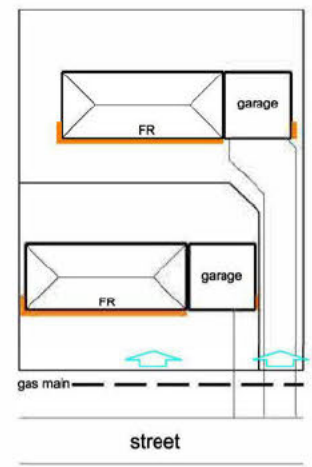


8. DUAL OCCUPANCY

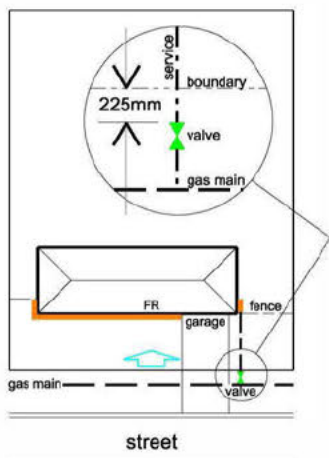

9. METER BEHIND LOCKABLE
GATE, FENCE, OR BARRIER

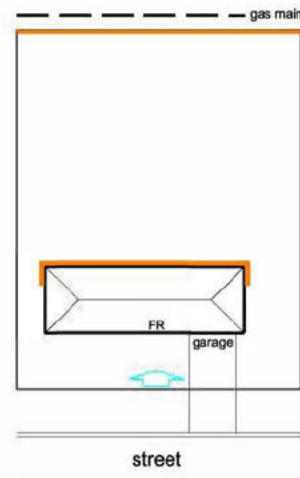

10. MAIN AT REAR OF BLOCK

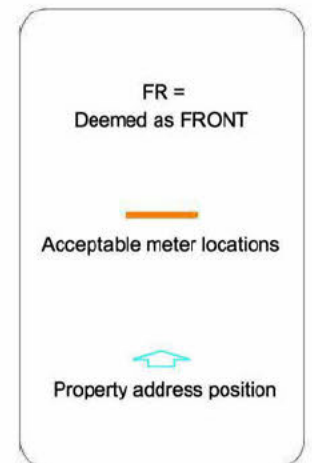

LEGEND:

Gas Networks

Gas Metering Equipment

Prohibited Locations

Metering equipment must not be installed in the following locations unless specifically approved by Evoenergy:

- (a) a bedroom;
- (b) a lift shaft or lift motor room;
- (c) a room specifically intended for electrical switchgear;
- (d) a fire-isolated stairway or passage;
- (e) a fire hydrant duct or hose reel cabinet;
- (f) sprinkler or hydrant pump room;
- (g) near a source of ignition;
- (h) in a position that would obstruct egress from a building;
- (i) in a position where the meter would be subject to physical damage unless adequately protected;
- (j) in an area where excessive temperatures or sudden excessive changes in temperature may occur;
- (k) in an area of excessive vibration;
- (l) in the foundation area under a building;
- (m) in a cavity wall, unless installed in a ventilated enclosure which meets the requirements of Evoenergy, and the cavity is sealed;
- (n) in a position where access for reading or maintenance is restricted;
- (o) in an unventilated position; or
- (p) on the ground, a floor which is frequently wetted or on a floor which contains material which may corrode the meter.

For further information please phone **Sch 2.2(a)(ii)**

‘STATEMENT OF COMPLIANCE’

INFORMATION SHEET

The following requirements must be included in an application that is made under the Planning and Development Act 2007 and/or the Building Act 2004 to Evoenergy when seeking an Electricity & Gas Networks ‘statement of compliance’.

General Requirements for all Development Applications

Provide plans which are to include the following:

- A designated scale, for example 1:500, 1:200, 1:100, 1:50 with Bar Scale
- Proposed and existing structures including basements, driveways, gates, fencing, sheds, rainwater tanks and retaining walls
- Accurately located and dimensioned Evoenergy electricity & gas assets within the block and those located within 5 metres of any boundary of the block (Contact Dial-Before-You-Dig on 1100 for asset maps)
- Dimensioned distance of all structures that are within 5 metres of Evoenergy electricity & gas assets
- Any electricity or gas easements on the block
- Elevations & sections of proposed structures

Specific Requirements for Type of Development

Single Dwelling/Dual Occupancy

- As per General Requirements above

Multiple Unit and High Rise residential

- As per General Requirements above
- Number of units
- Number of bedrooms per unit
- Detailed Maximum Demand Calculation as per AS 3000 (electricity)
- Detailed MJ load of the installation and appliances (gas)
- Net Floor Area of common areas and their use
- Net Floor area of Basement and form of ventilation
- Type of cooking, space & water heating and cooling (gas, electric etc)
- Details of central hot water installation

Non-Residential & Mixed Use

- As per General Requirements above
- Type of development (office, retail, warehouse, industrial etc)
- Timing of the development
- Staging of the development
- Net useable floor areas and their usage
- Net floor area of Basement and form of ventilation
- Type of cooking, space & water heating and cooling (gas, electric etc)
- A list of the load components of the proposed installation with their maximum demands, diversity factors, etc
- Information on load management system (if applicable)
- Duty cycle of any large equipment or duty cycle of an industrial process
- Details of any substantial intermittent and fluctuating loads
- Details of any large single phase loads
- Details of any loads likely to cause substantial harmonics
- Details of any loads which are likely to have poor power factors
- Any seasonal factors, i.e. seasonal variation of load
- Main factors affecting level of demand
- Removal of any part of an existing installation
- Any planned future augmentations or upgrades
- Any on site emergency back up arrangements
- Details of large starting motors and voltage drop limitations
- Detailed Maximum Demand Calculation as per AS 3000 (electricity)
- Detailed MJ load of the installation and appliances (gas)
- Type B gas appliance details
- Number of units
- Number of bedrooms per unit

Demolitions

- Warning: You must contact Evoenergy prior to commencement of demolition works**

For further information

Information about any of the requirements raised in this document can be obtained by contacting the following:

Evoenergy Electricity Networks: 6293 5770

Evoenergy Gas Networks: 6203 0640

Please note: Separate applications are required for Icon water, water & sewerage networks; and to other utility providers such as stormwater or telecommunications.


To lodge an electricity or gas compliance application:

Bring your drawings to the Networks Service Centre; or:


Send electronically to Evoenergy: email: devapp@evoenergy.com.au

The protocols for submitting an electronic application are:

- ❖ Drawings in A3 format (each PDF to be no larger than 2 megabytes in size).
- ❖ Send one email for each application.
- ❖ Each PDF can contain multiple drawings however if you have more than 5 PDFs in an application, please send multiple emails (i.e. part 1, part 2 etc..)

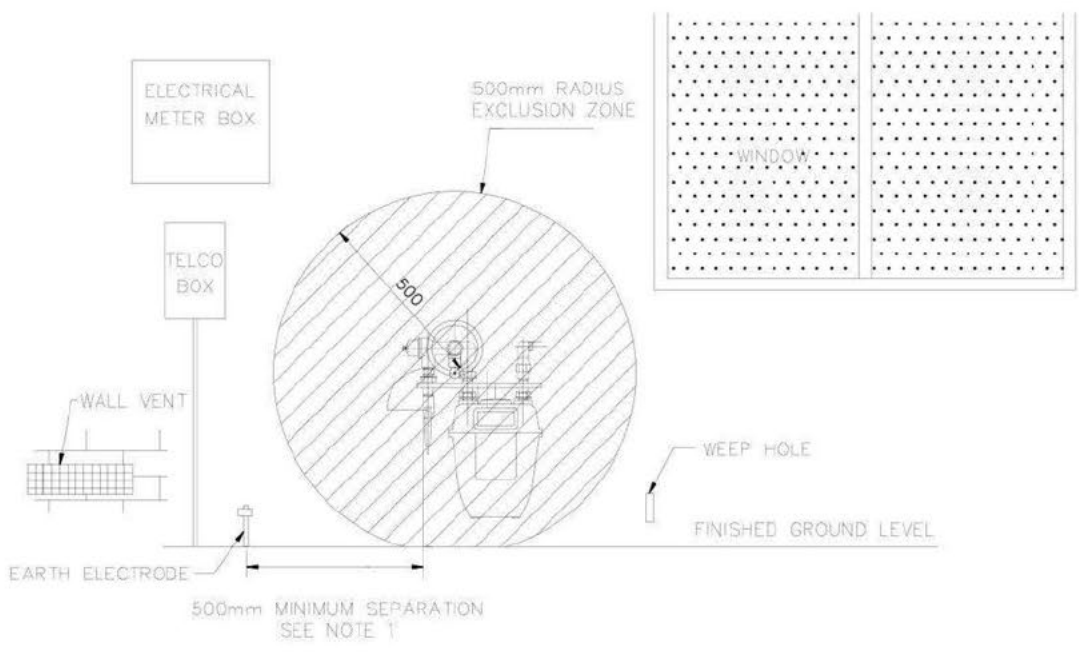


ELEVATION 1

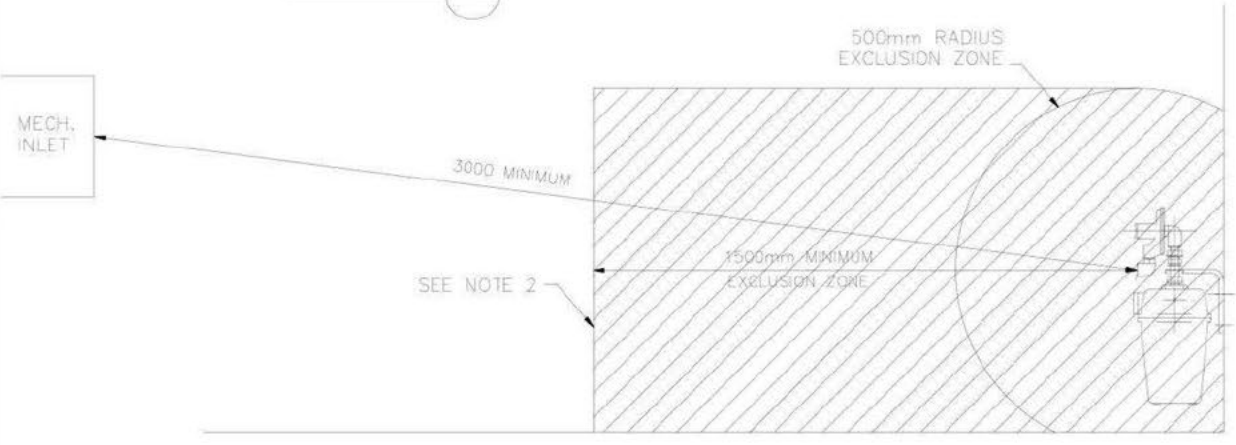


ELEVATION 2

NOTES:

1. SEPARATION FROM EARTHING ELECTRODE TO COPPER RISER SHALL BE 500MM MINIMUM - REFER ASS601 cl 4.10.5
2. OBSTRUCTIONS WITHIN 1.5 METRES OF VENT TERMINAL IN DIRECTION OF DISCHARGE WILL RESULT IN A LARGER EXCLUSION ZONE BEING APPLIED - REFER ASS601 cl 4.7.11
3. DIRECTION OF DISCHARGE OF VENT TERMINAL DETERMINES ORIENTATION OF EXCLUSION ZONE.

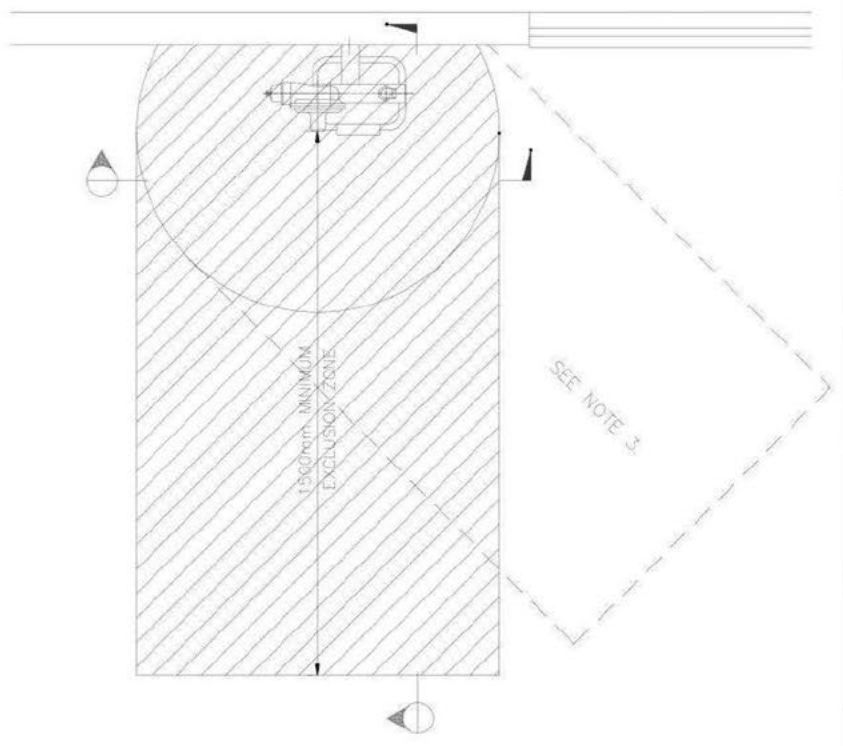

PLAN VIEW

										CLIENT				GAS NETWORKS EXCLUSION ZONE DOMESTIC METER INSTALLATION ASS601 REQUIREMENTS	
1	JEMENA LOGO			Sch 2.2(a)(ii)	25.11.08			Sch 2.2(a)(ii)	25.11.08						
0	ISSUED FOR REVIEW				23.11.05				30.11.05						
SYM	REVISION	PROJECT ENGINEER	DATE	DRAWN	DATE	CHECKED	DATE	PROJECT MANAGER	DATE	CLIENT	DATE				

the 1990s, the number of people who have been employed in the public sector has increased in all countries.

There are a number of reasons for the increase in public sector employment. One reason is that the public sector has become a more important part of the economy. In many countries, the public sector now provides a significant portion of the total output. This has led to an increase in the number of people who are employed in the public sector.

Another reason for the increase in public sector employment is that the public sector has become a more attractive place to work. This is due to a number of factors, including the fact that the public sector often provides better benefits and job security than the private sector. Additionally, the public sector is often seen as a more stable and secure place to work.

There are also a number of other reasons for the increase in public sector employment. For example, the public sector has become a more important part of the economy in many countries. This has led to an increase in the number of people who are employed in the public sector.

Finally, the public sector has become a more important part of the economy in many countries. This has led to an increase in the number of people who are employed in the public sector.

The increase in public sector employment has had a number of effects on the economy. One effect is that it has led to an increase in government spending. This has led to an increase in the size of the public sector and a decrease in the size of the private sector.

Another effect of the increase in public sector employment is that it has led to an increase in government revenue. This is due to the fact that the public sector is a major source of government revenue. As the public sector has grown, so has government revenue.

Finally, the increase in public sector employment has led to an increase in the number of people who are employed in the public sector. This has led to an increase in the size of the public sector and a decrease in the size of the private sector.

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STATEMENT OF CONDITIONAL ACCEPTANCE

Application No: 200963 **Suburb:** Strathnairn

Block/Section [REDACTED]

Applcn Type: Single residential/New Construction Inclusions : Garage

Attached Plans

Strathnairn [REDACTED] Referral Plans.pdf

Conditions of Acceptance

All Icon Water Valves, Hydrants, Meters and Maintenance Holes/Pits must have 24/7 access by Icon Water and Emergency Services. The developer must provide Icon Water 24/7 access to the construction site. The developer is to obtain Icon Water padlocks which must be installed in a daisy chain fashion at each entry and exit point of the construction site. No stockpiles, Temporary structures or equipment is to be located within the pipe protection envelope.

Icon Water assets shall be protected for the duration of the construction works from short term load shedding from construction machinery or vibration and groundwater ingress or infiltration. Any damage to Icon assets resulting from the construction works shall be repaired by Icon Water at the contractors expense. Access to Icon Water's assets including sewer structures, manholes, hydrants and valves is to be maintained for the duration of the construction works.

Lessee must install private sewer riser at the sewer tie to ground level as part of this approval

Location of the water meter is to be clear of driveways and footpaths with a 1m radius unhindered access maintained. If required, relocation of the water service is to be undertaken by Icon Water at the lessee's cost. Relocations further than 1.5m laterally require a Hydraulic plan to be approved by Icon prior to applying for the relocation. Evidence of this being performed and constructed is to be forwarded to Icon Water before the certificate of occupation is issued.

Other

Maintain water tie clearance and sewer tie protection zone (clear of driveway, landscaping and structures including mailbox and courtyard/retaining walls)

Please Note:

- ❖ Separate applications are required for ActewAGL electricity and gas networks.
- ❖ Any failure to accurately show existing or proposed structures may result in damage and costs for which the property owner will be liable. Damage to network assets must be reported to Icon Water.
- ❖ Utility conditions may also apply to minor structures and landscaping works that may not have been depicted in this document. Consultation with Icon Water is advised if such structures and landscaping are planned.
- ❖ Icon Water recommends setbacks provided for equipment access to water or sewerage network assets are kept free of obstruction by the property owner.
- ❖ Construction of works without the approval of Icon Water may result in connection to Icon Water's water and sewerage networks being denied and /or action being taken to require the property owner to remove non-compliant services (e.g. sanitary drains) or structures.

WARNING

Failure to comply with these conditions is likely to result in interference with an Icon Water sewer or water asset. Part 5 of the Utilities (Technical Regulation) Act 2014 applies, which indicates a person who interferes with a utility asset may be subject to prosecution. The current maximum penalty is 200 penalty units, imprisonment for two years, or both. In addition the land-holder can be ordered at their expense to stop the interference, which may involve removal of the building work or that part of the building work that is causing, or is likely to cause interference.

Comments:**Signed**

Sch 2.2(a)(ii)

Date


19 Apr 2022

For further information please phone Icon Water 6248 3111.

icon
 IMPORTANCE OF REGULATIONS TAKES PRECEDENCE OVER THE DRAWINGS. DETAIL DRAWINGS TAKE PRECEDENCE OVER GENERAL DRAWINGS.
 Application Number: 211201
 Stage: 1
 Date: 6/3/2022

DO NOT SCALE DRAWINGS - ALL DIMENSIONS IN "mm".
 *BUILDER TO VERIFY ALL DIMENSIONS ON SITE PRIOR TO COMMENCEMENT OF CONSTRUCTION WORKS, PRODUCE SHOP DRAWINGS OR FABRICATING COMPONENTS.
 *BUILDER TO CHECK DOORS/WINDOWS DIMENSIONS BEFORE ORDERING ON FLOOR PLAN AND ELEVATIONS.
 *ALUMINIUM FRAMED DOORS/WINDOWS WITH OPENING STYLES IN ACCORDANCE WITH ELEVATIONS AND FROM APPROVED MANUFACTURER UNO.
 *LINTELS TO TRUSS MANUFACTURERS TABLES, ROOF TRUSSES TO MANUFACTURER'S SPECIFICATION.
 *ALL CONSTRUCTION WORK TO BE DONE IN ACCORDANCE WITH BCA AND RELEVANT AUSTRALIAN STANDARDS AND DEVELOPMENT CODES.
 *TERMITE PROTECTION TO COMPLY WITH AS1694 'PHYSICAL BARRIERS' & AS3660 'APPENDIX D' AND TO ACT BUILDING CONTROL BUILDING NOTE NO3, FRAMING TO AS1684 'NATIONAL TIMBER FRAMING CODE' AND SUPPLIMENTS, HARDWOOD TO AS.2796, ELECTRICAL TO AS.3000, PLUMBING TO AS3500, CONCRETE TO AS.3600, BRICKWORK TO AS.3700, 'SAA MASONRY CODE' AND AS.1640 'SAA BRICKWORK CODE', STRUCTURAL STEEL TO AS.1170 & AS.4100, WET SEAL TO AS.3740 AND .
 *SMOKE ALARMS CONNECTED TO MAINS POWER SUPPLY, WITH BATTERY BACKUP, ARE TO BE INSTALLED IN ACCORDANCE WITH AS3786.

*BLOCK BOUNDARIES, CONTOURS, SERVICES AND EASEMENTS TO BE VERIFIED ON SITE PRIOR TO CONSTRUCTION.
 *CONFIRM ALL LEVELS AND CONTOURS ON SITE PRIOR TO COMMENCEMENT OF CONSTRUCTION. BUILDER IS RESPONSIBLE TO ENSURE ALL INFORMATION SHOWN HERE REGARDING LEVELS ARE ACCURATE AND REPRESENTS EXISTING ON SITE LEVELS.
 *THE FFLs ARE SUBJECT TO CHANGE AND ARE UP TO BUILDERS DISCRETION TO BE VERIFIED ON SITE, MAXIMUM CHANGE UNDER 340 mm, TO BE CONFIRMED BY CERTIFIER.
 *LOCATION OF CUTS ARE INDICATIVE ONLY AND TO BE VERIFIED ON SITE. THEREFORE, ALL CUTS & FFL TO BE VERIFIED ON SITE BY A REGISTERED SURVEYOR.
 *0.3 M CUT APPROX AT LINE OF HOUSE - SITE TO BE LEVELED / GRADED TO ALLOW FOR SURFACE DRAINAGE AS PER BCA.
 *RETAINING WALL TO BE BUILT ENSURING DRAINAGE AS PER RELEVANT CODES/BCA V2. HEIGHTS AND ALL LEVELS TO SUIT SITE CONDITIONS. FINAL HEIGHTS TO BE CONFIRMED BY BUILDER ON SITE.
 *SEDIMENT & EROSION CONTROL TO COMPLY WITHIN THE BEST PRACTICE GUIDELINES - PREVENT SOULUTION FOR RESIDENTIAL BUILDING SITES MARCH 2006 AND ENVIRONMENT PROTECTION GUIDELINES FOR CONSTRUCTION AND LAND DEVELOPMENT IN THE ACT, MARCH 2011.
 *BUILDER TO PROVIDE CRUSHED GRANITE OR AGGREGATES AT ACCESS POINT TO SITE DURING CONSTRUCTION

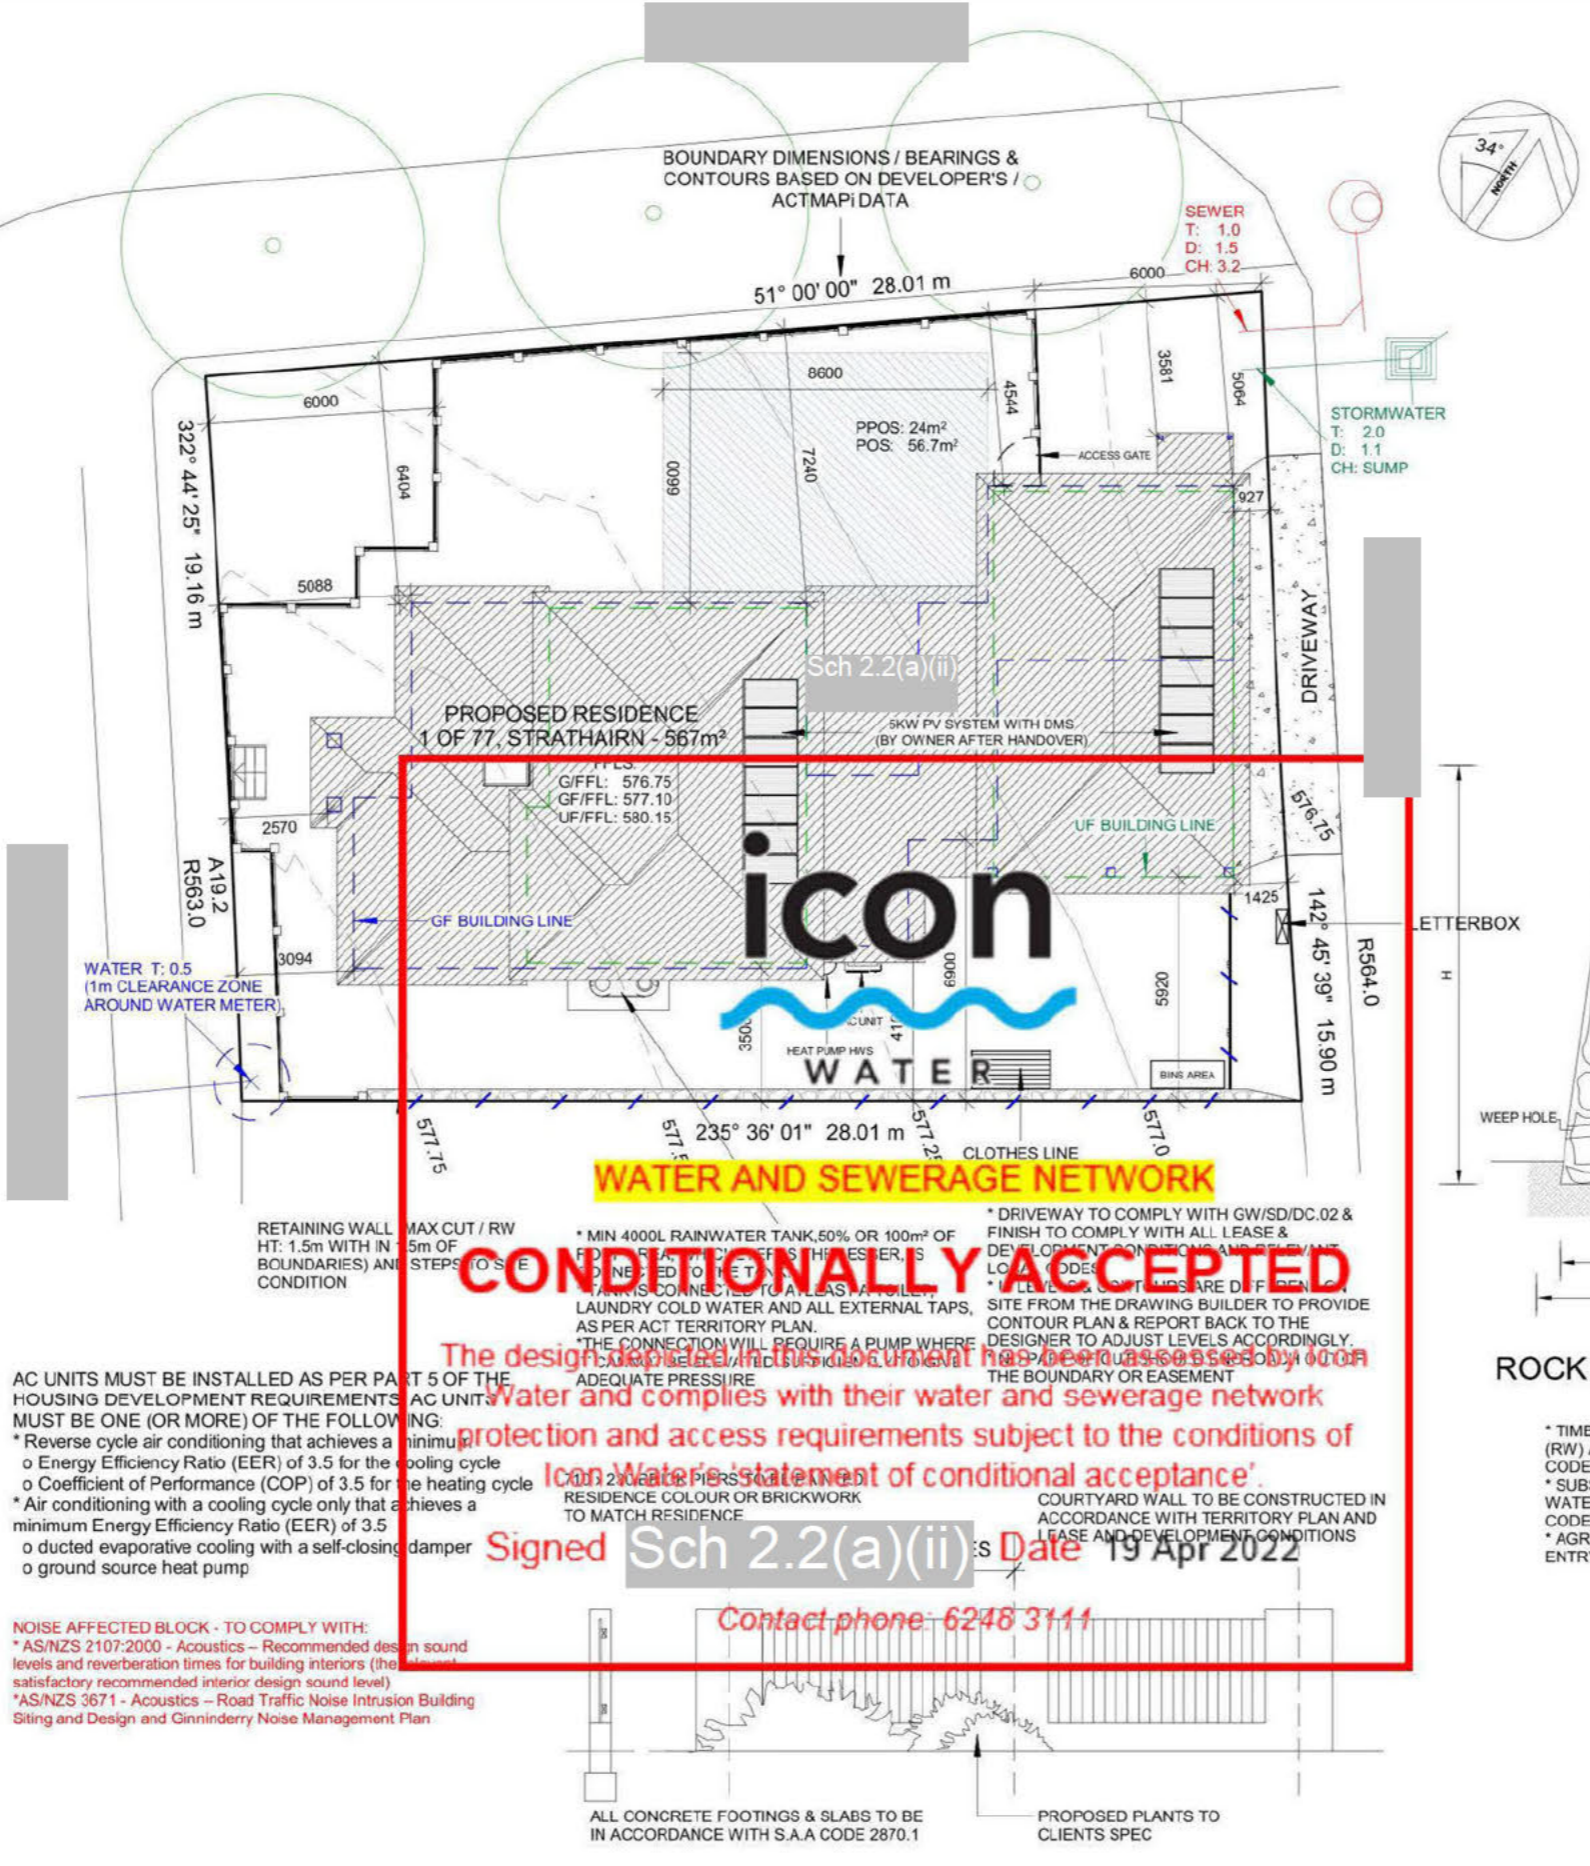

IMPORTANT BLOCK INFORMATION
 BLOCK SIZE: 567 m² (RZ3)
 OPEN SPACE MIN: 290.2 m² (60% - 50.0m²)
 MAX GFA (50%): 283.5 m²
 PPOS: 24 m²
 POS: 56.7m² (6m FOR AN AREA NOT LESS THAN 10% OF THE BLOCK AREA AND TOTAL AREA OF HARD LANDSCAPE NOT TO EXCEED 50% AREA OF P.O.S.)

SITE AREA	
OPEN SPACE	404.38 m²
Footprint	133.25 m²
Total	537.63 m²

Construction Area		
Number	Name	Area
1	Sch 2.2(a)(ii)	132.87 m²
2		61.79 m²
3		58.42 m²
4		29.74 m²
5		36.01 m²
6		13.38 m²
7		4.05 m²
8		2.80 m²
9		4.40 m²
10		6.12 m²
Grand total		349.58 m²

CONDITIONALLY ACCEPTED

The design depicted in this document has been assessed by icon Water and complies with their water and sewerage network protection and access requirements subject to the conditions of icon Water's statement of conditional acceptance'.
 Signed Sch 2.2(a)(ii) Date 19 Apr 2022
 Contact phone: 6248 3111

AC UNITS MUST BE INSTALLED AS PER PART 5 OF THE HOUSING DEVELOPMENT REQUIREMENTS. AC UNITS MUST BE ONE (OR MORE) OF THE FOLLOWING:
 * Reverse cycle air conditioning that achieves a minimum:
 o Energy Efficiency Ratio (EER) of 3.5 for the cooling cycle
 o Coefficient of Performance (COP) of 3.5 for the heating cycle
 * Air conditioning with a cooling cycle only that achieves a minimum Energy Efficiency Ratio (EER) of 3.5
 o ducted evaporative cooling with a self-closing damper
 o ground source heat pump

NOISE AFFECTED BLOCK - TO COMPLY WITH:
 * AS/NZS 2107:2000 - Acoustics - Recommended design sound levels and reverberation times for building interiors (the minimum satisfactory recommended interior design sound level)
 * AS/NZS 3671 - Acoustics - Road Traffic Noise Intrusion Building Siting and Design and Ginninderry Noise Management Plan

ALL CONCRETE FOOTINGS & SLABS TO BE IN ACCORDANCE WITH S.A.A CODE 2870.1
 PROPOSED PLANTS TO CLIENTS SPEC

1. SITE PLAN
 1 : 200

Virk Building Design Services
 Email: virk.bds@gmail.com Mob: 0425677755


NOTE: The drawings are indicative only and are required to be verified / confirmed by the owner and/or builder and engineer and/or certifier in accordance with the relevant Building Legislation/Regulations, Housing Development Codes, NCC, Australian Standards, etc.
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Sch 2.2(a)(ii)
RESIDENCE
 SUBURB: STRATHNAIRN

SITE PLAN		FOR APPROVAL	
Project number	211201	A100	
Date	6/3/22		
Drawn by	B.Virk		
Checked by	Client		
Scale	1 : 200	on A3	


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SITE AREA	
OPEN SPACE	404.38 m ²
Footprint	133.25 m ²
Total	537.63 m ²

GFA		
Number	Name	Area
1	Sch 2.2(a)(ii)	132.87 m ²
2		61.79 m ²
3		58.42 m ²
4		29.74 m ²
Grand total		282.83 m ²

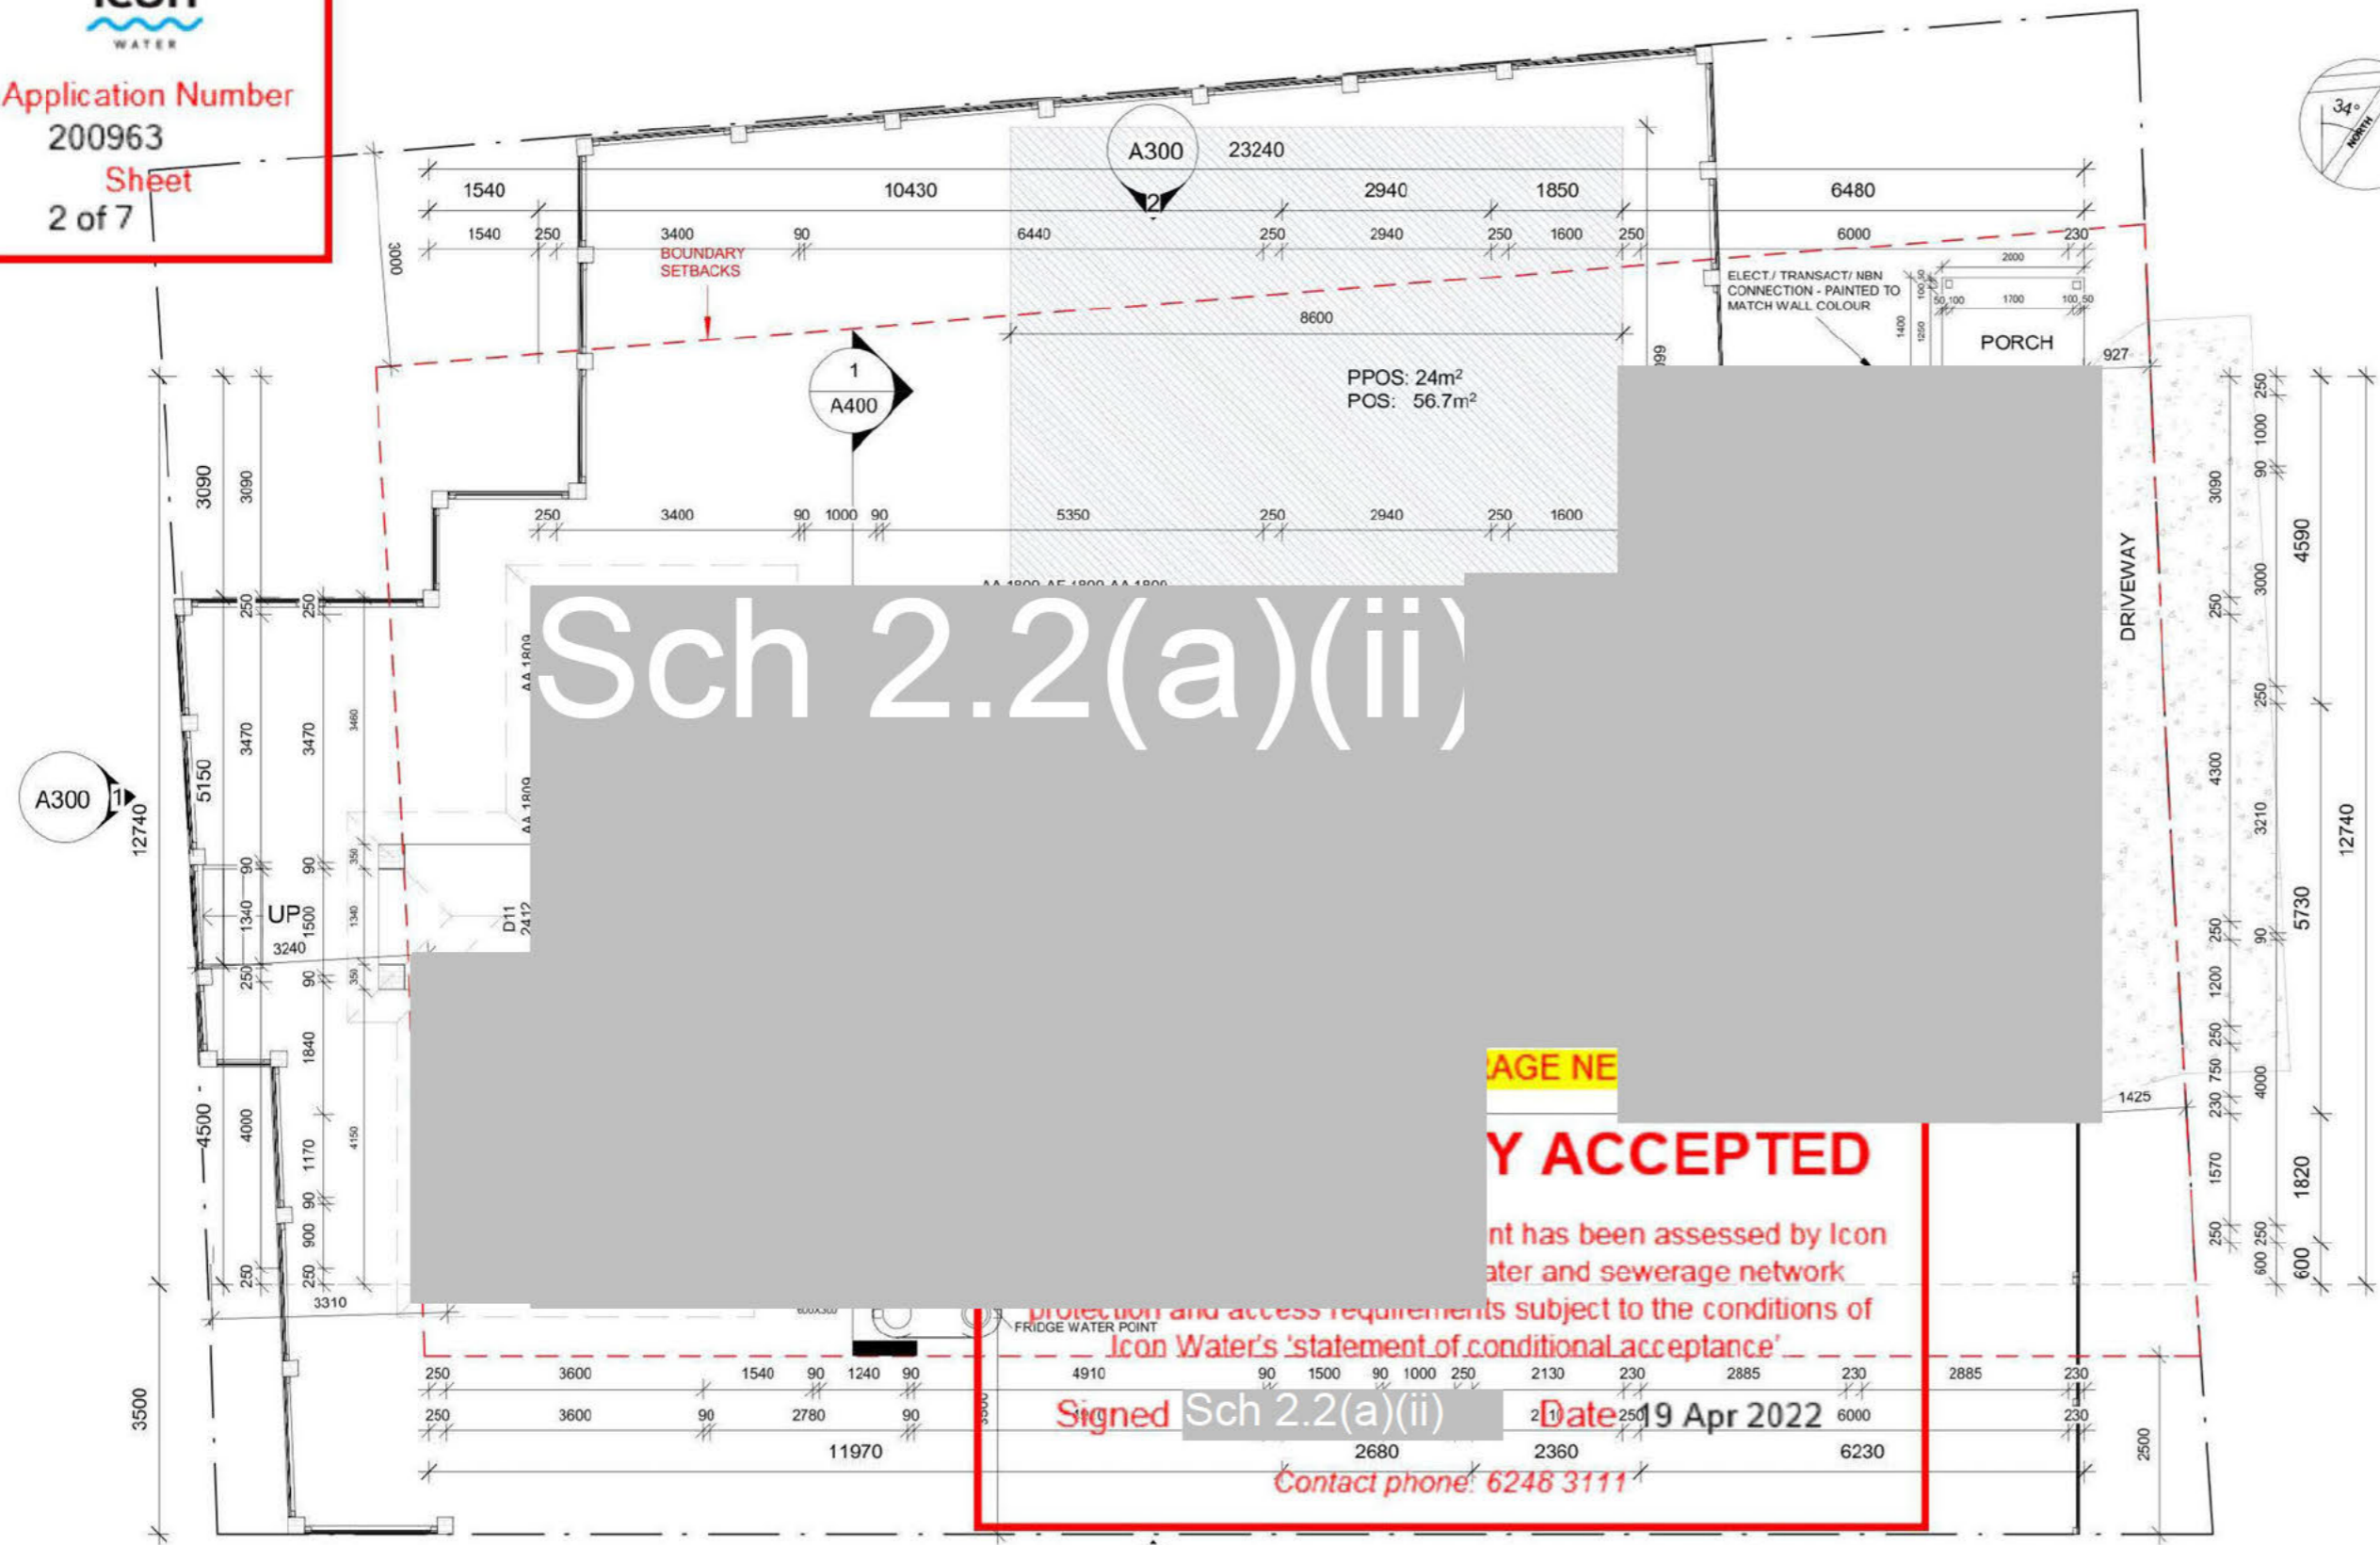

Construction Area		
Number	Name	Area
1	Sch 2.2(a)(ii)	132.87 m ²
2		61.79 m ²
3		58.42 m ²
4		29.74 m ²
5		36.01 m ²
6		13.38 m ²
7		4.05 m ²
8		2.80 m ²
9		4.40 m ²
10		6.12 m ²
Grand total		349.58 m ²

2. GROUND FLOOR PLAN

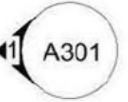1 : 100

- ALL MECHANICAL VENTILATION TO BE DUCTED DIRECTLY TO OUTSIDE ROOF SPACE IN ACCORDANCE WITH BCA V2 PART 3.8.7.4
- FLOW RATE OF MECHANICAL SYSTEMS TO COMPLY WITH BCA V2 3.8.7.3
- UPPER FLOOR WINDOWS TO BE RESTRICTED IN ACCORDANCE WITH BCA V2 3.9.2.6
- ALL WINDOWS AND SLIDERS AS PER AS2047 & AS1288 AND DOUBLE GLAZED
- FLOOR DRAINS IN ALL WET AREAS / BLACONY / OUTDOOR AS REQUIRED
- ALL INTERNAL DOORS HEIGHT: 2040mm

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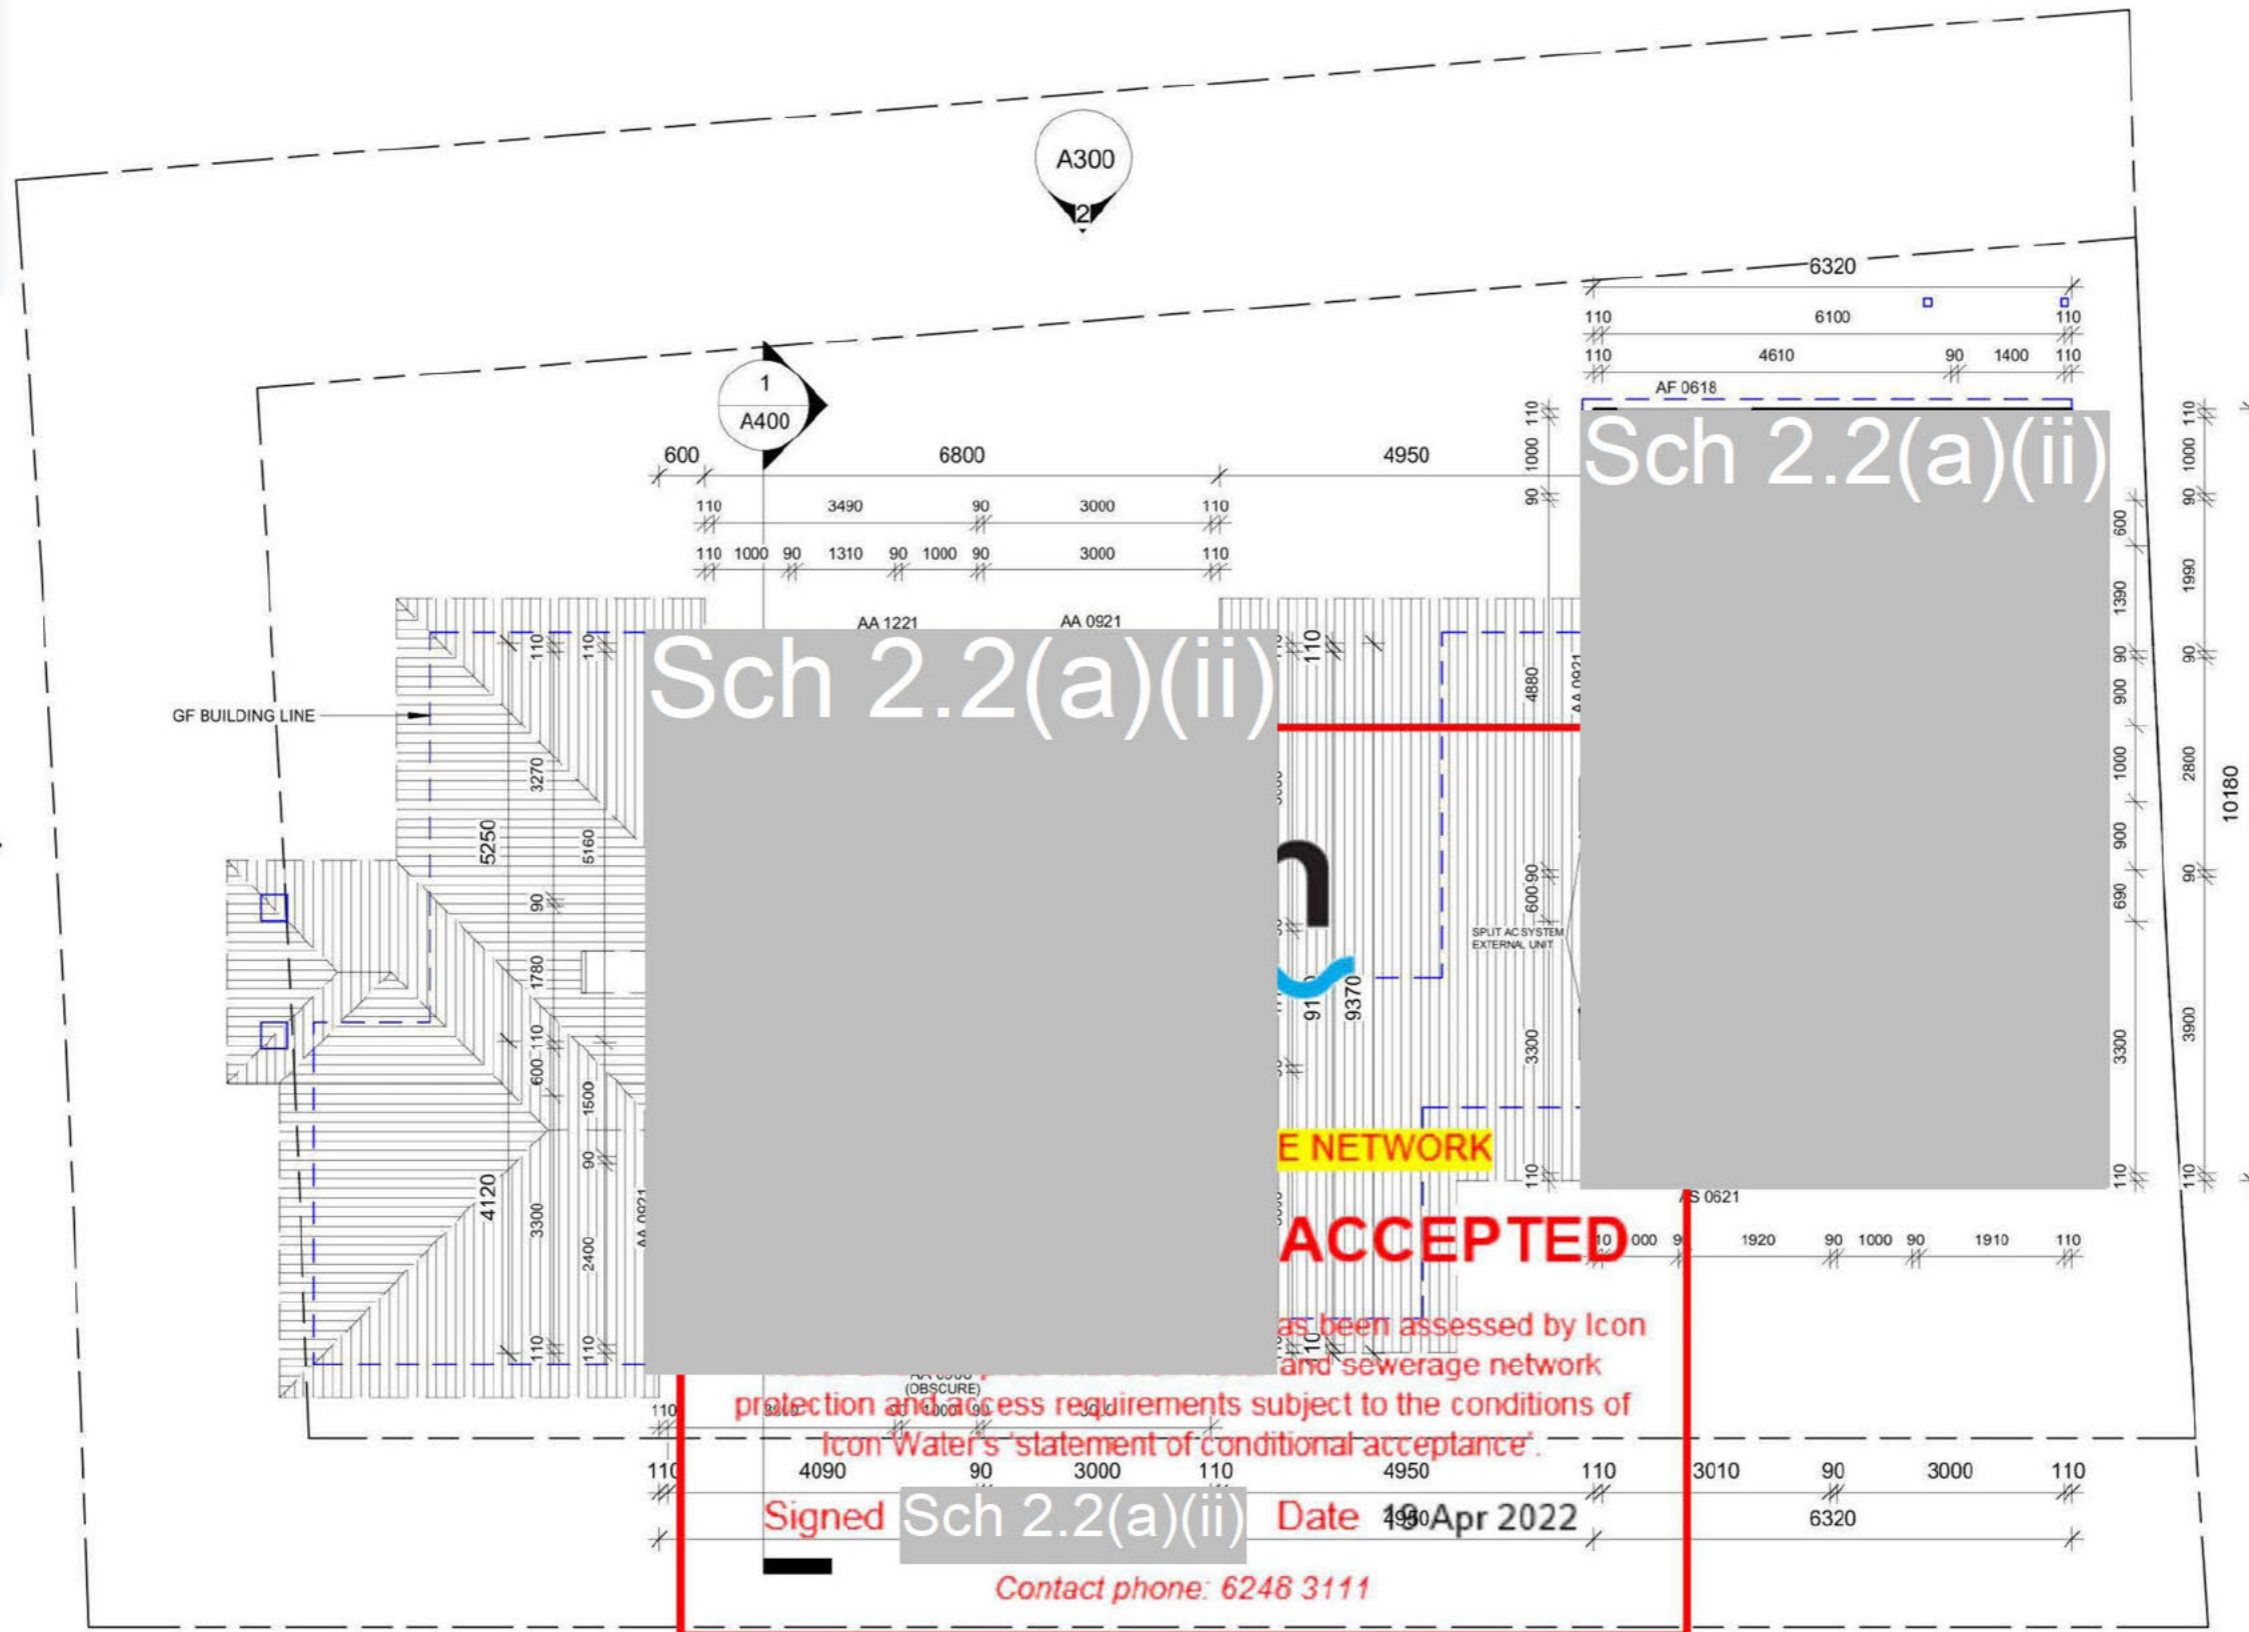
Email: virk.bds@gmail.com Mob: 0425677755

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Sch 2.2(a)(ii)
RESIDENCE
SUBURB: STRATHNAIRN

GROUND FLOOR PLAN FOR APPROVAL

Project number	211201	A200
Date	6/3/22	
Drawn by	B.Virk	
Checked by	Client	
Scale	1 : 100	on A3



3. UPPER FLOOR PLAN

1 : 100

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Sch 2.2(a)(ii)

RESIDENCE

SUBURB: STRATHNAIRN

UPPER FLOOR PLAN FOR APPROVAL

Project number	211201	A201
Date	6/3/22	
Drawn by	B.Virk	
Checked by	Client	
Scale		1 : 100 on A3

BUILDING ENVELOPE / SOLAR ACCESS



1 Elevation 1
1 : 100



2 Elevation 2
1 : 100

icon
WATER

WATER AND SEWERAGE NETWORK

CONDITIONALLY ACCEPTED

The design depicted in this document has been assessed by Icon Water and complies with their water and sewerage network protection and access requirements subject to the conditions of Icon Water's 'statement of conditional acceptance'.

Signed Sch 2.2(a)(ii) Date 19 Apr 2022

Contact phone: 6248 3111

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Sch 2.2(a)(ii)
RESIDENCE
SUBURB: STRATHNAIRN

ELEVATION 1&2		FOR APPROVAL	
Project number	211201	A300	
Date	6/3/22		
Drawn by	B.Virk		
Checked by	Client	Scale	1 : 100 on A3


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BUILDING ENVELOPE / SOLAR ACCESS

1 Elevation 3
1 : 100



2 Elevation 4
1 : 100

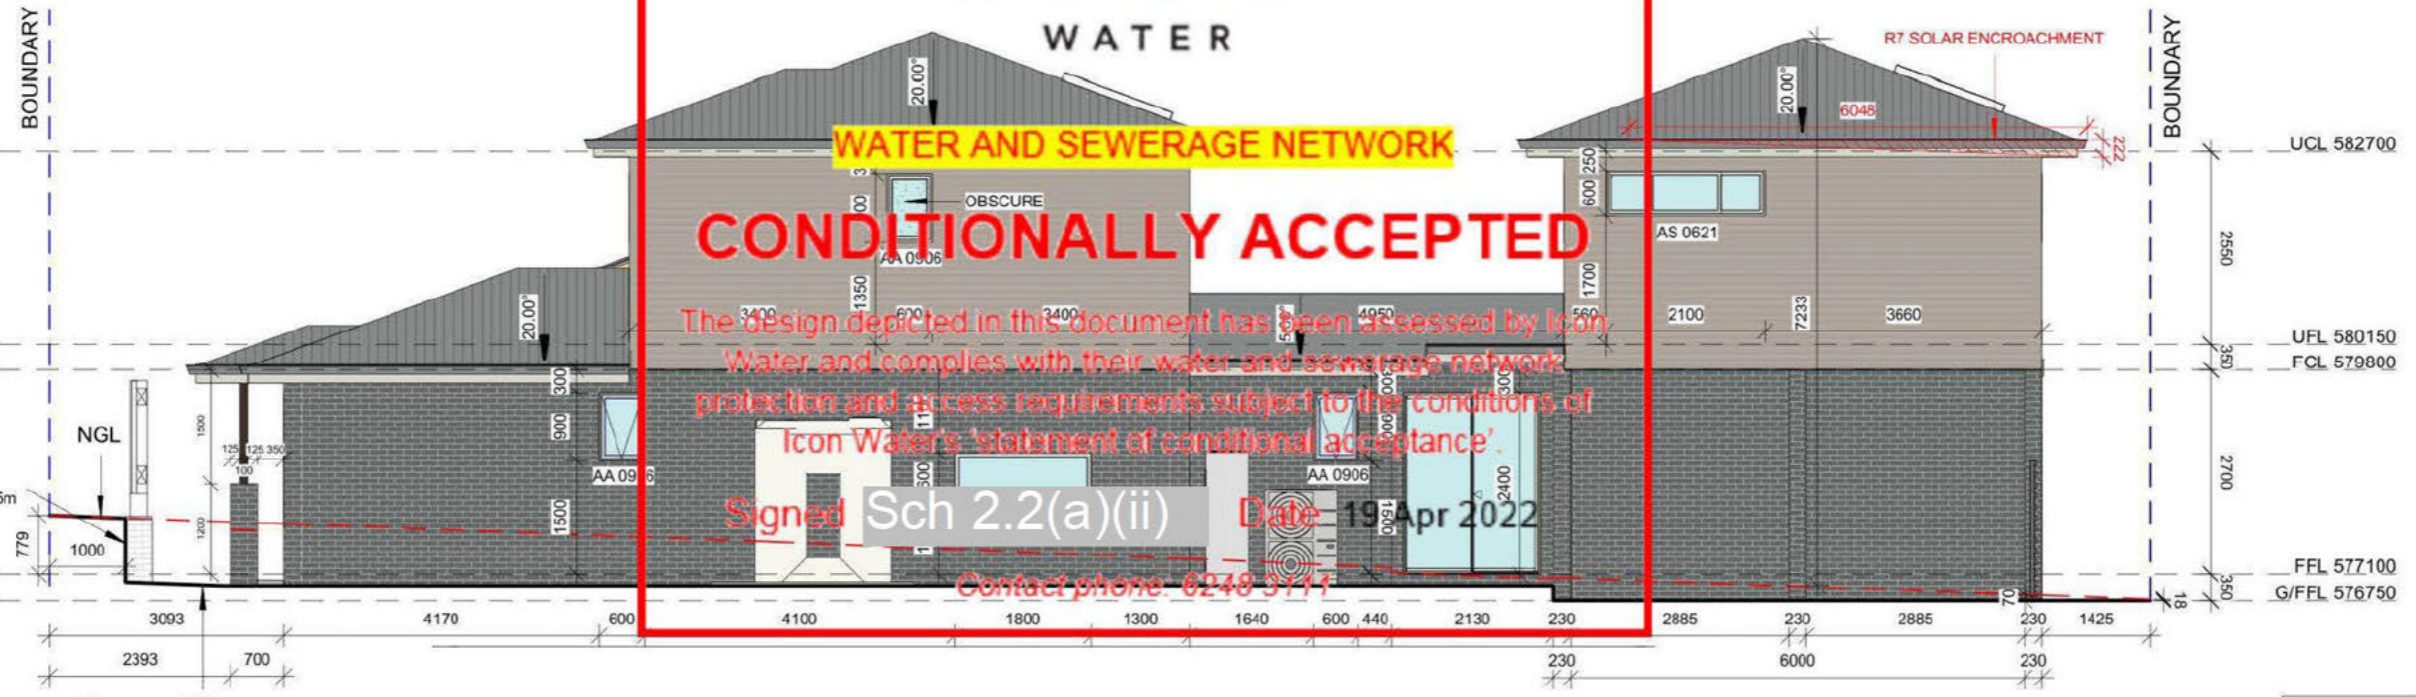

WATER AND SEWERAGE NETWORK
CONDITIONALLY ACCEPTED
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Signed Sch 2.2(a)(ii) Date 19 Apr 2022
Contact phone: 6248 3111

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Sch 2.2(a)(ii)
RESIDENCE
SUBURB: STRATHNAIRN

ELEVATION 3&4		FOR APPROVAL	
Project number	211201	A301	
Date	6/3/22		
Drawn by	B.Virk		
Checked by	Client	Scale	1 : 100 on A3

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Application Number

200905

6 of 6

DOORS:
 * ALL MATERIALS, FIXING, FRAMES, GLAZING, FLY SCREENS, ETC TO CONFORM TO AS/NZS 1288 / RELEVANT CODES / BEST TRADE PRACTICES.
 * ENSURE CORRECT OPERATION OF WINDOWS, SLIDING DOORS, ENSURING CORRECT PROTECTION FROM THE WATER.
 * ALL ALUMINIUM DOORS AND WINDOWS TO BE ALUMINIUM IMPROVED.

ELECTRICAL:
 * ALL ELECTRICAL MATERIALS, CONNECTIONS AND INSTALLATION FOR FULL FACTORY OPERATION IN ACCORDANCE WITH AUTHORITY REQUIREMENTS, RELEVANT CODES / REGULATIONS AND AS DIRECTED BY THE BUILDER.
 * DOWNLIGHTS TO COMPLY WITH CLAUSE 3.12.5.5 OF BCA.
 * DOWNLIGHTS INSTALLED WITH APPROVED NON-VENTILATED COVER OR SHIELD ALLOWING INSTALLATION OF INSULATION TO SIDES AND TOP.
 * SMOKE ALARMS ARE TO BE INSTALLED IN ACCORDANCE WITH BCA , BUILDING NOTE 19 & TO COMPLY WITH AS3786. SMOKE ALARMS TO BE CONNECTED MAIN POWER WIRING SYSTEM AND WIRING, IN ACCORDANCE WITH AS3000.

WATER HEATER IN HOT WATER SUPPLY SYSTEM TO COMPLY WITH CLAUSE 3.12.5.6 OF BCA V2.

FOOTINGS:
 * ALL CONCRETE FOOTINGS AND SLABS TO BE IN ACCORDANCE WITH S.A.A. CODE 2870.1 & ENGINEER'S DESIGN / SPECIFICATIONS.
 * CONTINUOUS DAMPPROOF MEMBRANE UNDER SLAB.
 * DAMPROOF COURSE AT BEARER SEATING LEVELS, STEPPED CAVITY FLASHING WITH WEEP HOLES AT 1200MM CENTERS TO THE EXTERNAL BRICK SKIN AT GROUND FLOOR LEVEL, UNDER WINDOW SILLS AND BRICKWORK ABOVE WINDOWS.

BRICKWORK:
 * MASONRY STONE / BRICKWORK AS SELECTED, GENERALLY 230 X 110 X76 MM BRICKS BONDED IN STRETCHER BOND.
 * MORTAR TO COMPLY WITH THE REQUIREMENTS OF RELEVANT CODES & AUSTRALIAN STANDARDS. COLOUR TO NOT BE WHITE OR OFF WHITE.
 * MASONRY ARTICULATION REQUIRED (VERTICAL ARTICULATION JOINTS) IN ACCORDANCE WITH BCA V2 3.3.5.13

LINTELS FOR BRICKWORK. ALL BEAMS & LINTELS AS PER ENGINEER'S DESIGN / SPECIFICATION & MANUFACTURER'S TABLE.


MATERIAL & FINISHES TO BE CONFIRMED BY THE CLIENT

TIMBER STUD WORK:
 * ALL TIMBER WORK TO COMPLY WITH AS 1684.2 "RESIDENTIAL TIMBER FRAMED CONSTRUCTION"
 * 90X35MM PINE STUDS AT 450 MM CENTERS TO ALL LOAD - BEARING WALLS & AT 600 MM CENTERS TO NON LOAD-BEARING WALLS
 * 90X35MM PINE PLATE & NOGGING AND PROVIDE SECOND 90X45 MM TOP PLATE TO ALL LOAD-BEARING WALLS
 * PROVIDE 90X45 F8 STUDS TO BOTH SIDES OF OPENING CARRYING LINTELS
 * 50X38 MM CEILING BATTENS AT 450 MM CENTERS.
 * 10 MM PLASTER BOARD INTERNAL WALL & CEILING *LINING FIBROUS CEMENT SHEET LINING TO EAVES.

INSULATION SCHEDULE (NCC-2016 PART3.12):
 * R 4.0 CEILING INSULATION + R1.3 BLANKET/SARKING
 * R 2.0 WALL INSULATION + BUILDING WRAPS
 * R 2.0 INSULATION TO INTERNAL WET AREA WALLS
 * R 2.0 FLOOR INSULATION
 * ALL WINDOWS / SLIDERS TO BE DOUBLE GLAZED
 * HEAVY DRAPES WITH PELMETS, WEATHER STRIPS TO EXTERNAL DOORS & SEAL EXHAUST FANS

ROOFING:
 * TRUSSES AT 600mm CENTERS, FIXED TO MANUFACTURERS SPECIFICATIONS.
 * LINTEL SIZE TO TRUSS MANUFACTURERS CHART.
 * METAL FASCIA & GUTTER AS SELECTED.
 * PLASTER INTERNAL LININGS WALL FRAMING TO ALL ROOMS TO BE COVERED JOINTS BEING BACKED WITH EITHER NOGGINGS OR STUDS AS REQUIRED BY MANUFACTURER.
 * ALL ELEMENTS TO BE SECURELY FIXED.
 * PLASTER BOARD (MIN 10MM THICK) WALL & CEILING LINING.
 * FIBROUS CEMENT SHEET WALL LINING TO WET AREAS.
 * PROVIDE CORNICE, AS SELECTED SHALL BE FIXED AT INTERSECTION OF ALL BEAMS AND WALL JUNCTIONS WITH CEILINGS.
 * PROVIDE ROOF LIGHTS & VENTILATION TO COMPLY WITH THE NCC.
 * ROOF PLUMBING, FLASHING, ETC AS NECESSARY, TO COMPLY WITH RELEVANT AUSTRALIAN STANDARDS.

WATERPROOFING:
 * WET AREAS WATERPROOFING: AS 3740 - 2010 AND AMDT 1 - 2012, AND BCA V2: 3.8.1.2
 * EXTERNAL / BALCONIES WATERPROOFING: AS 4654 - 2012 AND BCA V2: 3.8.1.3

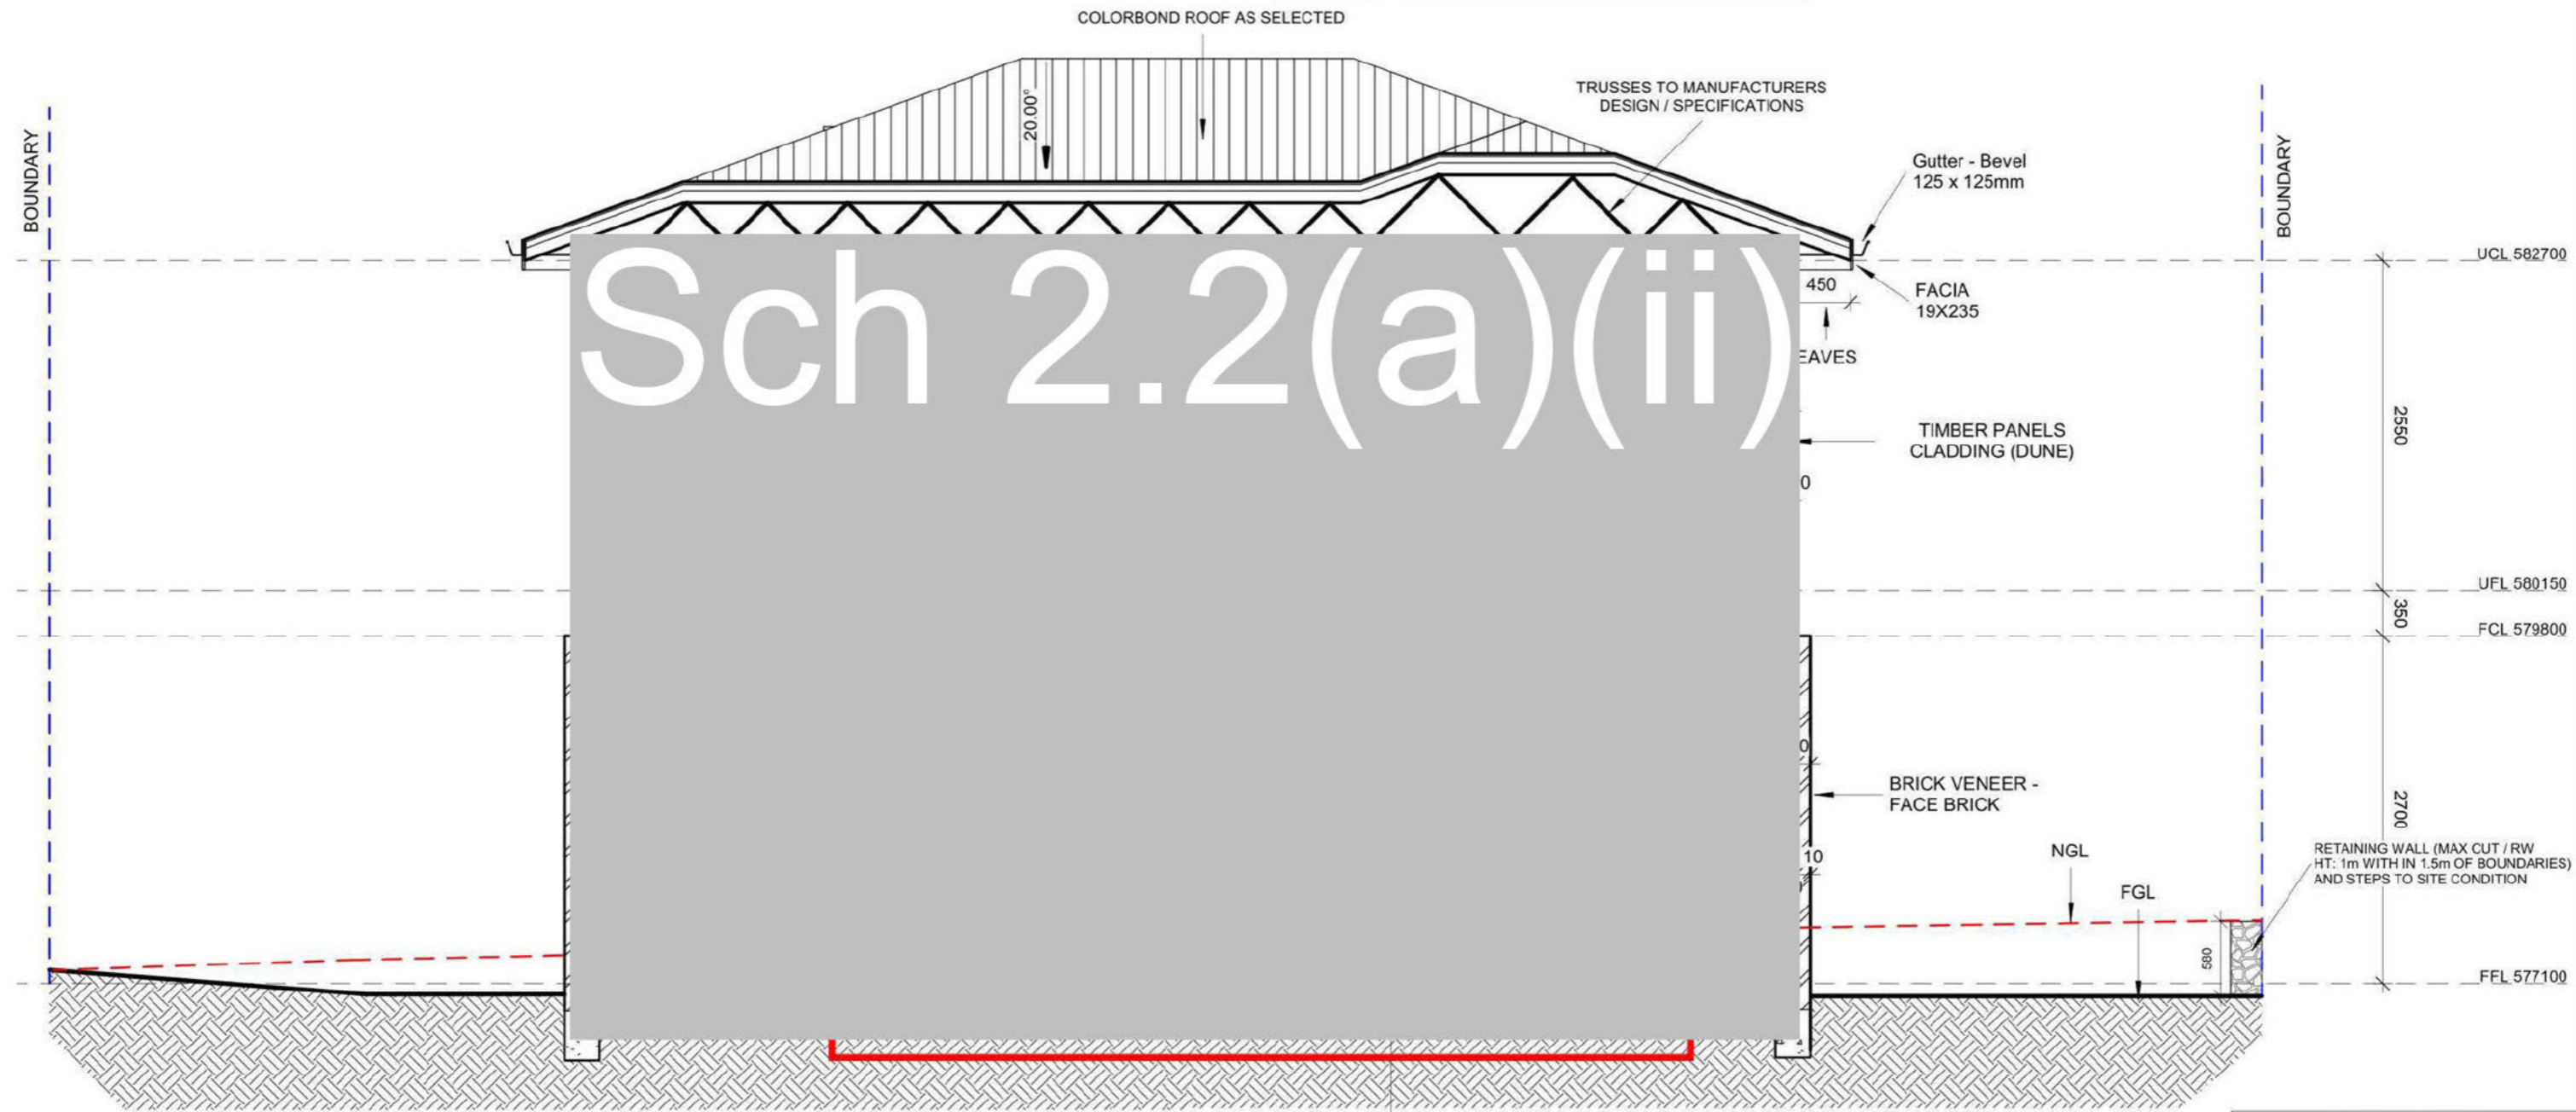

1 Section A
 1 : 50

NOISE AFFECTED BLOCK - TO COMPLY WITH:
 * AS/NZS 2107:2000 - Acoustics - Recommended design sound levels and reverberation times for building interiors (the relevant satisfactory recommended interior design sound level)
 * AS/NZS 3671 - Acoustics - Road Traffic Noise Intrusion Building Siting and Design and Ginninderry Noise Management Plan

WAFLE POD SLAB TO ENGINEER'S DESIGN

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Sch 2.2(a)(ii)
RESIDENCE
 SUBURB: STRATHNAIRN

SECTION A		FOR APPROVAL	
Project number	211201	A400	
Date	6/3/22		
Drawn by	B.Virk		
Checked by	Client		
Scale		1 : 50 on A3	

6/03/2022 4:49:28 PM

Small water meter installation guide

Application Number
200963

Sheet

7 of 7

Introduction

This guide sets out the minimum requirements that apply for new 20mm meter installations in the ACT.

These minimum requirements include:

- Ensure meter is on correct block and section.
- The water meter must be installed within 14 days of collection from Icon Water.
- Meters and services must not be installed in drive ways, retaining walls or footpaths (unless approval has been obtained from Icon Water - Development Services).
- Pressure reducing valves (PRV) must not be installed in the meter box.
- Risers installed upstream and downstream of the meter must be copper.
- Clearance requirements for the meter and meter box are provided in the diagram below.

Please refer to Icon Water standards for further details:

iconwater.com.au/Developers-and-Renovators/Water-and-Sewerage-Service-Standards-and-Guidelines

Failed installations

Make sure the following does not occur when installing the meter.

All newly installed meters will be inspected by Icon Water.



Incorrect box level



Incorrect meter height



No copper risers



PRV in box



In driveway (unapproved)



No clearance for Ball valve

DN20 meter installation

This diagram shows the minimum required clearances for new meter installations.

Please check the following installation requirements.

Clearance between ball valve handle (in fully open or closed position) and meter box – 25mm minimum

No PRV in the box

Copper risers up and down stream (min 300 mm)

Top of meter box to be: flush with grass or paved area, or 50-100mm above garden beds.

Clearance from centre of pipe to bottom of lid – 170 min – 240mm max

Provide 1m clearance around the meter box to enable Icon Water access for reading and maintenance

